

## **5. LEGISLATIVE REQUIREMENTS**

### **5.1 PLANNING AND ENVIRONMENT ACT 1987 (THE ACT)**

The *Planning and Environment Act 1987* is the relevant legislation governing planning in Victoria. The Act identifies subordinate legislation in the form of Planning Schemes to guide future land use and development

Section 60 of the *Planning and Environment Act*, requires the Responsible Authority to consider the following before deciding on an application:

- *The relevant planning scheme;*
- *The objectives of planning in Victoria;*
- *All objections and other submissions which it has received;*
- *Any decision and comments of a referral authority which it has received; and*
- *Any significant effects which the responsible authority considers the use or development may have on the environment or which the responsible authority considers the environment may have on the use or development.*

Section 61(4) of the Act makes specific reference to covenants. Under Section 61(4) of the Planning & Environment Act 1987 the Responsible Authority must not issue a planning permit that would result in a breach of a registered restrictive covenant.

### **5.2 MANNINGHAM PLANNING SCHEME**

**Clauses of the Manningham Planning Scheme the Responsible Authority must consider:**

- Planning Policy Framework
- Local Planning Policy Framework
- Clause 32.07 Residential Growth Zone, Schedule 2 (RGZ2)
- Clause 43.02 Design and Development Overlay, Schedule 8 (DDO8-1)
- Clause 52.06 Car Parking
- Clause 52.29 Land Adjacent to a Road Zone Category 1 or a Public Acquisition Overlay for a Category 1 Road
- Clause 52.34 Bicycle Facilities
- Clause 55 Two or More Dwellings on a Lot and Residential Buildings
- Clause 65 Decision Guidelines

#### **Zone**

##### Clause 32.07 Residential Growth Zone, Schedule 2

The purpose of the Zone is:

- *To implement the State Planning Policy Framework and the Local Planning Policy Framework, including the Municipal Strategic Statement and local planning policies.*
- *To provide housing at increased densities in buildings up to and including four storey buildings.*
- *To encourage a diversity of housing types in locations offering good access to services and transport including activities areas.*
- *To encourage a scale of development that provides a transition between areas of more intensive use and development and areas of restricted housing growth.*
- *To ensure residential development achieves design objectives specified in a schedule to this zone.*

- *To allow educational, recreational, religious, community and a limited range of other non-residential uses to serve local community needs in appropriate locations.*

A Planning Permit is required to construct a residential building. An apartment development of less than five storeys, excluding a basement, must meet the requirements of Clause 55.

Schedule 2 pertains to Residential Areas along Main Roads and does not have a maximum building height specified which differs from the Residential Growth Zone. The Residential Growth Zone specifies that:

- *If no maximum building height is specified in a schedule to this zone, the building height should not exceed 13.5 metres; and*
- *A building may exceed the maximum building height by up to 1 metre if the slope of the natural ground level, measured at any cross section of the site of the building wider than 8 metres, is greater than 2.5 degrees.*

## **Overlays**

### Clause 43.02 Design and Development Overlay, Schedule 8 (DDO8-1)

The design objectives are as follows:

- *To increase residential densities and provide a range of housing types around activity centres and along main roads.*
- *To encourage development that is contemporary in design that includes an articulated built form and incorporates a range of visually interesting building materials and façade treatments.*
- *To support three storey, ‘apartment style’, developments within the Main Road sub-precinct and in sub-precinct A, where the minimum land size can be achieved.*
- *To ensure new development is well articulated and upper storey elements are not unduly bulky or visually intrusive, taking into account the preferred neighbourhood character.*
- *To encourage spacing between developments to minimise a continuous building line when viewed from a street.*
- *To ensure the design and siting of dwellings have regard to the future development opportunities and future amenity of adjoining properties.*
- *To ensure developments of two or more storeys are sufficiently stepped down at the perimeter of the Main Road sub-precinct to provide an appropriate and attractive interface to sub-precinct A or B, or other adjoining zone.*
- *To ensure overlooking into adjoining properties is minimised.*
- *To ensure the design of carports and garages complement the design of the building.*
- *To ensure the design of basement and undercroft car parks complement the design of the building, eliminates unsightly projections of basement walls above natural ground level and are sited to allow for effective screen planting.*
- *To encourage landscaping around buildings to enhance separation between buildings and soften built form.*

#### **Permit Requirement**

- *A permit is required to construct or carry out works.*
- *A permit is required to construct or extend a front fence within 3 metres of a street, if the fence is associated with 2 or more dwellings on a lot or a residential building.*

#### **Building Height & Setbacks**

- Any building or works must comply with the requirements set out in Table 1 and 2 of this Schedule.

- For the purposes of this Schedule, the Maximum Building Height does not include building services, lift over-runs and roof mounted equipment, including screening devices.
- For the purposes of this Schedule, balconies, terraces, and verandahs may encroach within the Street Setback by a maximum of 2.0m, but must not extend along the width of the building.

**Table 1 to Schedule 8**

<b>Sub-Precinct</b>	<b>Maximum Building Height</b>	<b>Condition regarding minimum land size.</b>	<b>Street Setback</b>
DDO8-1 (Main Road) Sub-precinct	11 metres provided the condition regarding minimum land size is met. If the condition is not met, the maximum height is 9 metres, unless the slope of the natural ground level at any cross section wider than eight metres of the site of the building is 2.5 degrees or more, in which case the maximum height must not exceed 10 metres.	1,800 square metres must be all in the same sub-precinct. Where the land comprises more than one lot, the lots must be consecutive lots which are side by side and have a shared frontage.	<p>For one dwelling on a lot:</p> <ul style="list-style-type: none"> <li>▪ Minimum front street setback is the distance specified in Clause 54.03-1 or 6 metres, whichever is the lesser.</li> <li>▪ Minimum side street setback is the distance specified in Clause 54.03-1.</li> </ul> <p>For two or more dwellings on a lot or a residential building:</p> <ul style="list-style-type: none"> <li>▪ Minimum front street setback is the distance specified in Clause 55.03-1 or 6 metres, whichever is the lesser.</li> <li>▪ Minimum side street setback is the distance specified in Clause 55.03-1.</li> </ul>

## Planning Policy Framework

### Clause 15.01-1 (Urban Design)

This policy seeks to create urban environments that are safe, healthy, functional and enjoyable and that contribute to a sense of place and cultural identity.

Strategies towards achieving this are identified as follows:

- *Require development to respond to its context in terms of character, cultural identity, natural features, surrounding landscape and climate.*
- *Ensure development contributes to community and cultural life by improving the quality of living and working environments, facilitating accessibility and providing for inclusiveness.*
- *Ensure the interface between the private and public realm protects and enhances personal safety.*
- *Ensure development supports public realm amenity and safe access to walking and cycling environments and public transport.*
- *Ensure that the design and location of publicly accessible private spaces, including car parking areas, forecourts and walkways, is of a high standard, creates a safe environment for users and enables easy and efficient use.*
- *Ensure that development provides landscaping that supports the amenity, attractiveness and safety of the public realm.*
- *Ensure that development, including signs, minimises detrimental impacts on amenity, on the natural and built environment and on the safety and efficiency of roads.*
- *Promote good urban design along and abutting transport corridors.*

### Clause 15.01-2 (Building Design)

The policy objective is:

- *To achieve building design outcomes that contribute positively to the local context and enhance the public realm.*

The strategies to achieve this requires a comprehensive site analysis prior to the design process, requires developments to respond to strategic and cultural context of its locations, minimise detrimental impact on neighbouring properties and encourages landscaping that enhances the built form and create safe attractive spaces.

### Clause 15.01-4 (Healthy Neighbourhoods)

The policy objective is:

- *To achieve neighbourhoods that foster healthy and active living and community wellbeing.*

Strategies to achieve the objective include designing neighbourhoods that foster community interaction and making it easy for people of all ages to live healthy lifestyles by providing connected, safe and attractive walking and cycling networks, conveniently locating public spaces for active recreation, providing accessibly located public transport stops and streets with direct, safe and convenient access to destinations.

### Clause 15.01-5 (Neighbourhood Character)

The policy objective is:

- *To recognise, support and protect neighbourhood character, cultural identity and sense of place.*

The clause includes several strategies to achieve this objective, including to:

- *Ensure development responds to cultural identity and contributes to existing or preferred neighbourhood character.*
- *Ensure development responds to its context and reinforces a sense of place and the valued features and characteristics of the local environment and place by emphasising the:*
  - *Pattern of local urban structure and subdivision*
  - *Underlying natural landscape character and significant vegetation.*
  - *Heritage values and built form that reflect community identity.*

### Clause 15.02-1 Sustainable Development: Energy and resource efficiency

The policy objective is:

- *To encourage land use and development that is energy and resources efficient, supports a cooler environment and minimises greenhouse gas emissions.*

The clause has the following strategies:

- *Improve the energy, water and waste performance of buildings and subdivisions through environmentally sustainable development.*
- *Promote consolidation of urban development and integration of land use and transport. Improve efficiency in energy use through greater use of renewable energy technologies and other energy efficiency upgrades.*
- *Support low energy forms of transport such as walking and cycling.*
- *Reduce the urban heat island effect by greening urban areas, buildings, transport corridors and open spaces with vegetation.*
- *Encourage retention of existing vegetation and planting of new vegetation as part of development and subdivision proposals.*

### Clause 16.01-1 Integrated housing

The policy objective is:

- *To promote a housing market that meets community needs.*

The clause has the following strategies.

- *Increase the supply of housing in existing urban areas by facilitating increased housing yield in appropriate locations, including under-utilised urban land.*
- *Ensure that the planning system supports the appropriate quantity, quality and type of housing, including the provision of aged care facilities.*
- *Ensure housing developments are integrated with infrastructure and services, whether they are located in existing suburbs, growth areas or regional towns.*
- *Encourage housing that is both water efficient and energy efficient.*

#### Clause 16.01-2 Location of residential development

The policy objective is:

- *To locate new housing in or close to activity centres and employment corridors and at other strategic redevelopment sites that offer good access to services and transport.*

#### Clause 16.01-3 Housing diversity

The policy objective is:

- *To provide for a range of housing types to meet increasingly diverse needs.*

The clause has the following strategies.

- *Ensure housing stock matches changing demand by widening housing choice, particularly in the middle and outer suburbs.*
- *Encourage the development of well-designed medium-density housing which:*
  - *respects the neighbourhood character;*
  - *improves housing choice;*
  - *makes better use of existing infrastructure;*
  - *improves energy efficiency of housing.*
- *Support opportunities for a wide range of income groups to choose housing in well serviced locations.*
- *Ensure planning for growth areas provides for a mix of housing types and higher housing densities in and around activity centres.*

#### Clause 16.01-4 Housing affordability

The policy objective is:

- *To deliver more affordable housing closer to jobs, transport and services.*

#### Clause 18.01-1 Integrated Transport: Land use and transport planning

It is an objective “*to create a safe and sustainable transport system by integrating land-use and transport*”. The clause includes several (relevant) strategies to achieve this objective.

- *Plan urban development to make jobs and community services more accessible by:*
  - *ensuring access is provided to developments in accordance with forecast demand, taking advantage of all available modes of transport and to minimise adverse impacts on existing transport networks and the amenity of surrounding areas;*
  - *concentrating key trip generators such as higher density residential development in and around Central Activities Districts, Principal, Major and Specialised Activity Centres on the Principal Public Transport Network;*

#### Clause 18.02-1 Movement networks: Sustainable personal transport

It is an objective “*to promote the use of sustainable personal transport*”. The clause includes several (relevant) strategies to achieve this objective.

- *Encourage the use of walking and cycling by creating environments that are safe and attractive.*
- *Develop high quality pedestrian environments that are accessible to footpath-bound vehicles such as wheelchairs, prams and scooters.*
- *Ensure development provides opportunities to create more sustainable transport options such as walking, cycling and public transport.*

#### Clause 18.02-4 Car parking

It is an objective “*to ensure an adequate supply of car parking that is appropriately designed and located*”. The clause includes the following (relevant) strategies to achieve this objective.

- *Encourage the efficient provision of car parking through the consolidation of car parking facilities.*
- *Protect the amenity of residential precincts from the effects of road congestion created by on-street parking.*

### **Local Planning Policy Framework (LPPF) Municipal Strategic Statement**

#### Clause 21.03 Key Influences

This clause identifies that future housing need and residential amenity are critical land-use issues that will challenge Manningham’s future growth and sustainable development. The MSS acknowledges that there is a general trend towards smaller household size as a result of an aging population and smaller family structure which will lead to an imbalance between the housing needs of the population and the actual housing stock that is available.

This increasing pressure for re-development raises issues about how these changes affect the character and amenity of our local neighbourhoods. In meeting future housing needs, the challenge is to provide for residential re-development in appropriate locations, to reduce pressure for development in more sensitive areas, and in a manner that respects the residential character and amenity valued by existing residents.

#### Clause 21.05 Residential

This policy applies to development in the Residential Growth Zone, Schedule 2. It outlines that infill residential development and redevelopment of key strategic sites that consolidates the role of established urban areas and reduces developmental pressure in the areas with environmental values will be encouraged.

It recognises that whilst single detached dwellings will continue to represent the largest proportion of Manningham’s housing stock, there will be a need for a greater mix of housing in the form of medium and higher density residential developments. Higher density housing will be encouraged in close proximity to activity centres and along major roads and transport routes.

#### **The site is within Precinct 2 – Residential Areas Surrounding Activity Centres and Along Main Roads.**

A substantial level of change is anticipated in Precinct 2. Whilst this area will be a focus for higher density developments, there are three sub-precincts which each stipulate different height, scale and built form outcomes to provide a transition between each sub-precinct and adjoining properties, primarily in Precinct 1 – Residential Areas Removed from Activity Centres and Main Roads.

The site is located within DDO8-1 – the **Main Road Sub-Precinct**.

**Sub-precinct – Main Road** is an area where three storey (11 metres) ‘apartment style’ developments are encouraged on land with a minimum area of 1,800m<sup>2</sup> (where the land comprises more than one consecutive lots, which are side by side and have a shared frontage). The area of 1,800m<sup>2</sup> must all be in the same sub-precinct. All development in the Main Road sub-precinct should have a maximum site coverage of 60 percent.

Higher developments on the perimeter of the Main Road sub-precinct should be designed so that the height and form are sufficiently stepped down, so that the scale and form complement the interface of sub-precinct A or B, or other adjoining zone.

Development in Precinct 2 should:

- *Provide for contemporary architecture*
- *Achieve high design standards*
- *Provide visual interest and make a positive contribution to the streetscape*
- *Provide a graduated building line from side and rear boundaries*
- *Minimise adverse amenity impacts on adjoining properties*
- *Use varied and durable building materials*
- *Incorporate a landscape treatment that enhances the overall appearance of the development.*
- *Integrate car parking requirements into the design of buildings and landform.*

#### Clause 21.05-2 Housing

The relevant objectives of this policy are:

- *To accommodate Manningham’s projected population growth.*
- *To ensure that housing choice, quality and diversity will be increased to better meet the needs of the local community and reflect demographic changes.*
- *To ensure that areas removed from activity centres and main roads as well as areas with predominant landscape features are protected from higher density development.*
- *To promote affordable and accessible housing to enable residents with changing needs to stay within their local neighbourhood or the municipality.*

The strategies to achieve these objectives include:

- *Encourage the provision of housing stock which responds to the needs of the municipality’s population.*
- *Promote the consolidation of lots to provide for a diversity of housing types and design options.*
- *Allow housing development that respects existing neighbourhood character and supports incremental level of change in areas removed from activity centres and main roads identified as Precinct 1 on the Residential Framework Plan 1 and Map 1 to this clause.*
- *Encourage development to be designed to respond to the needs of people with limited mobility, which may for example, incorporate lifts into three storey developments.*

#### Clause 21.10 Environmentally Sustainable Development

This policy highlights Council’s commitment to ESD and outlines a number of ESD principles to which regard must be given. These include building energy management, water sensitive design, external environmental amenity, waste management, quality of public and private realm, transport and urban ecology.

## Clause 22.08 Safety Through Urban Design Policy

The objectives of this policy are:

- *To provide and maintain a safer physical environment for those who live in, work in or visit the City of Manningham.*
- *To minimise opportunities for crime, through well designed and well maintained buildings and spaces.*
- *To encourage the use of public spaces.*
- *To improve accessibility by creating attractive, vibrant, walkable environments.*
- *To discourage graffiti and vandalism.*

## Clause 22.09 Access for Disabled People Policy

The objectives of this policy are:

- *To facilitate the integration of people with a disability into the community.*
- *To ensure that people with a disability have the same level of access to buildings, services and facilities as any other person.*

## **Particular Provisions**

### Clause 52.06 Car Parking

Pursuant to Clause 52.06-5, car parking is required to be provided at the following rate:

- *1 space for 1 and 2 bedroom dwellings.*
- *2 spaces for 3 or more bedroom dwellings.*
- *1 visitor space to every 5 dwellings for developments of 5 or more dwellings (also the visitor car space requirement for Higher Density areas under the DP).*

### Clause 52.29 Land Adjacent to a Road Zone Category 1 or a Public Acquisition Overlay for a Category 1 Road

A permit is required to create or alter access to a road in a Road Zone, Category 1 (RDZ1).

### Clause 52.34 Bicycle Facilities

A development of more than 4 stories attracts a bicycle spaces requirement of 1 residential space per 5 residential dwellings and 1 visitor space per 10 residential dwellings.

## **General Provisions**

### Clause 65 Decision Guidelines

This clause outlines that before deciding on an application, the responsible authority must consider, as appropriate:

- *The matters set out in section 60 of the Act.*
- *The Municipal Planning Strategy and the Planning Policy Framework.*
- *The purpose of the zone, overlay or other provision.*
- *Any matter required to be considered in the zone, overlay or other provision.*
- *The orderly planning of the area.*
- *The effect on the amenity of the area.*
- *The proximity of the land to any public land.*
- *Factors likely to cause or contribute to land degradation, salinity or reduce water quality.*

- *Whether the proposed development is designed to maintain or improve the quality of stormwater within and exiting the site.*
- *The extent and character of native vegetation and the likelihood of its destruction.*
- *Whether native vegetation is to be or can be protected, planted or allowed to regenerate.*

# PROPOSED APARTMENT BUILDING DEVELOPMENT

## PROJECT: 969-973 DONCASTER ROAD, DONCASTER EAST



**FLOOR PLATE AREAS**  
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### DEVELOPMENT SUMMARY

#### APARTMENT 1

GROUND FLOOR :87.31sqm, 8.93sqm, 0.86sqm  
P.O.S :16.96sqm, 1.82sqm

#### APARTMENT 2

GROUND FLOOR :80.45sqm, 8.65sqm  
P.O.S :23.02sqm, 2.47sqm

#### APARTMENT 3

GROUND FLOOR :76.12sqm, 8.19sqm  
P.O.S :21.82sqm, 2.34sqm

#### APARTMENT 4

GROUND FLOOR :77.24sqm, 8.31sqm  
P.O.S :15.53sqm, 1.67sqm

#### APARTMENT 5

GROUND FLOOR :88.42sqm, 9.51sqm  
BALCONY :8.08sqm, 0.86sqm

#### APARTMENT 6

GROUND FLOOR :74.57sqm, 8.02sqm  
BALCONY :15.29sqm, 1.64sqm  
POS :18.79sqm, 2.02sqm

#### APARTMENT 7

GROUND FLOOR :79.52sqm, 8.55sqm  
BALCONY :15.41sqm, 1.65sqm  
POS :25.39sqm, 2.73sqm

#### APARTMENT 8

GROUND FLOOR :75.16sqm, 8.09sqm  
BALCONY :8.94sqm, 0.96sqm  
POS :24.32sqm, 2.61sqm

#### APARTMENT 9

GROUND FLOOR :79.45sqm, 8.55sqm  
BALCONY :8.00sqm, 0.86sqm  
POS :17.73sqm, 1.90sqm

#### APARTMENT 10

GROUND FLOOR :74.73sqm, 8.04sqm  
BALCONY :16.49sqm, 1.77sqm  
POS :34.80sqm, 3.74sqm

#### APARTMENT 11

GROUND FLOOR :104.17sqm, 11.21sqm  
BALCONY :9.66sqm, 1.03sqm

#### APARTMENT 12

GROUND FLOOR :83.20sqm, 8.95sqm  
BALCONY :10.35sqm, 1.11sqm

#### APARTMENT 13

GROUND FLOOR :79.06sqm, 8.51sqm  
BALCONY :11.96sqm, 1.28sqm

#### APARTMENT 14

GROUND FLOOR :75.06sqm, 8.07sqm  
BALCONY :11.43sqm, 1.23sqm

#### APARTMENT 15

GROUND FLOOR :73.14sqm, 7.87sqm  
BALCONY :8.92sqm, 0.96sqm

#### APARTMENT 16

GROUND FLOOR :88.42sqm, 9.51sqm  
BALCONY :8.08sqm, 0.86sqm

#### APARTMENT 17

GROUND FLOOR :85.59sqm, 9.21sqm  
BALCONY :8.46sqm, 0.91sqm

#### APARTMENT 18

GROUND FLOOR :55.32sqm, 5.95sqm  
BALCONY :8.00sqm, 0.86sqm

#### APARTMENT 19

GROUND FLOOR :75.16sqm, 8.09sqm  
BALCONY :8.94sqm, 0.96sqm

#### APARTMENT 20

GROUND FLOOR PLAN :1,458.39sqm

BALCONY :8.00sqm, 0.86sqm

GROUND FLOOR PLAN :1,217.84sqm

FIRST FLOOR PLAN :1,124.24sqm

SECOND FLOOR PLAN :959.75sqm

THIRD FLOOR PLAN :388.00sqm

SITE AREA : 2049.75sqm

SITE COVERAGE : 59.53%

HARD SURFACE AREA : 69.47%

PERMEABILITY AREA : 30.53%

TOTAL CAR SPACES : 43

VISITOR CAR SPACES : 7

BEDROOMS:	
APARTMENT 1:	2 BED
APARTMENT 2:	2 BED
APARTMENT 3:	2 BED
APARTMENT 4:	2 BED
APARTMENT 5:	2 BED
APARTMENT 6:	2 BED
APARTMENT 7:	2 BED
APARTMENT 8:	2 BED
APARTMENT 9:	2 BED
APARTMENT 10:	2 BED
APARTMENT 11:	2 BED
APARTMENT 12:	2 BED
APARTMENT 13:	2 BED
APARTMENT 14:	2 BED
APARTMENT 15:	2 BED
APARTMENT 16:	2 BED
APARTMENT 17:	2 BED
APARTMENT 18:	1 BED
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APARTMENT 25:	1 BED
APARTMENT 26:	2 BED
APARTMENT 27:	2 BED
APARTMENT 28:	1 BED
APARTMENT 29:	1 BED
APARTMENT 30:	1 BED
APARTMENT 31:	2 BED
APARTMENT 32:	2 BED
APARTMENT 33:	2 BED
APARTMENT 34:	2 BED
APARTMENT 35:	3 BED



E.J. Grech & Associates Pty Ltd

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Fax - 9894 4425

DATE: AMENDMENT:  
20/12/19 AMENDED FLOOR PLANS

22/04/20 COUNCIL RFI

PROJECT:  
PROPOSED APARTMENT DEVELOPMENT  
AT: No. 969–973,  
DONCASTER ROAD,  
DONCASTER EAST

FOR : ZHOU PROJECT

MELWAY REF: MAP

DATE: APRIL 20 SCALE: 1:100

SHEET: 1 OF 25

REFERENCE NO:



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1659-2

ADVERTISED PLANS

Planning Application Number: PLN19/0226  
Date: 11 May 2020  
Sheet 2 of 25


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PICKET ON RENDER H2

TELECOM PIT

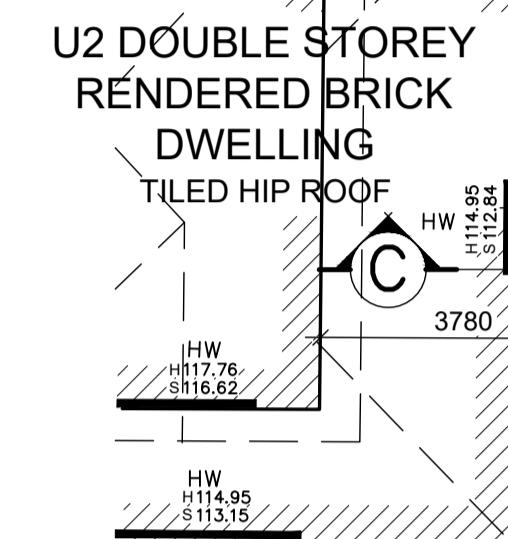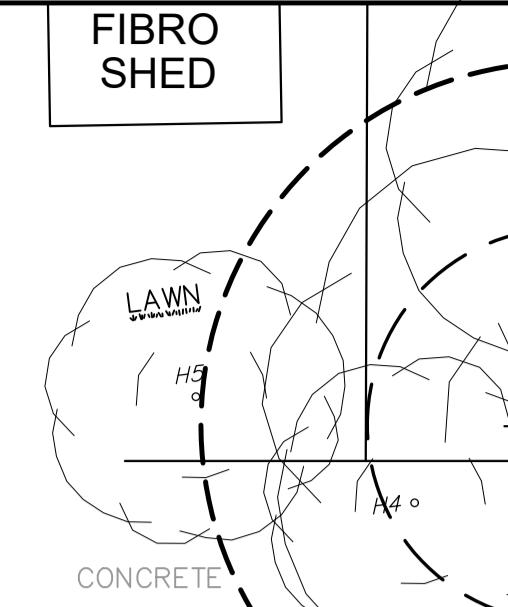H113.0



# SITE AND GROUND FLOOR PLAN

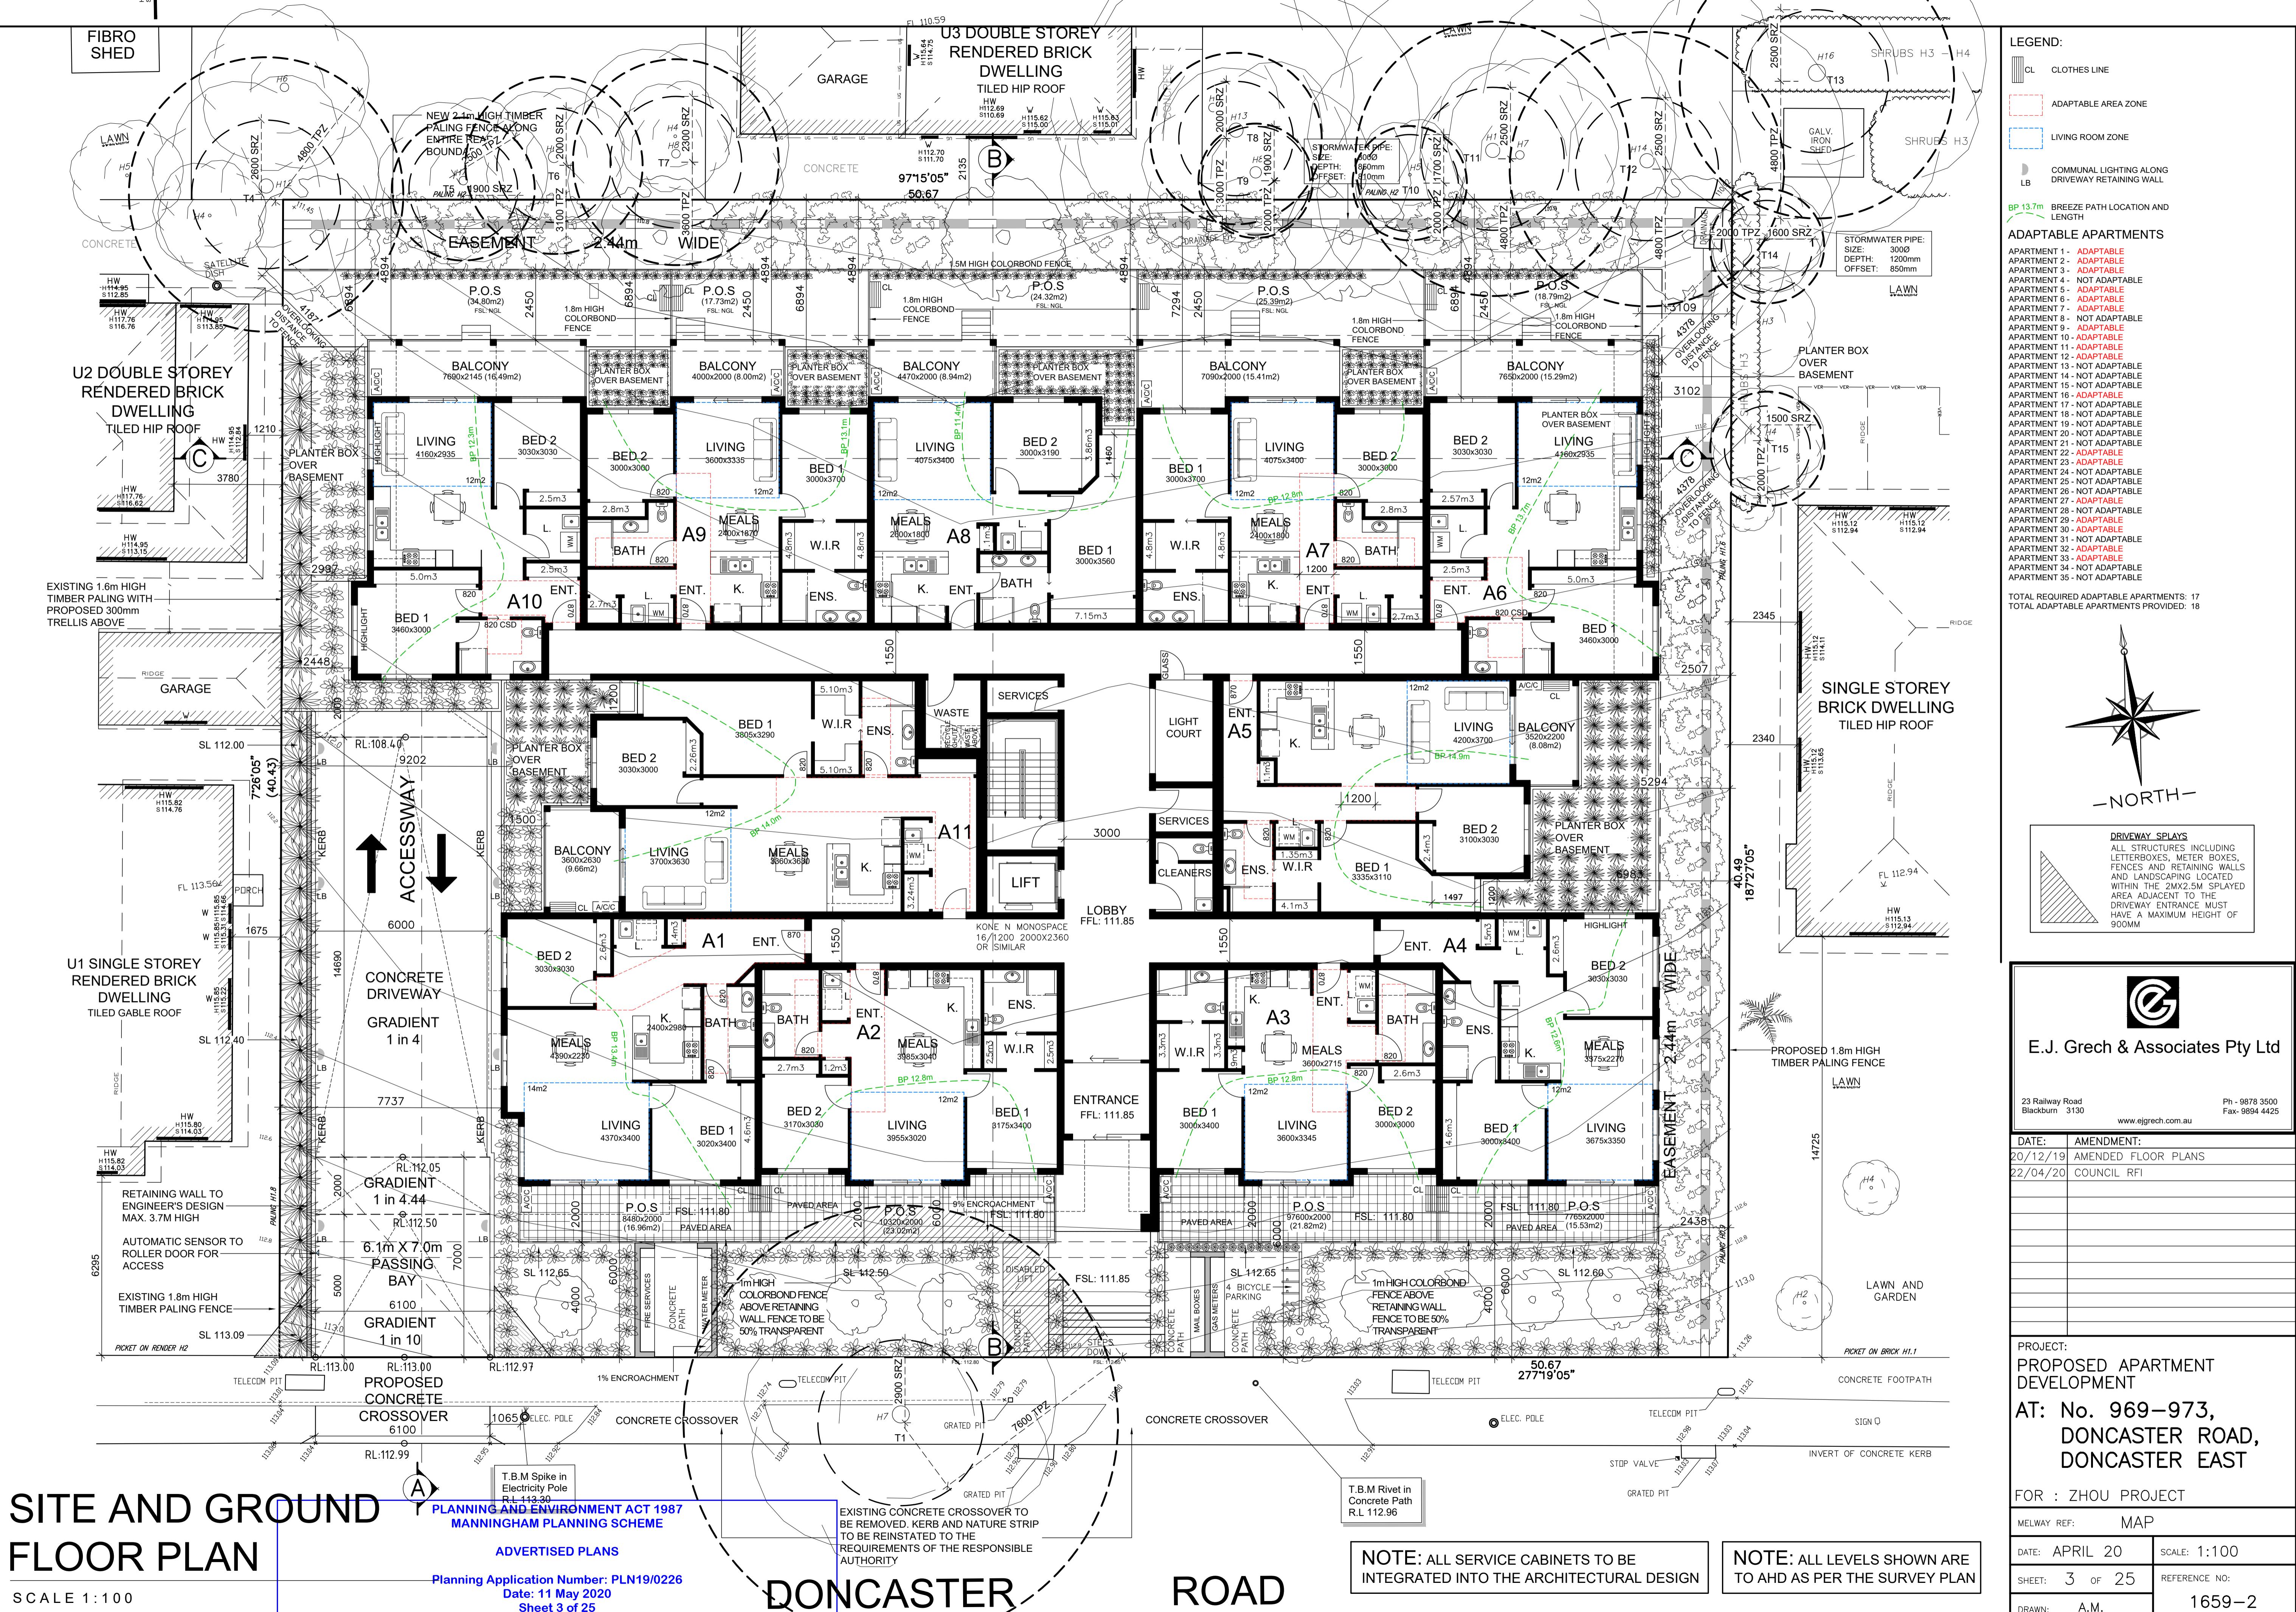R.L.113.30  
**PLANNING AND ENVIRONMENT ACT 1993  
MANNINGHAM PLANNING SCHEME**

ADVERTISED PLANS

**Planning Application Number: PLN19/022  
Date: 11 May 2020  
Sheet 3 of 25**

# DONCASTER

# ROAD

**NOTE:** ALL SERVICE CABINETS TO BE  
INTEGRATED INTO THE ARCHITECTURAL DESIGN

**NOTE:** ALL LEVELS SHOWN ARE  
TO AHD AS PER THE SURVEY PLAN

PROPOSED APARTMENT  
DEVELOPMENT

AT: No. 969–973,  
DONCASTER ROAD  
DONCASTER EAST

FOR : ZHOU PROJECT

MELWAY REF: MAP

DATE: APRIL 20


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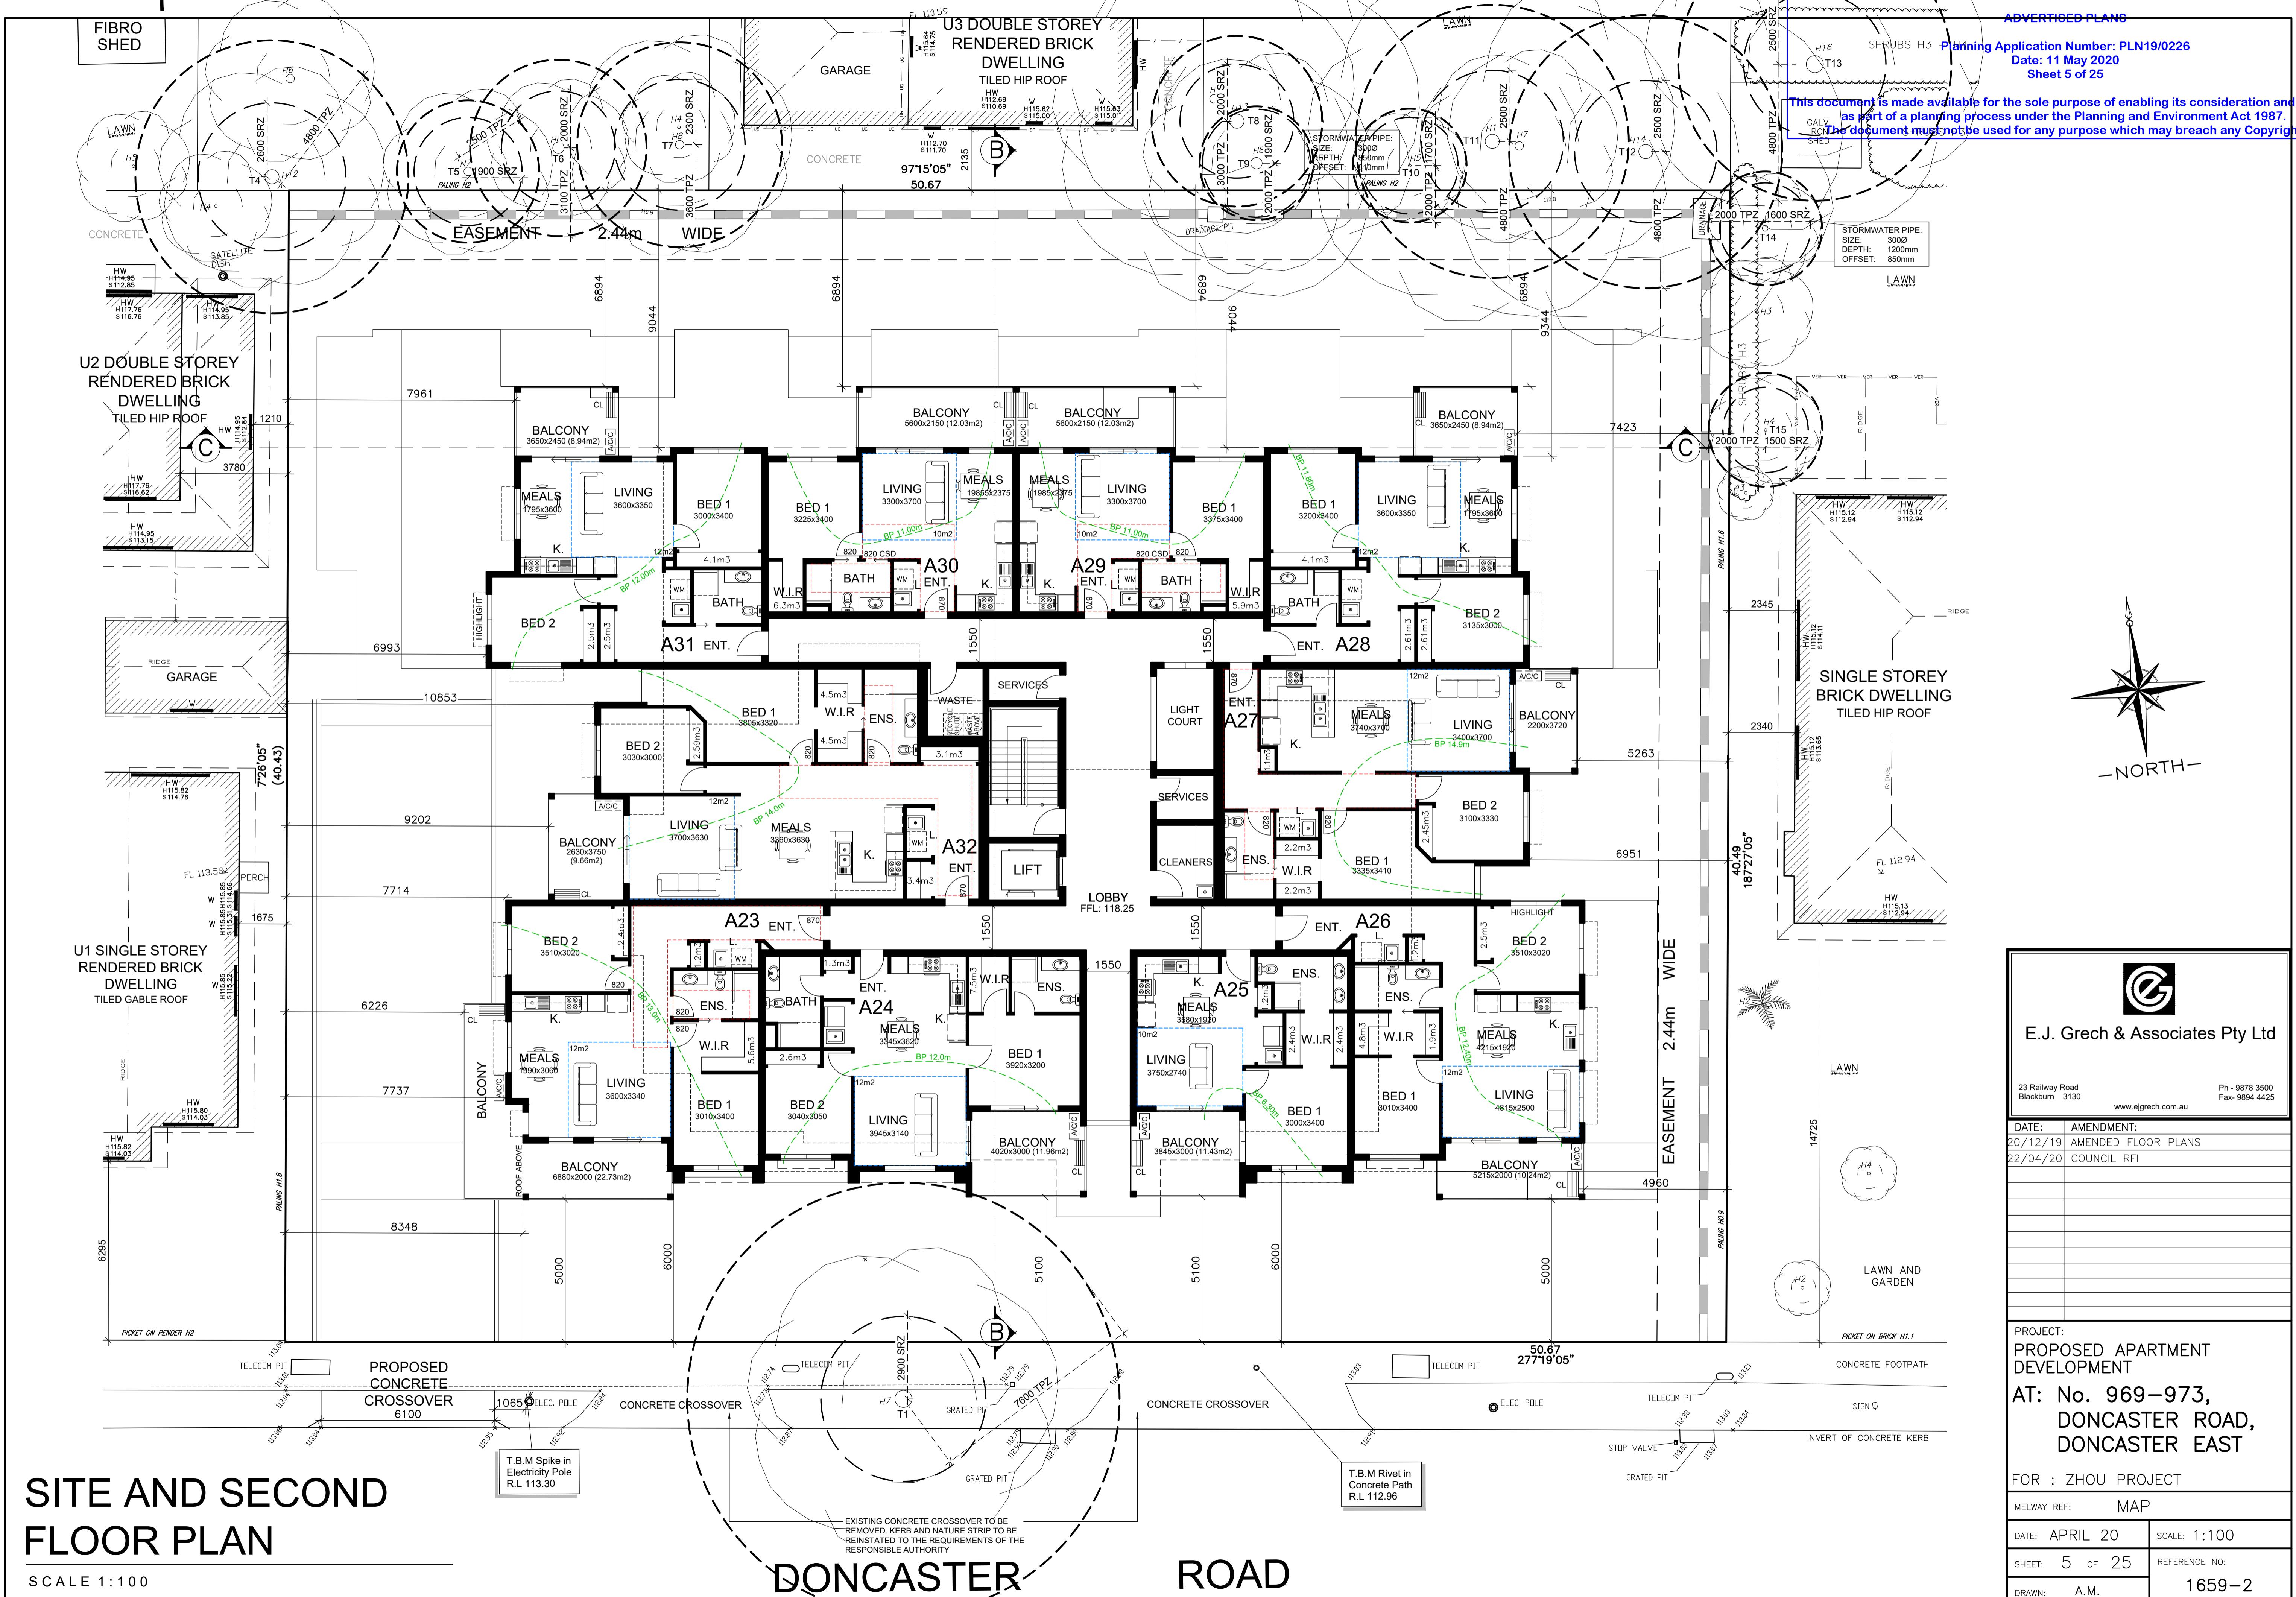
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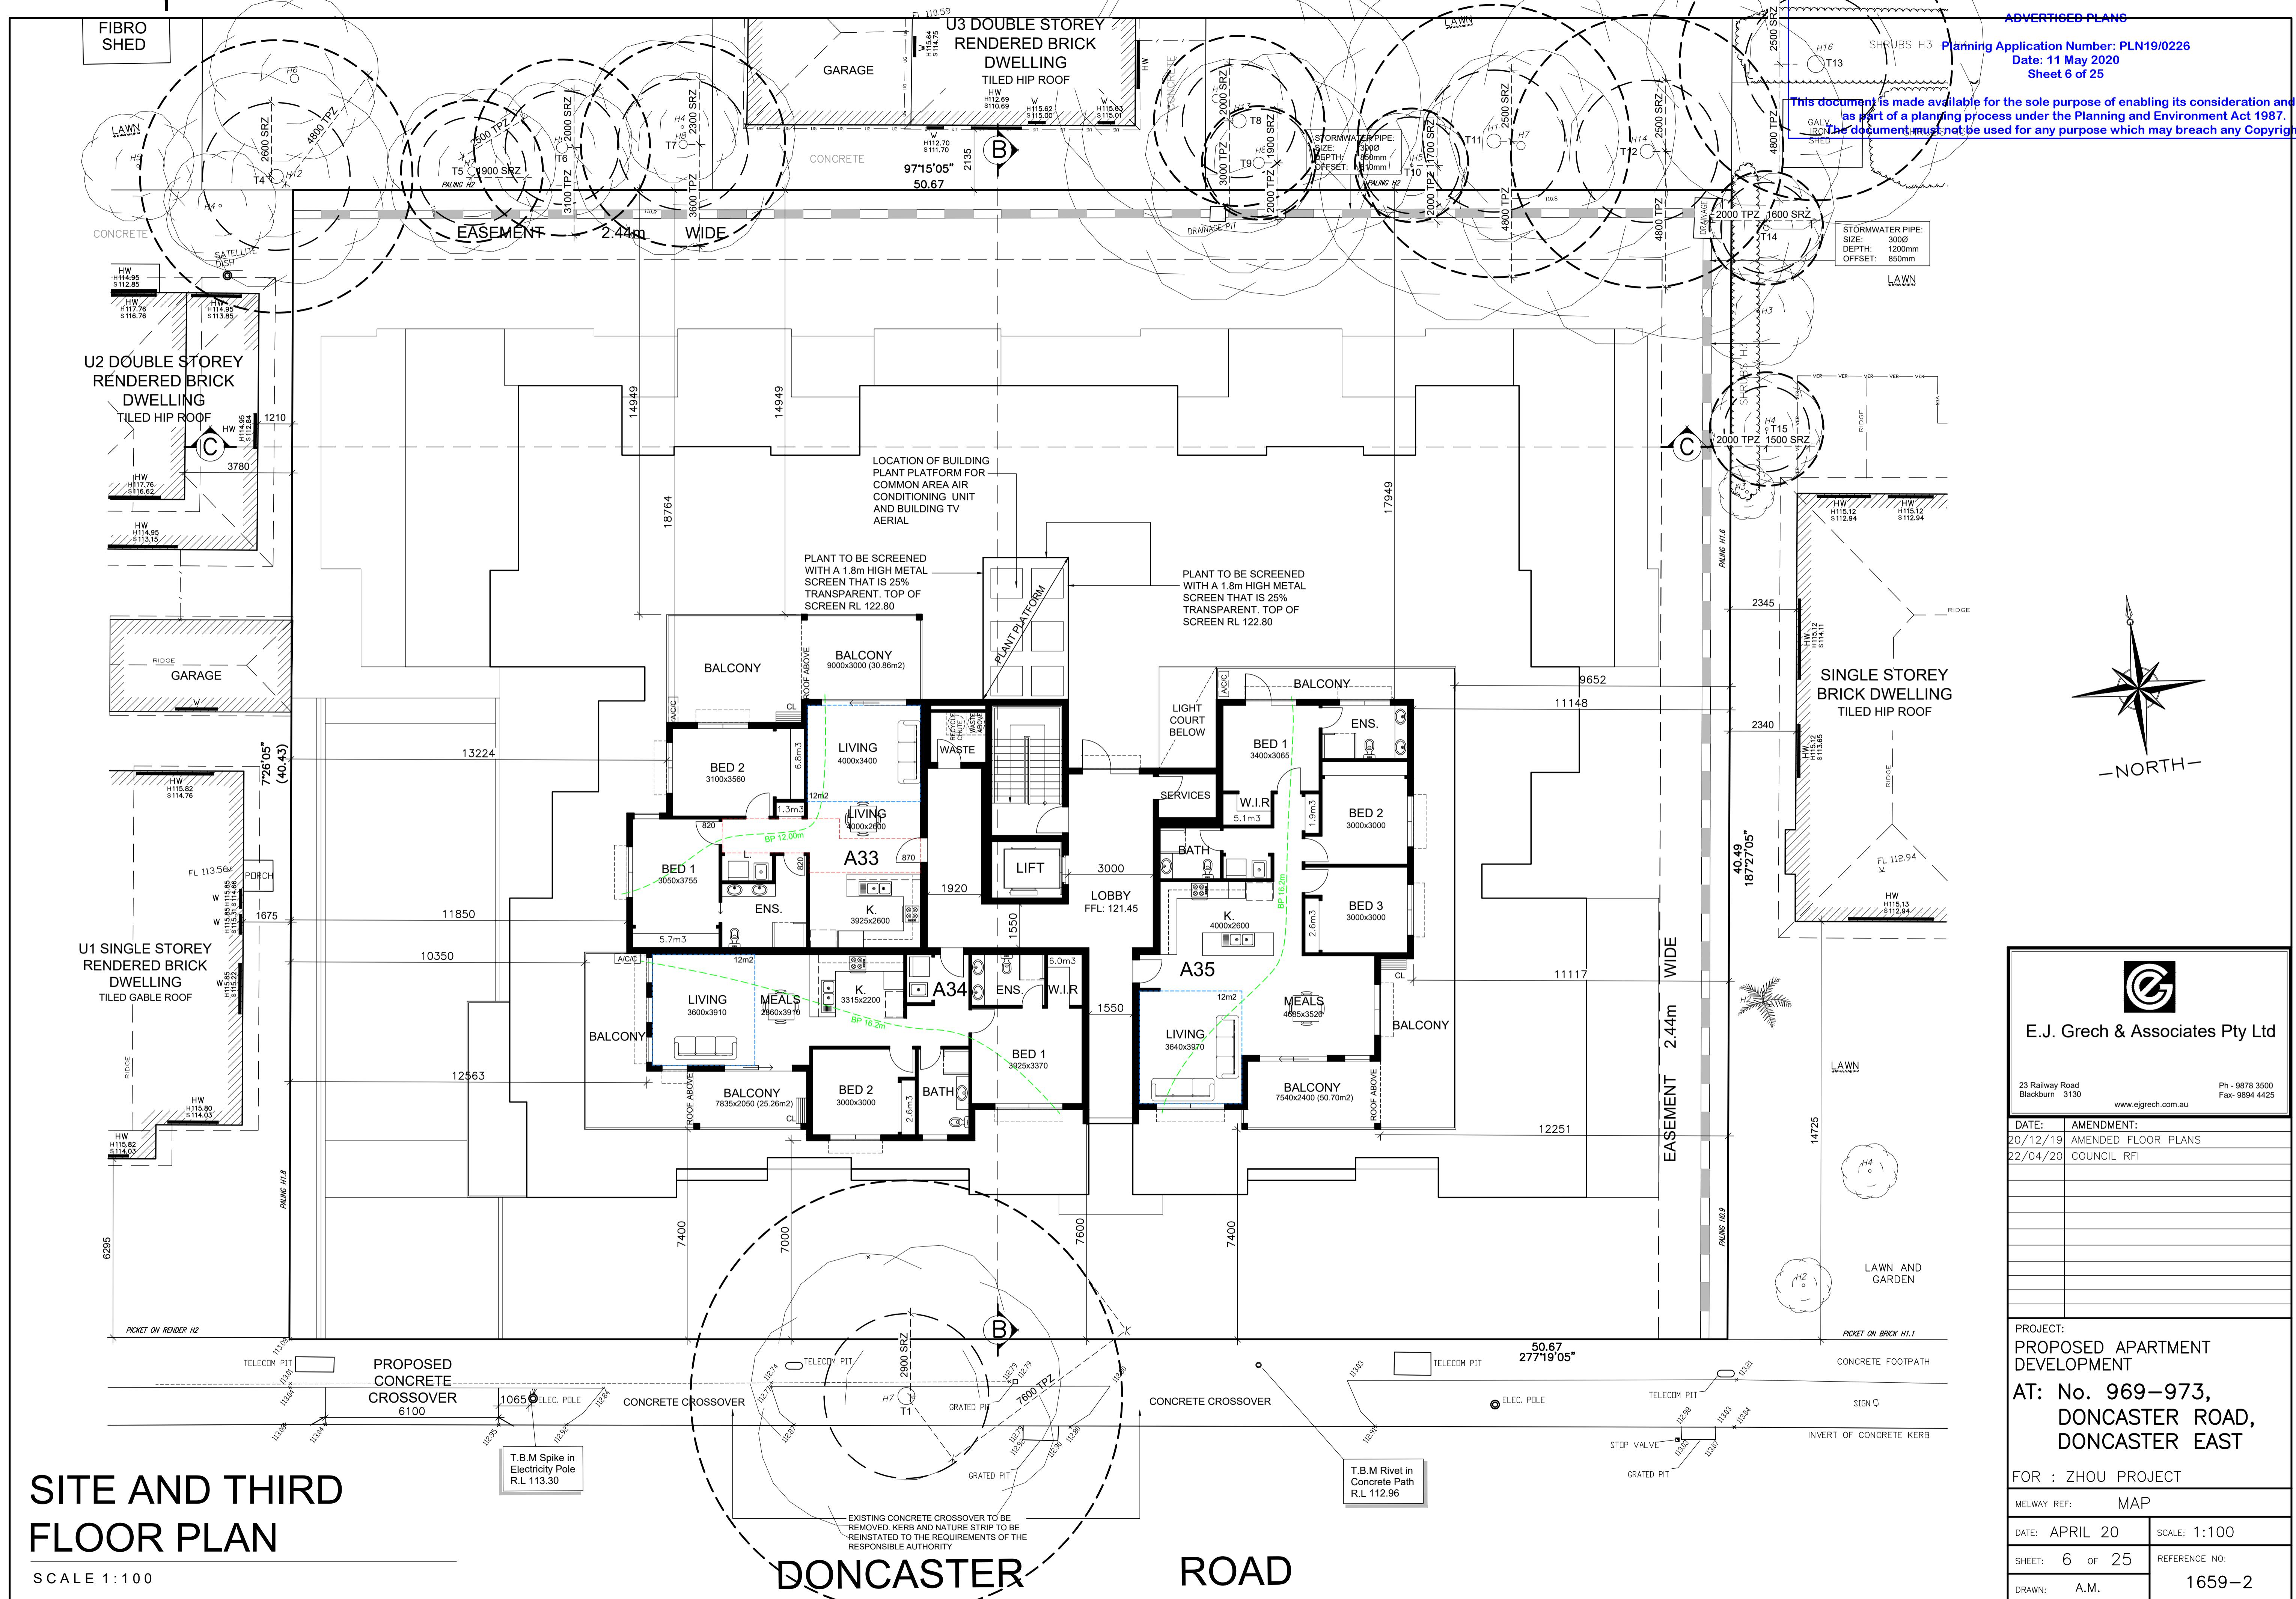
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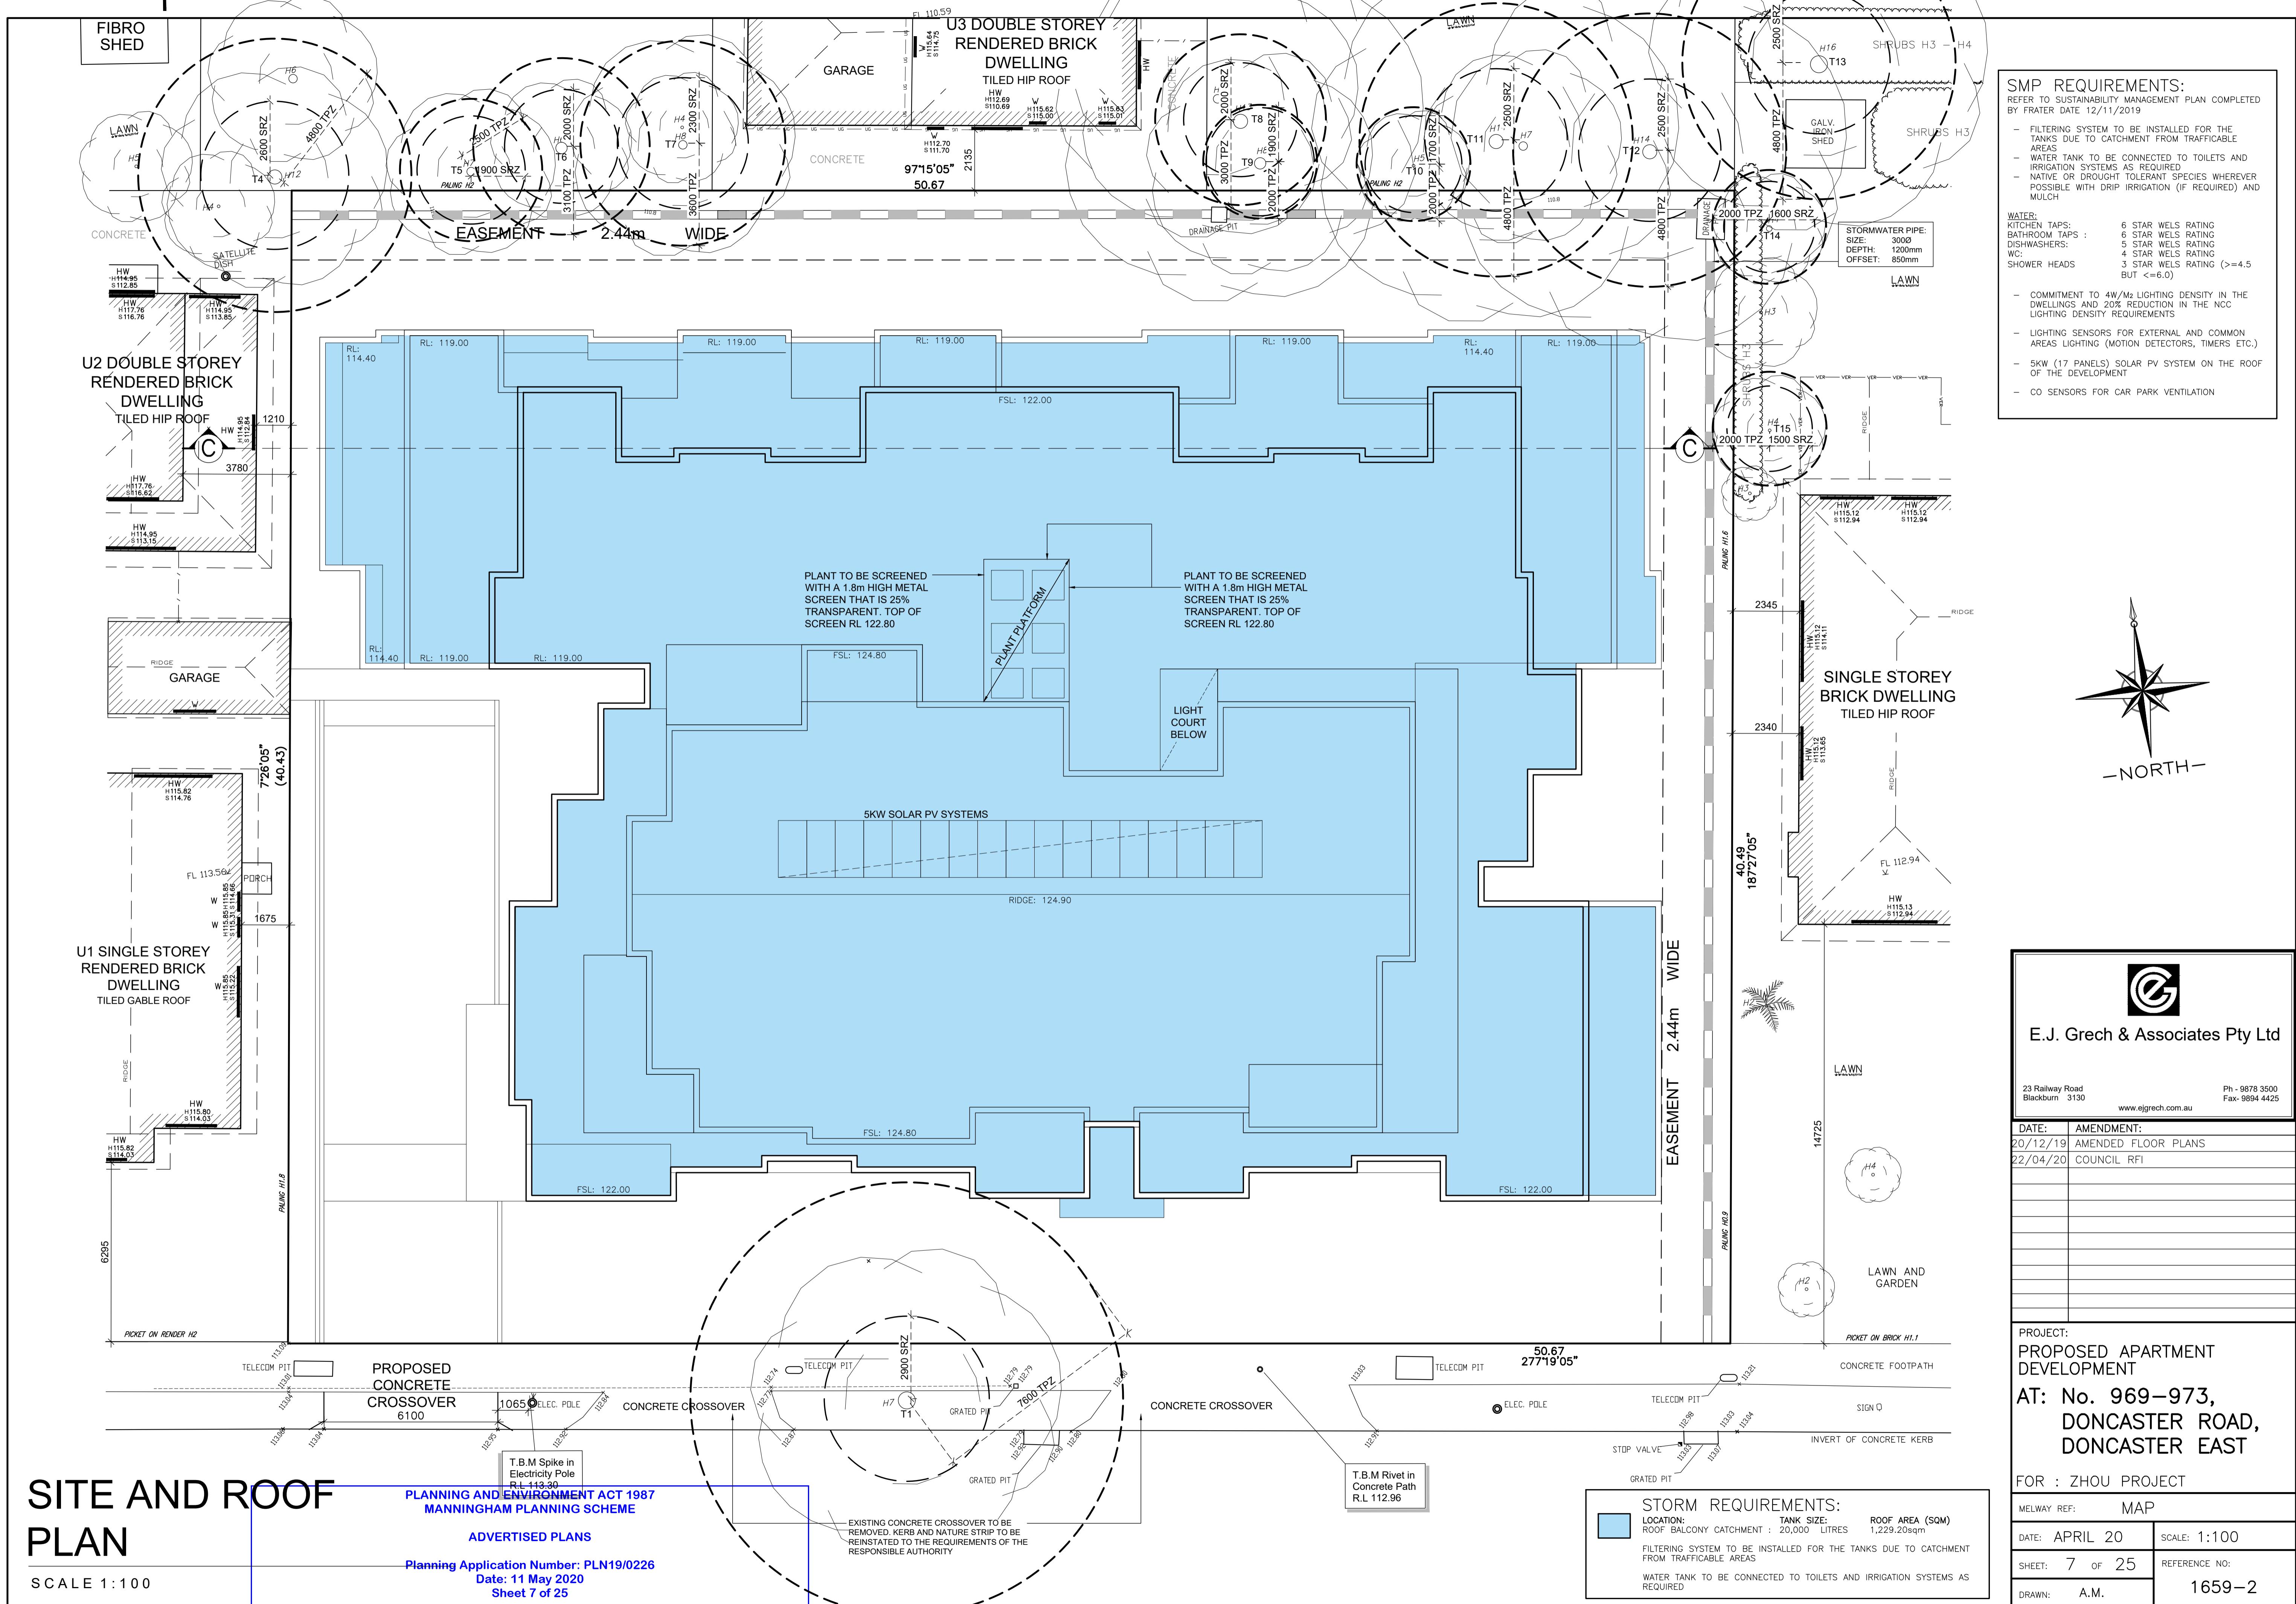


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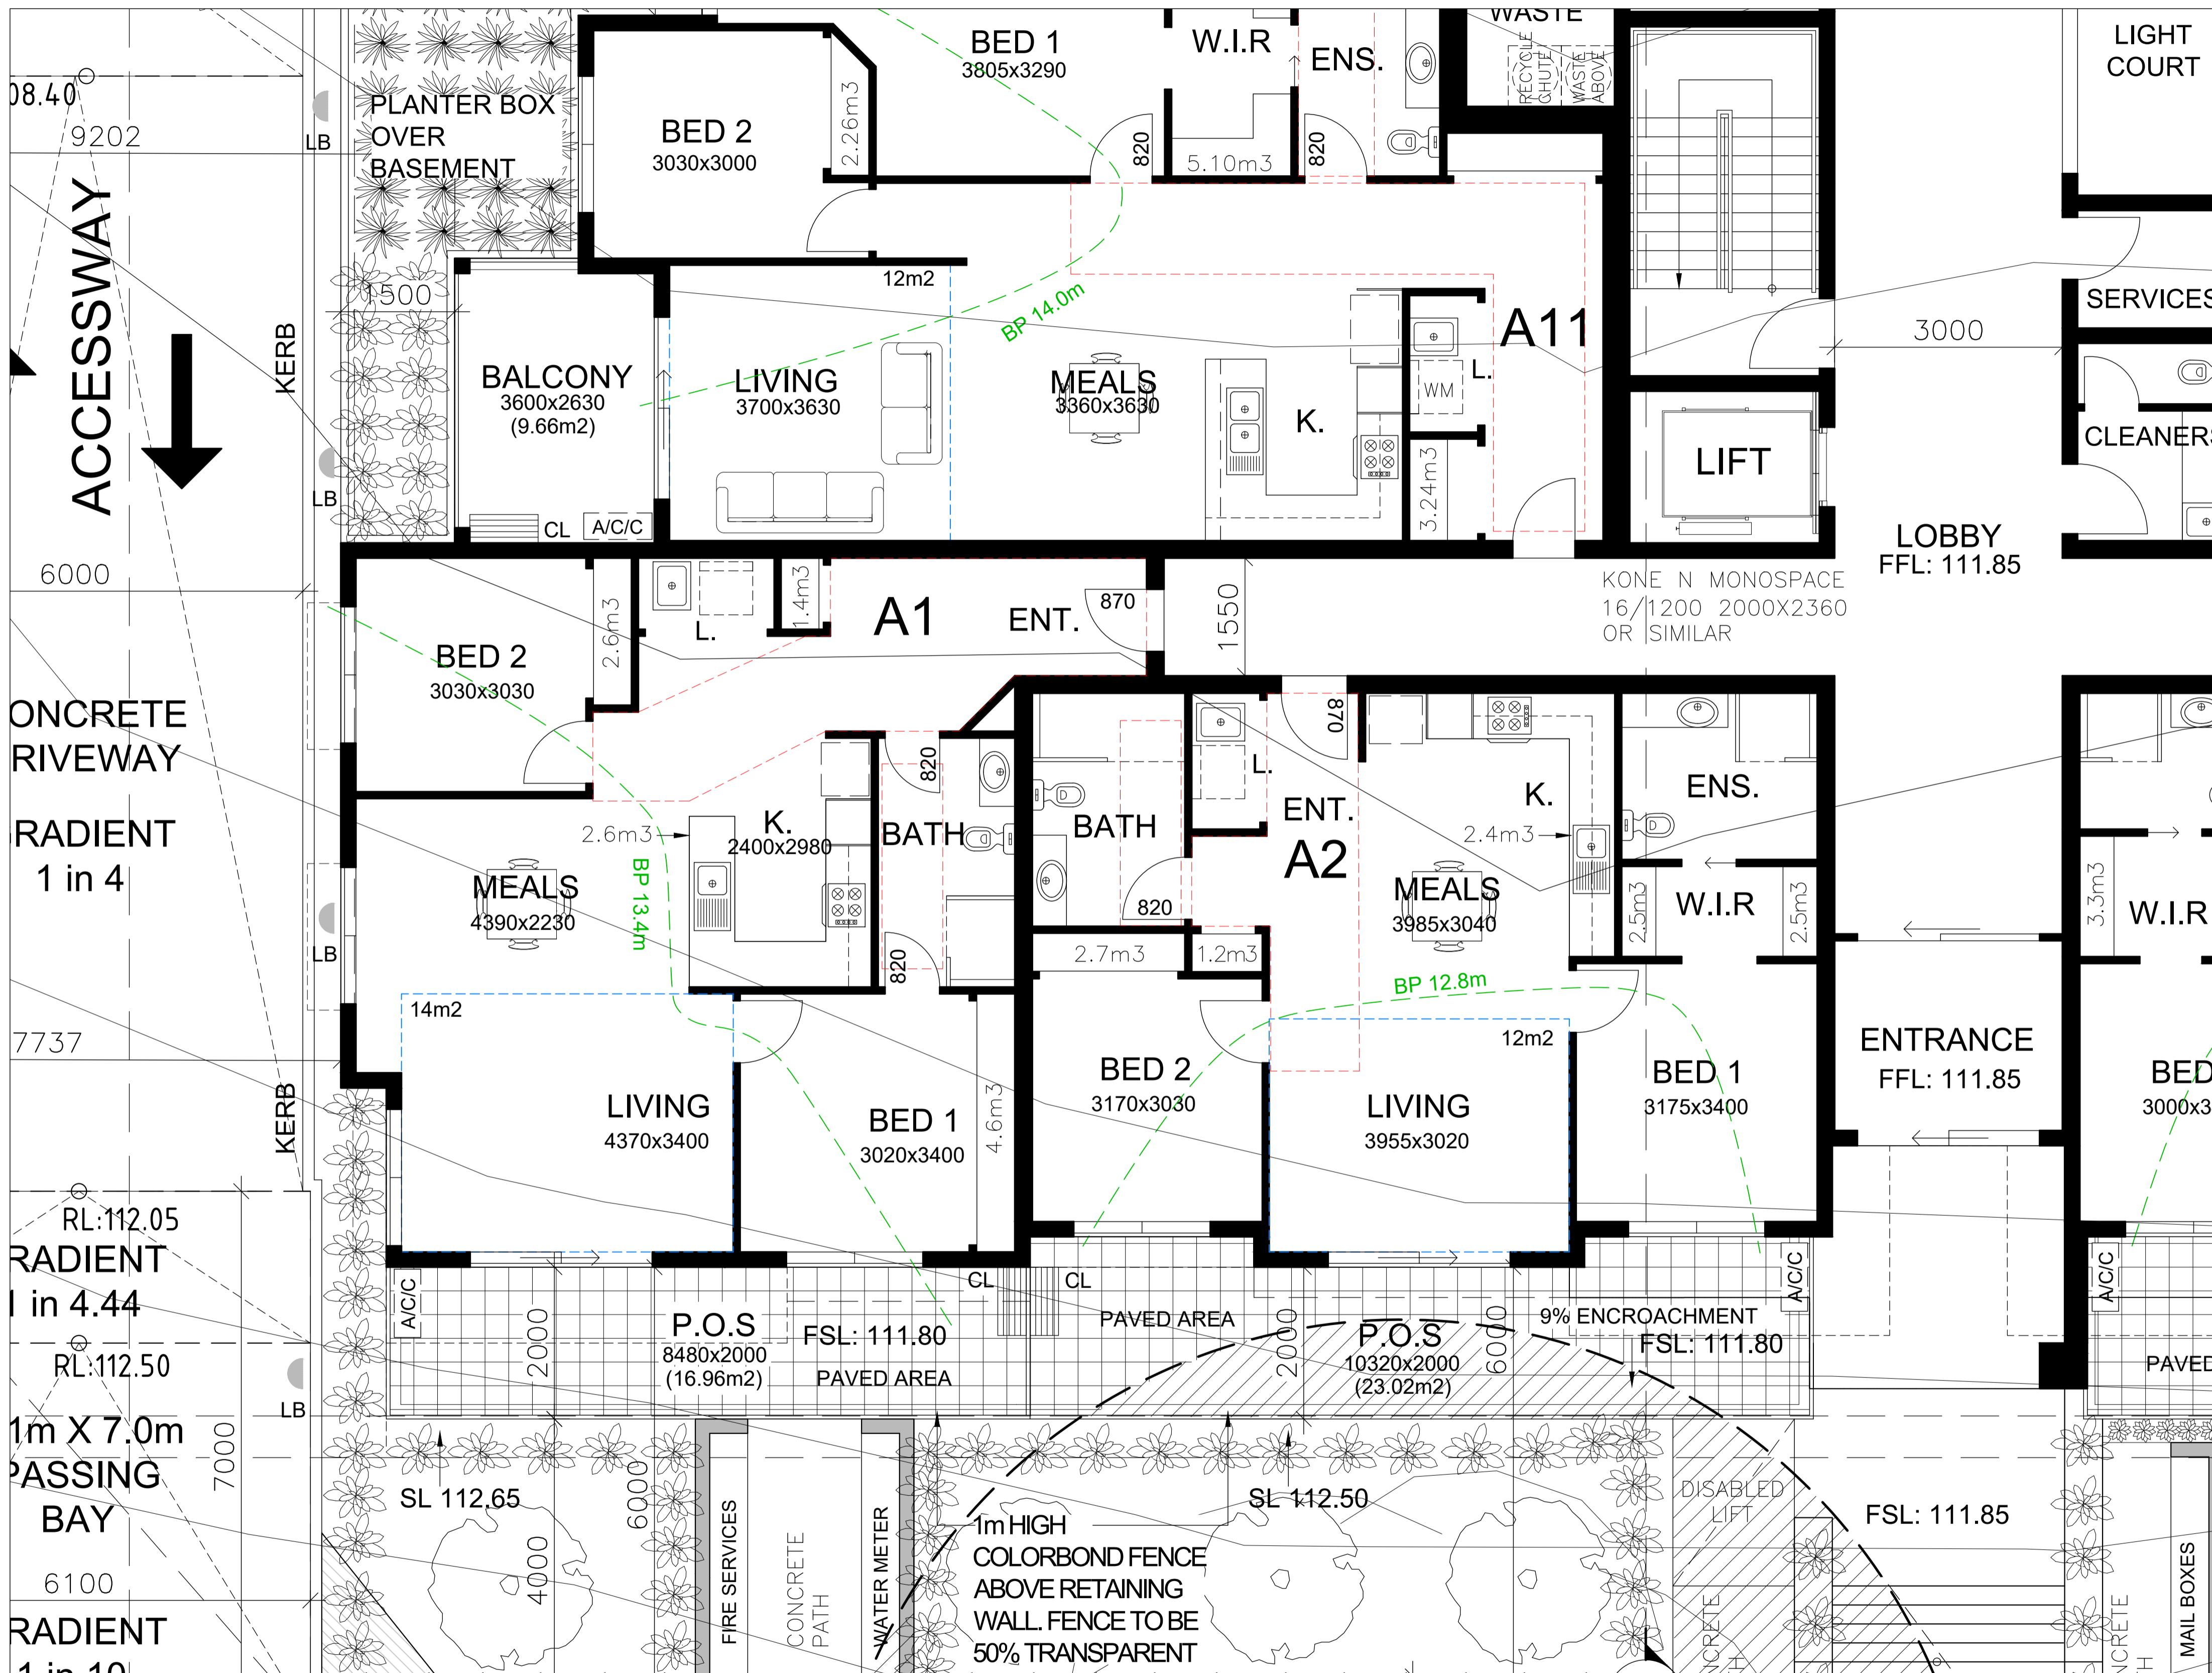


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## LEGEND:



# ADAPTABLE APARTMENTS
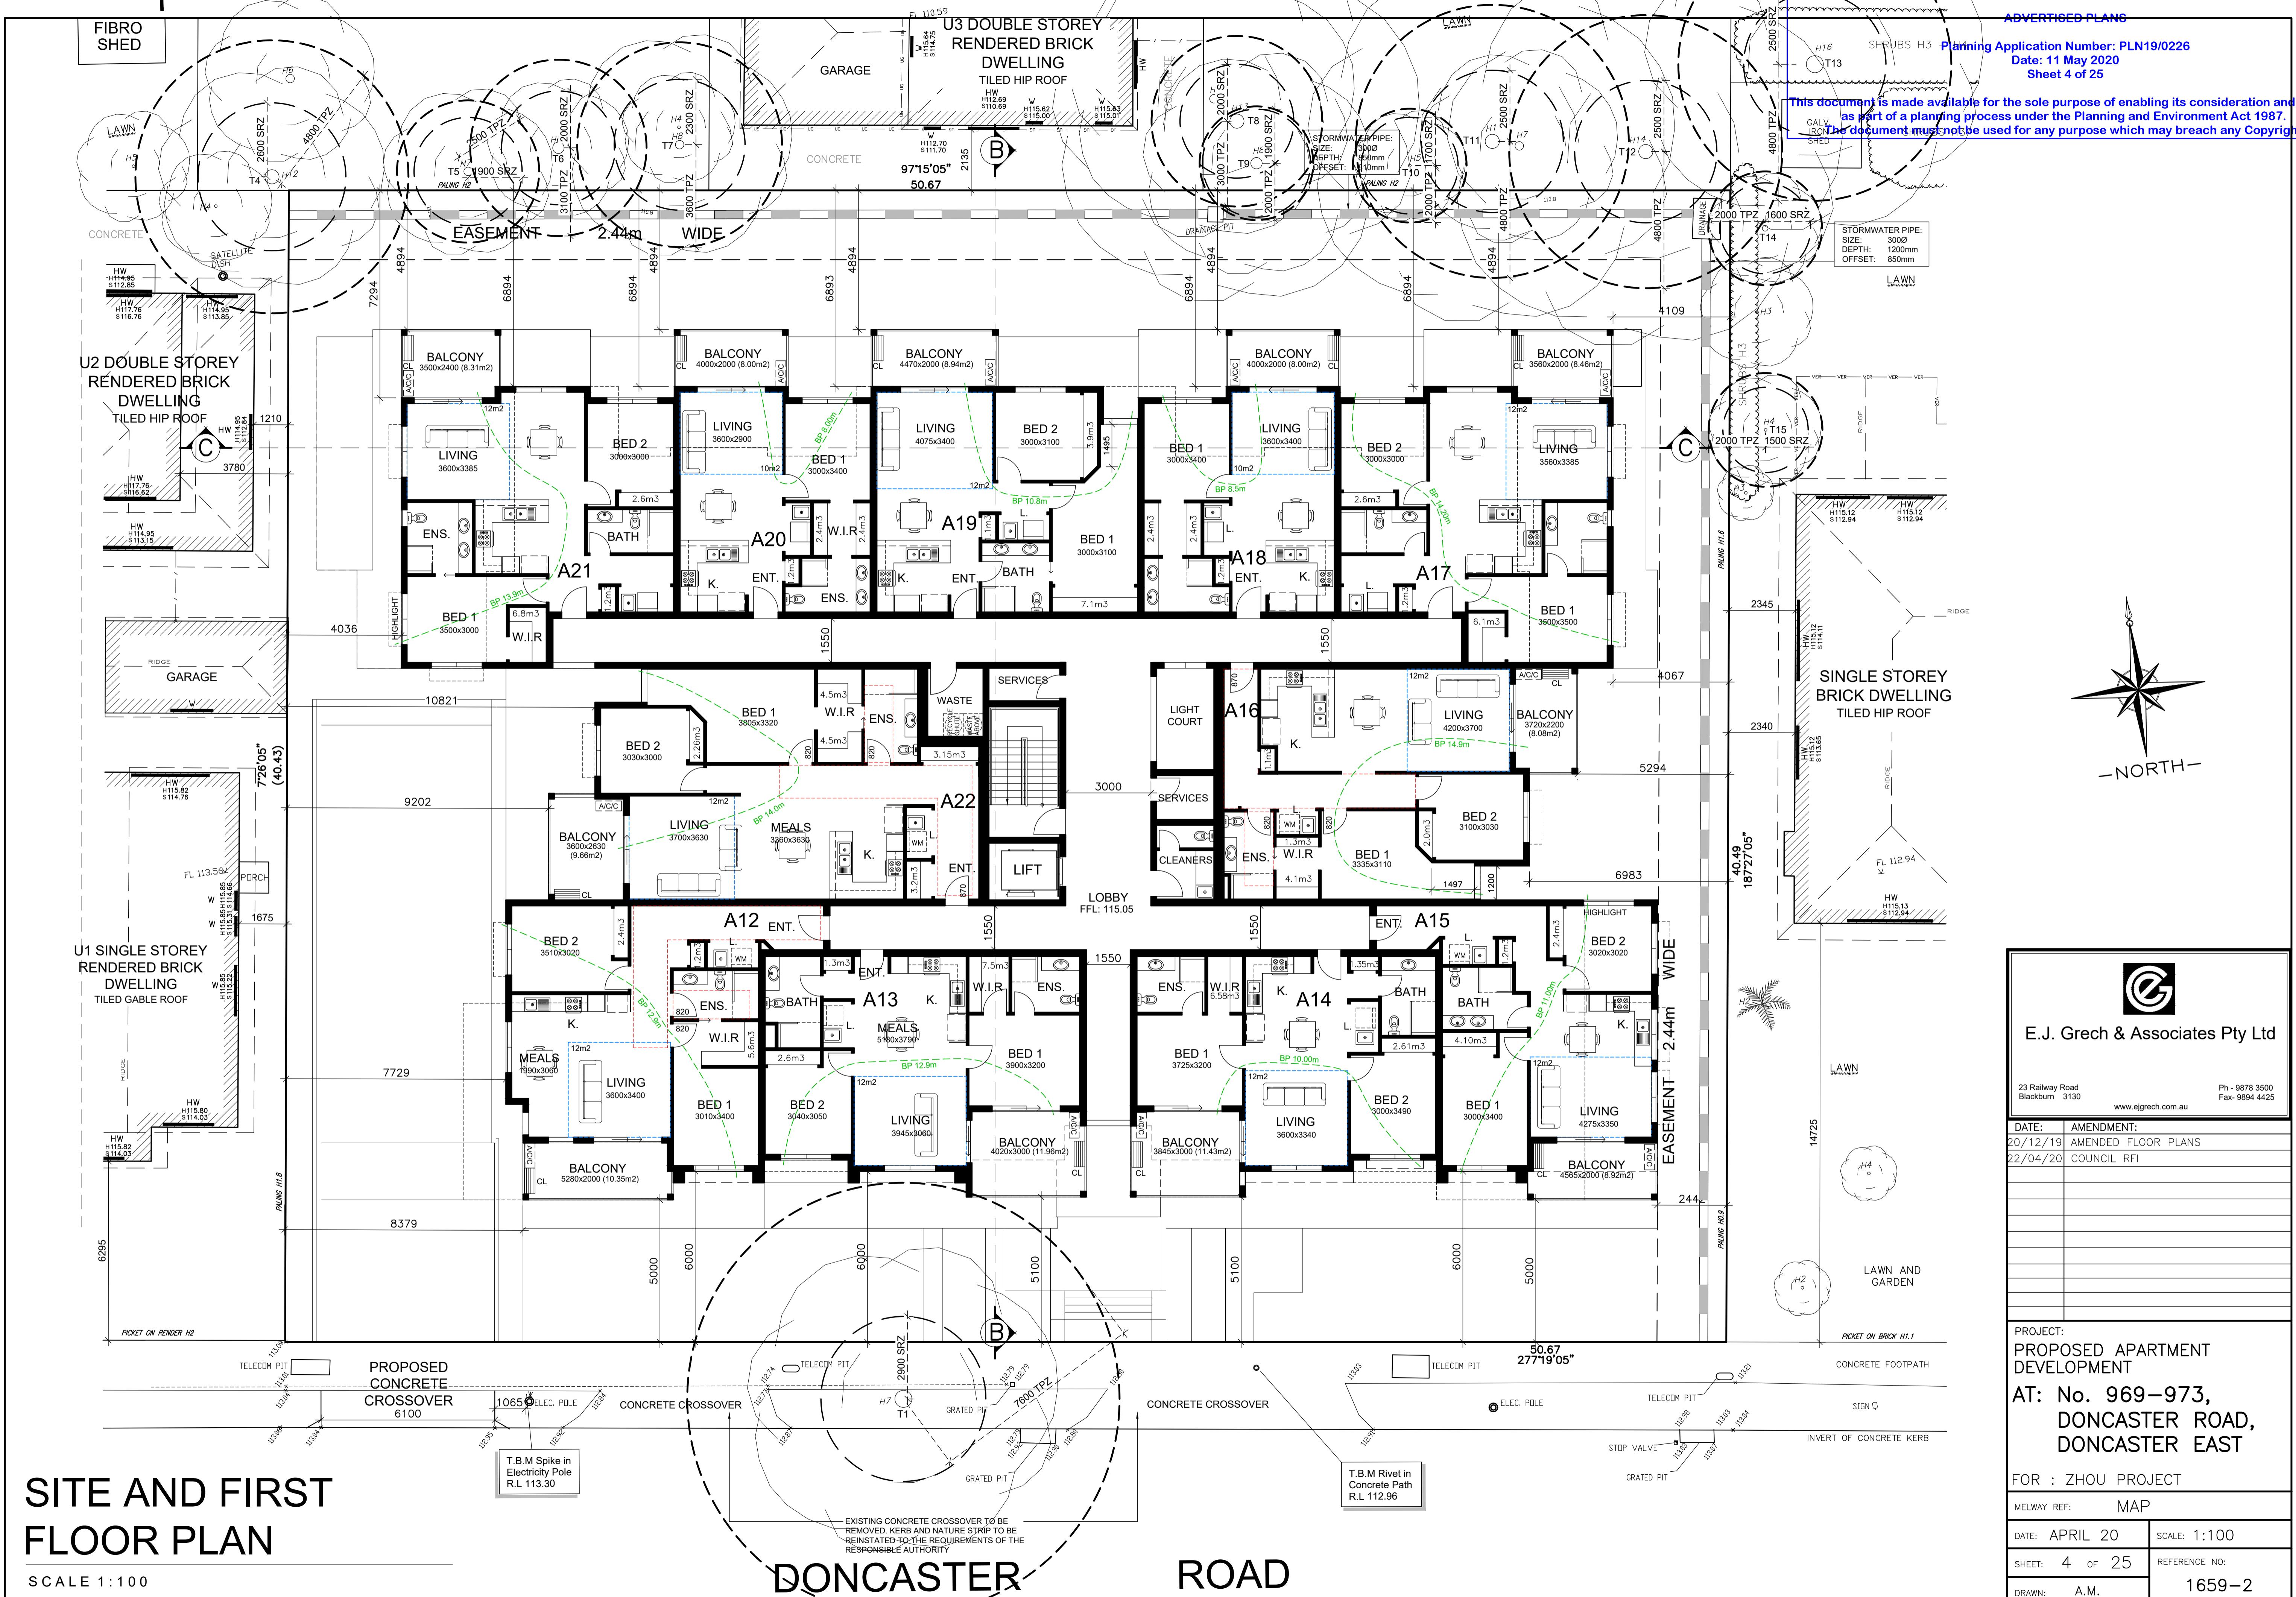
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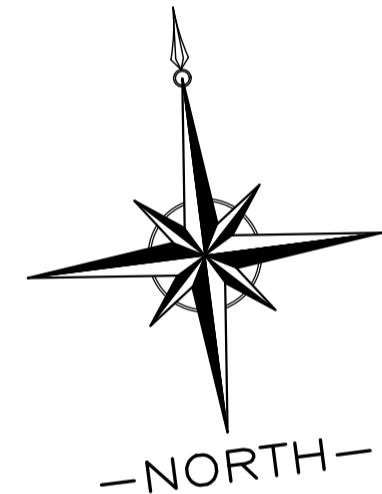
**APARTMENT 1 - ADAPTABLE**  
**APARTMENT 2 - ADAPTABLE**

## STORAGE VOLUME:

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APARTMENT 1 -	11.20m3
BASEMENT STORAGE-	6.0m3
TOTAL-	17.20m3

**APARTMENT 2 -** 11.30m<sup>3</sup>  
**BASEMENT STORAGE:** 6.0m<sup>3</sup>  
**TOTAL-** 17.30m<sup>3</sup>



The logo consists of a black square containing a white stylized letter 'e' with a circular arrow around it.

DATE:	AMENDMENT:
/12/19	AMENDED FLOOR PLANS
/04/20	COUNCIL RFI

PROJECT:  
PROPOSED APARTMENT  
DEVELOPMENT  
AT: No. 969-973,  
DONCASTER ROAD,  
DONCASTER EAST

OR : ZHOU PROJECT

ELWAY REF: MAP

DATE: APRIL 20 SCALE: 1:50

HEET: 8 OF 25

RAWN: A.M. | 1659-2

RAWN: A.M. 1000-2


# APARTMENTS 1 & 2 FLOORPLANS

SCALE 1:50

ADVERTISED PLANS

Planning Application Number: PLN19/0226  
Date: 11 May 2020  
Sheet 9 of 25

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LEGEND:

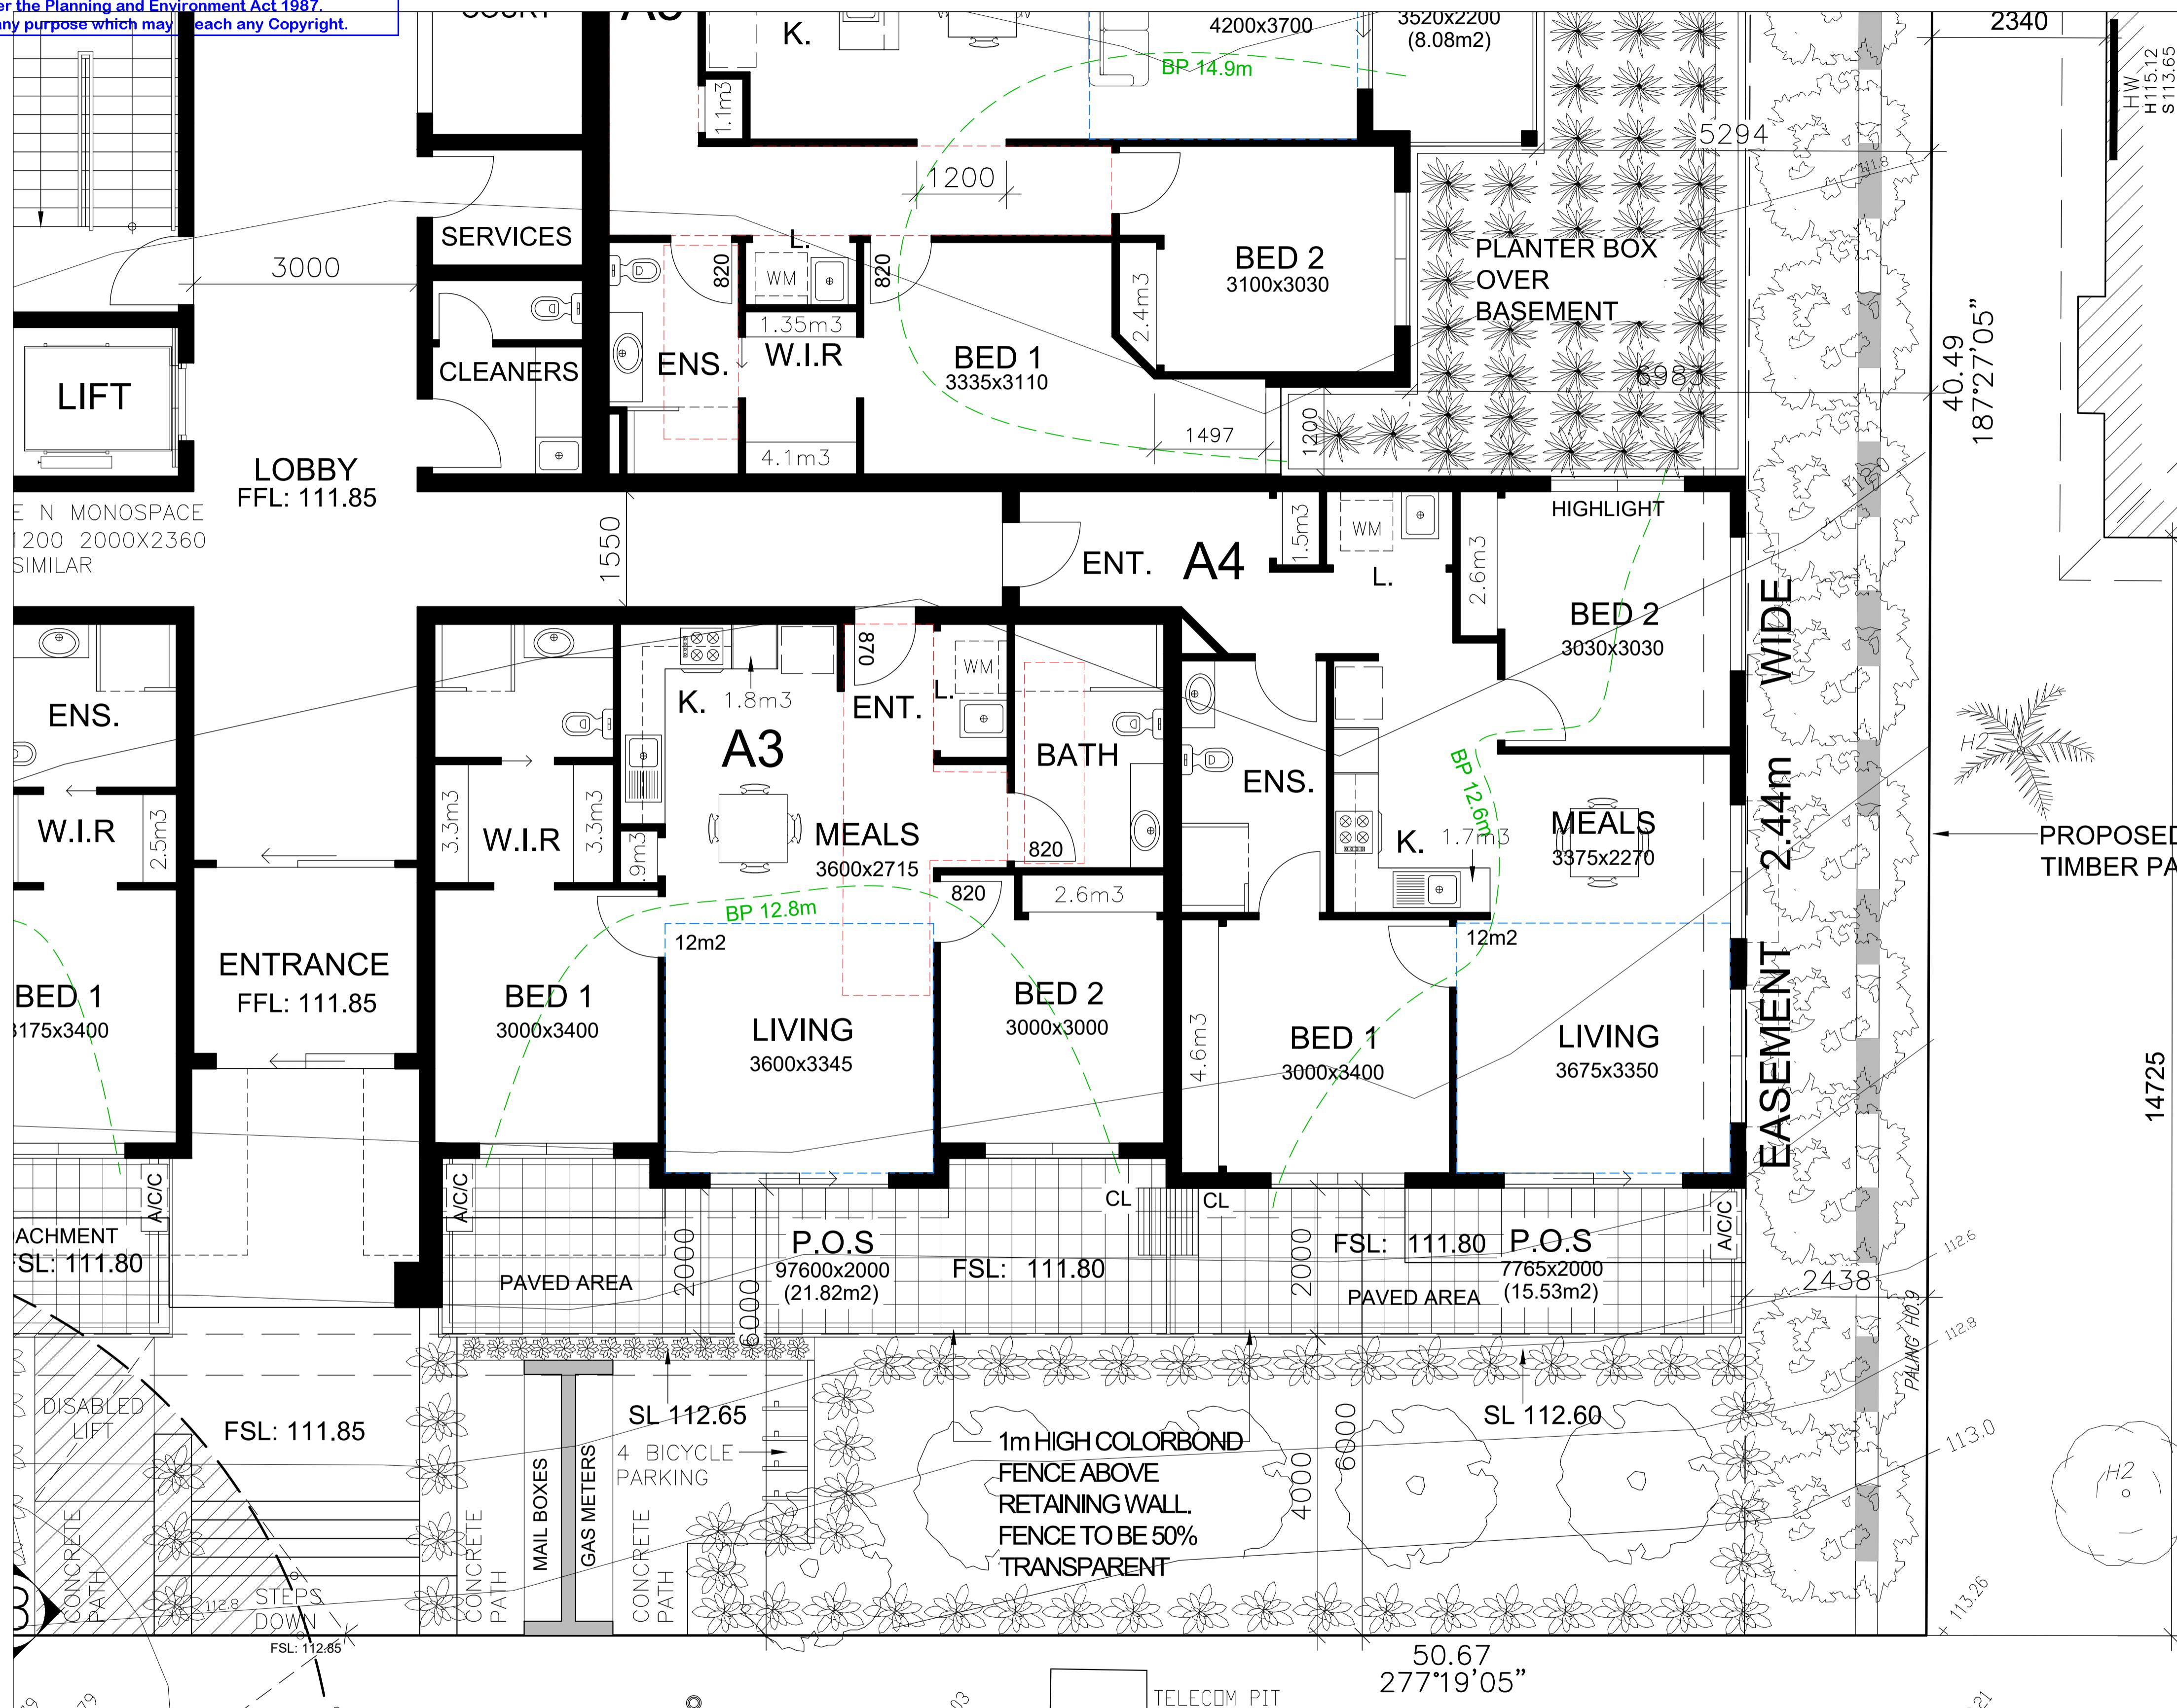
- CL CLOTHES LINE
- ADAPTABLE AREA ZONE
- LIVING ROOM ZONE
- BP BREEZE PATH

ADAPTABLE APARTMENTS:  
APARTMENT 3 - ADAPTABLE

STORAGE VOLUME:

APARTMENT 3 - 11.90m<sup>3</sup>  
BASEMENT STORAGE- 6.0m<sup>3</sup>  
TOTAL- 17.90m<sup>3</sup>

APARTMENT 4 - 10.43m<sup>3</sup>  
BASEMENT STORAGE: 6.0m<sup>3</sup>  
TOTAL- 16.43m<sup>3</sup>

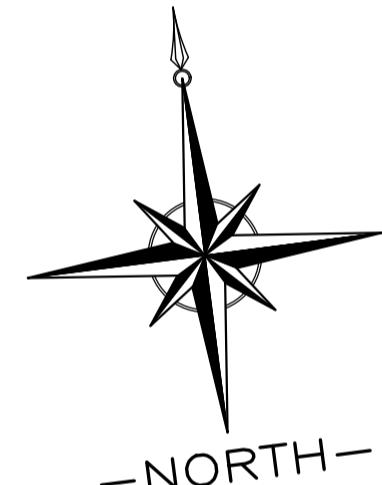

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DATE: AMENDMENT:  
20/12/19 AMENDED FLOOR PLANS  
22/04/20 COUNCIL RFI

PROJECT:  
PROPOSED APARTMENT DEVELOPMENT  
AT: No. 969–973,  
DONCASTER ROAD,  
DONCASTER EAST

FOR : ZHOU PROJECT	MAP
MELWAY REF:	SCALE: 1:50
DATE: APRIL 20	SHEET: 9 OF 25
REFERENCE NO:	
DRAWN: A.M.	1659-2



APARTMENTS 3 & 4  
FLOORPLANS

SCALE 1:50

## ~~ADVERTISED PLANS~~

**Planning Application Number: PLN19/0226**  
**Date: 11 May 2020**  
**Sheet 10 of 25**

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## LEGEND:

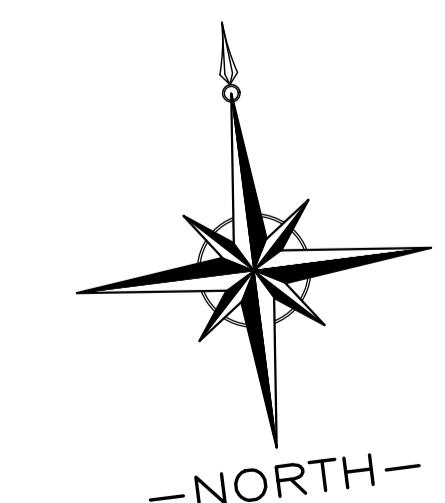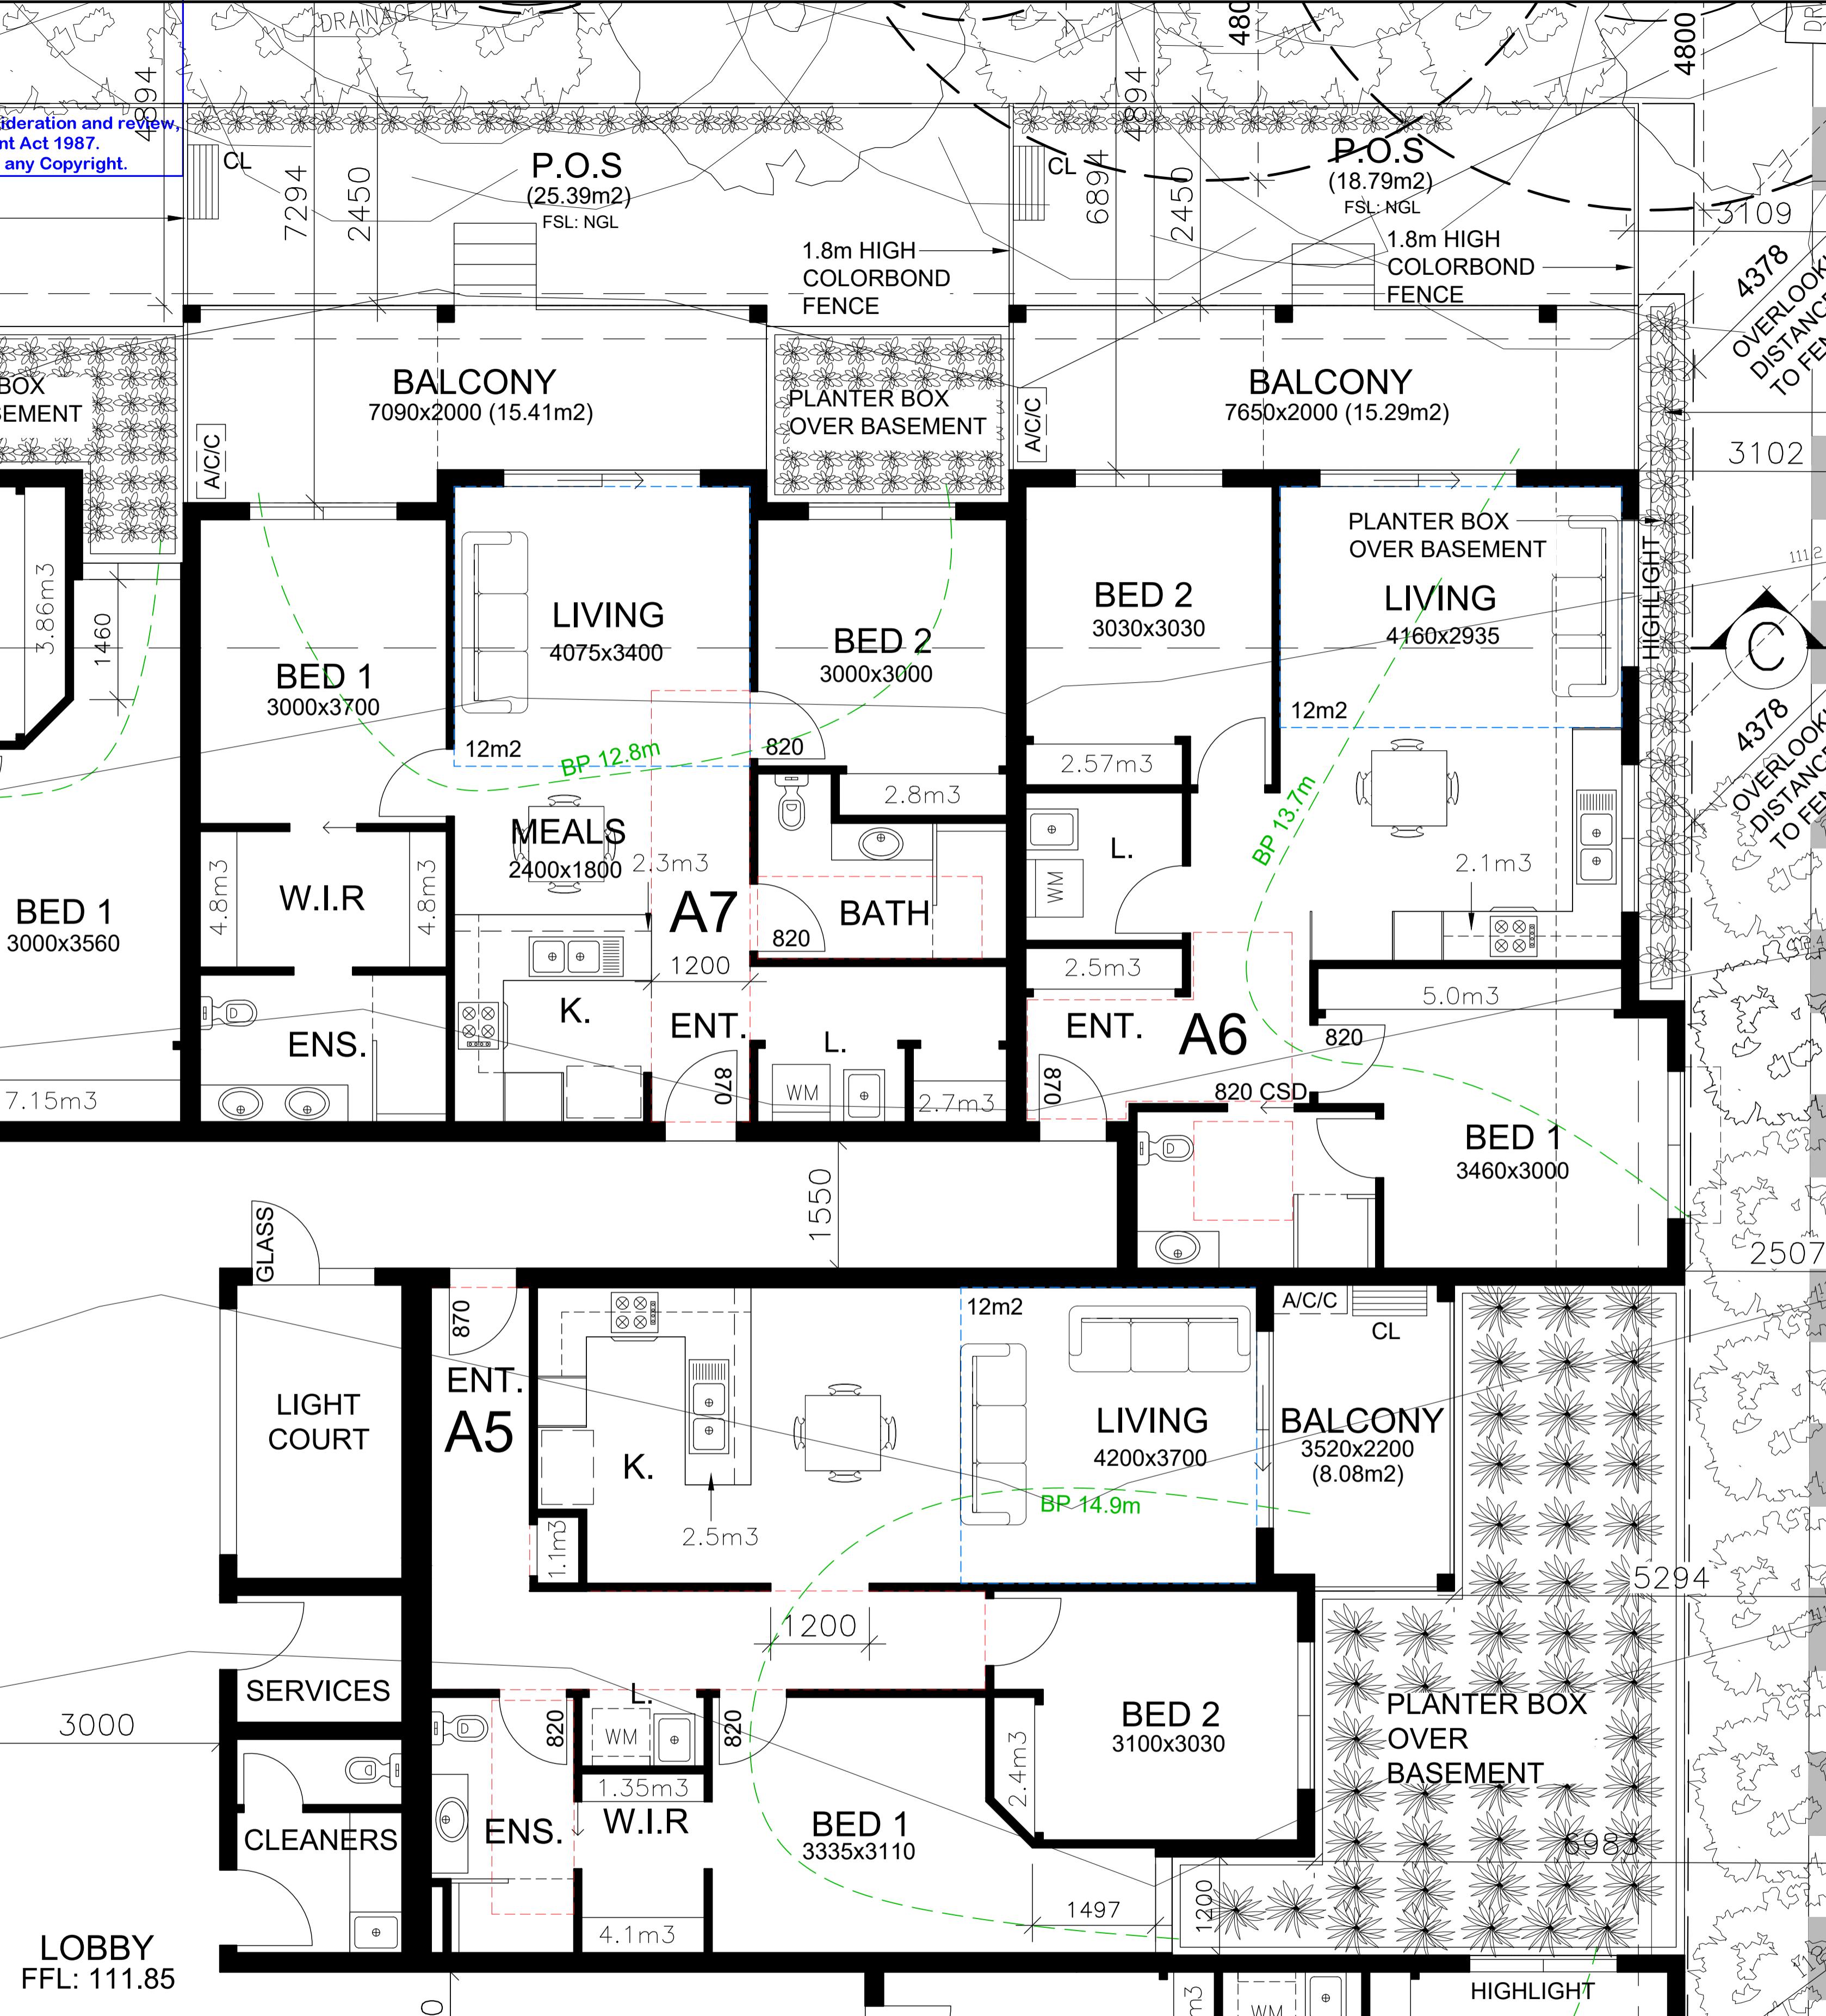The diagram illustrates a floor plan with three distinct zones:

- CLOTHES LINE**: Indicated by a vertical rectangle on the left labeled "CL".
- ADAPTABLE AREA ZONE**: Indicated by a large dashed red rectangle.
- LIVING ROOM ZONE**: Indicated by a large dashed blue rectangle.

A green curved line labeled "BP" (Breeze Path) starts from the bottom left and curves upwards towards the center of the adaptable area zone.

# ADAPTABLE APARTMENTS:

---

**APARTMENT 5 - ADAPTABLE**  
**APARTMENT 6 - ADAPTABLE**  
**APARTMENT 7 - ADAPTABLE**

## STORAGE VOLUME:

---

**APARTMENT 5 -** 11.20m<sup>3</sup>  
**BASEMENT STORAGE:** 6.0m<sup>3</sup>  
**TOTAL -** 17.20m<sup>3</sup>

APARTMENT 6 -	11.30m <sup>3</sup>
SHED-	6.0m <sup>3</sup>
TOTAL-	17.30m <sup>3</sup>

APARTMENT 7 -	11.30m <sup>3</sup>
SHED:	6.0m <sup>3</sup>
<b>TOTAL-</b>	<b>17.30m<sup>3</sup></b>



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DATE: AMENDMENT:  
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20/12/19 COUNCIL RE

**PROJECT:  
PROPOSED APARTMENT**

DEVELOPMENT  
AT: No. 969-973,  
DONCASTER ROAD,  
DONCASTER EAST

FOR : ZHOU PROJECT

MELWAY REFERENCE MAPS

DATE APRIL 30 SCALE 1:50


DATE: APRIL 20 SCALE: 1:50

1659-2

DRAWN: A.M.

# APARTMENTS 5, 6 & 7 FLOORPLANS


SCALE 1:50

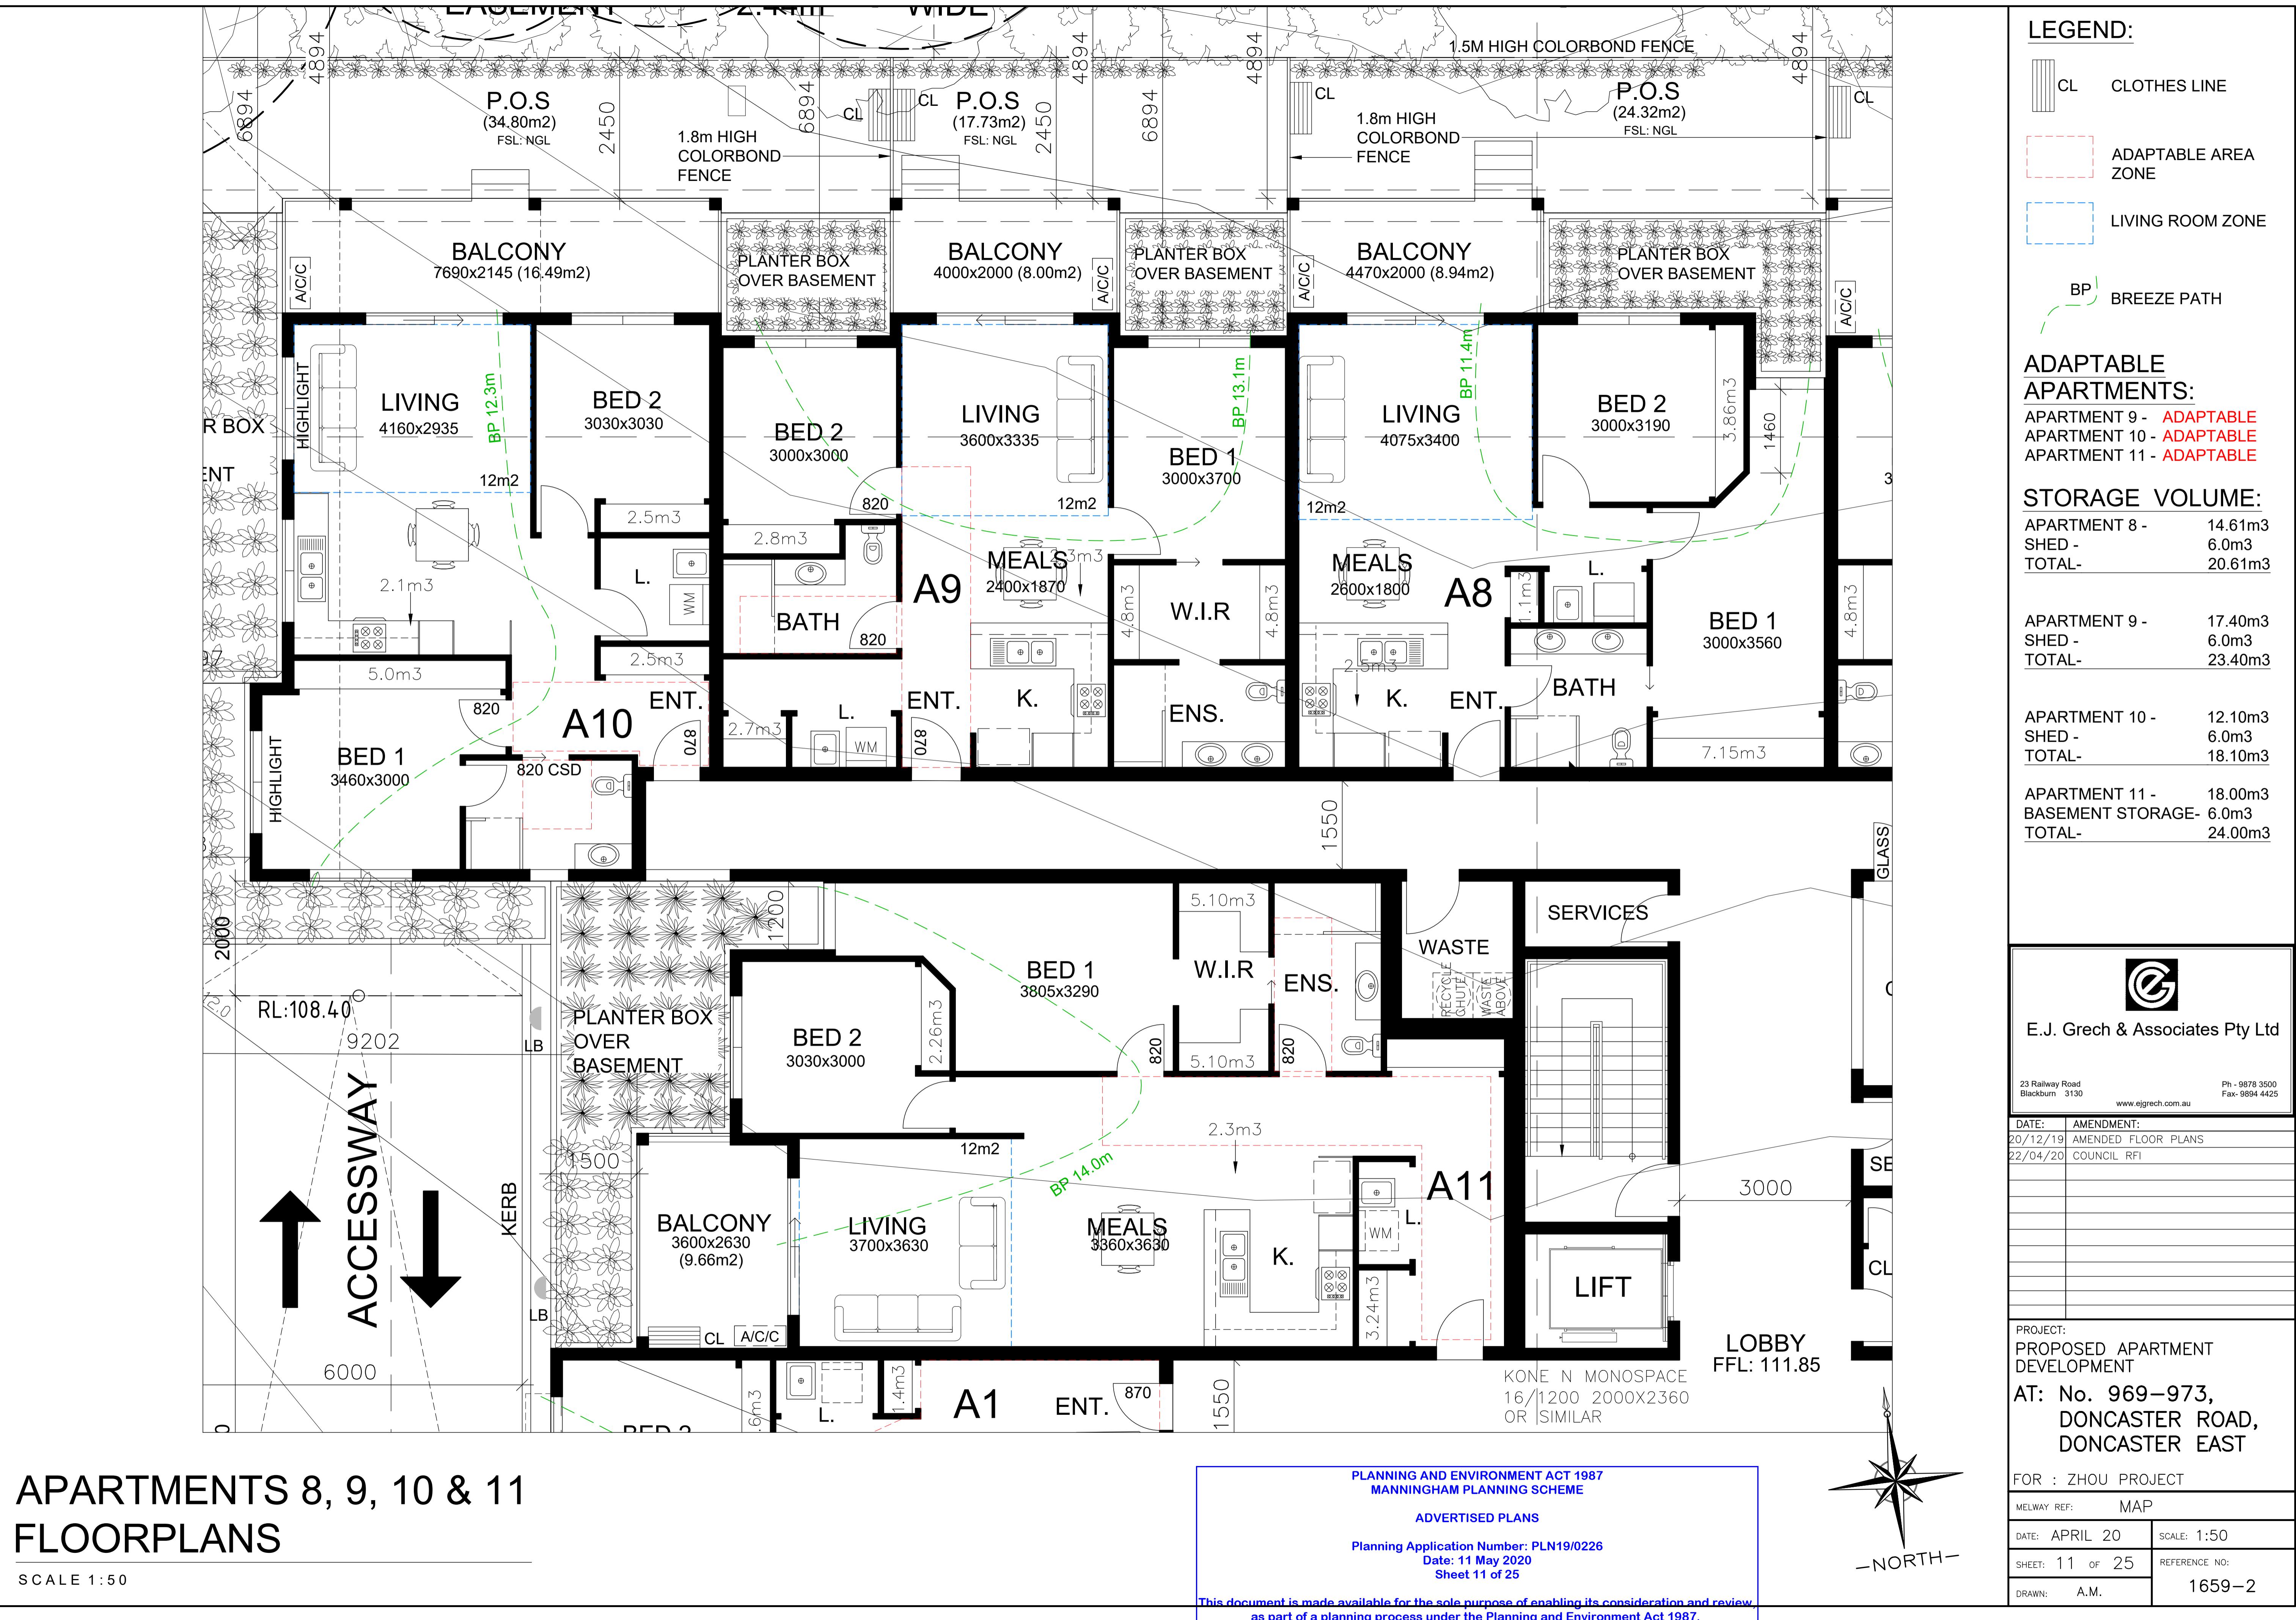

ADVERTISED PLANS

Planning Application Number: PLN19/0226  
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Sheet 12 of 25

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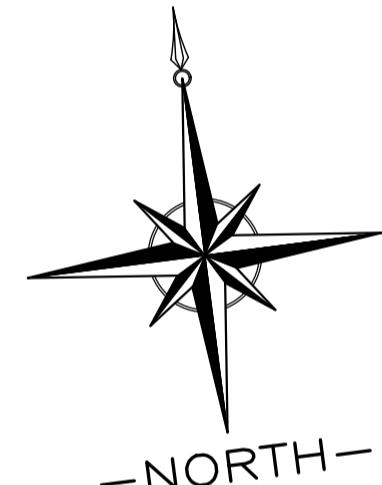
LEGEND:

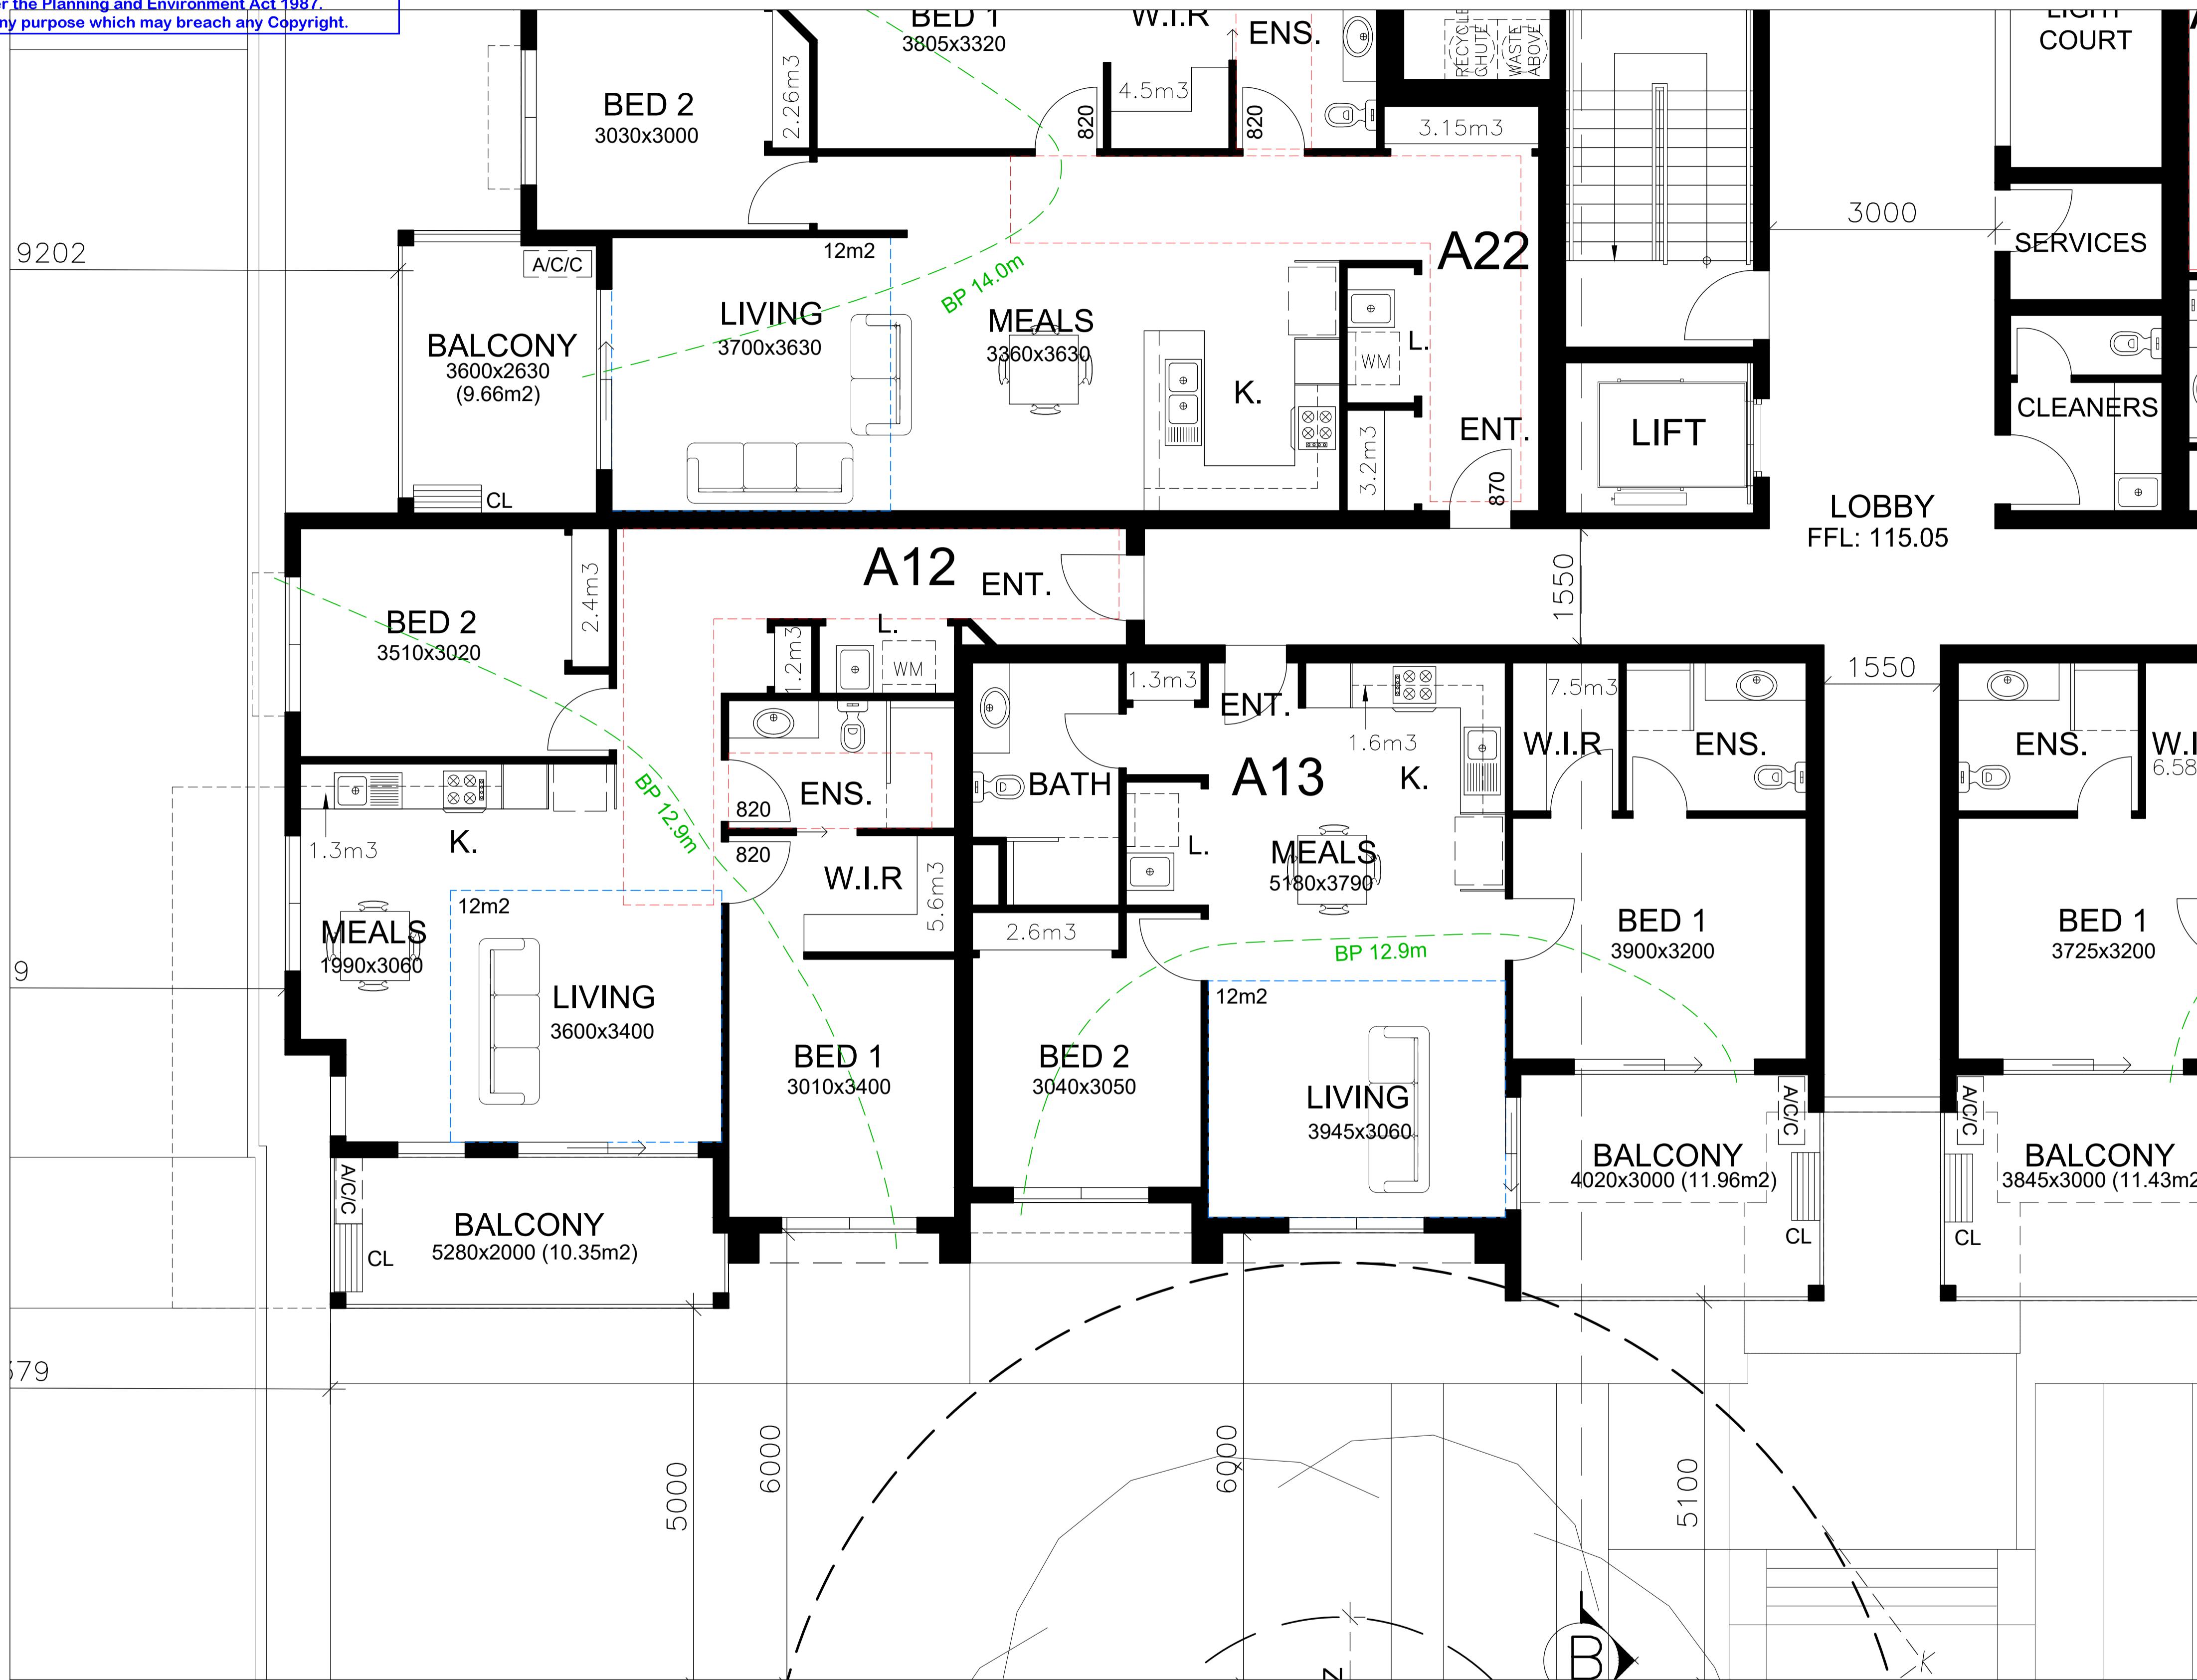- CL CLOTHES LINE
- ADAPTABLE AREA ZONE
- LIVING ROOM ZONE
- BP BREEZE PATH

ADAPTABLE APARTMENTS:  
APARTMENT 12 - ADAPTABLE

STORAGE VOLUME:  
APARTMENT 12 - 10.50m3  
BASEMENT STORAGE- 6.0m3  
TOTAL- 16.50m3

APARTMENT 13 - 13.00m3  
BASEMENT STORAGE- 6.0m3  
TOTAL- 19.00m3



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DATE: AMENDMENT:  
20/12/19 AMENDED FLOOR PLANS  
22/04/20 COUNCIL RFI

PROJECT:  
PROPOSED APARTMENT DEVELOPMENT  
AT: No. 969–973,  
DONCASTER ROAD,  
DONCASTER EAST

FOR : ZHOU PROJECT	MAP
MELWAY REF:	SCALE: 1:50
DATE: APRIL 20	SHEET: 12 OF 25
DRAWN: A.M.	REFERENCE NO: 1659-2


APARTMENTS 12 & 13  
FLOORPLANS

SCALE 1:50

ADVERTISED PLANS

Planning Application Number: PLN19/0226  
Date: 11 May 2020  
Sheet 13 of 25

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LEGEND:

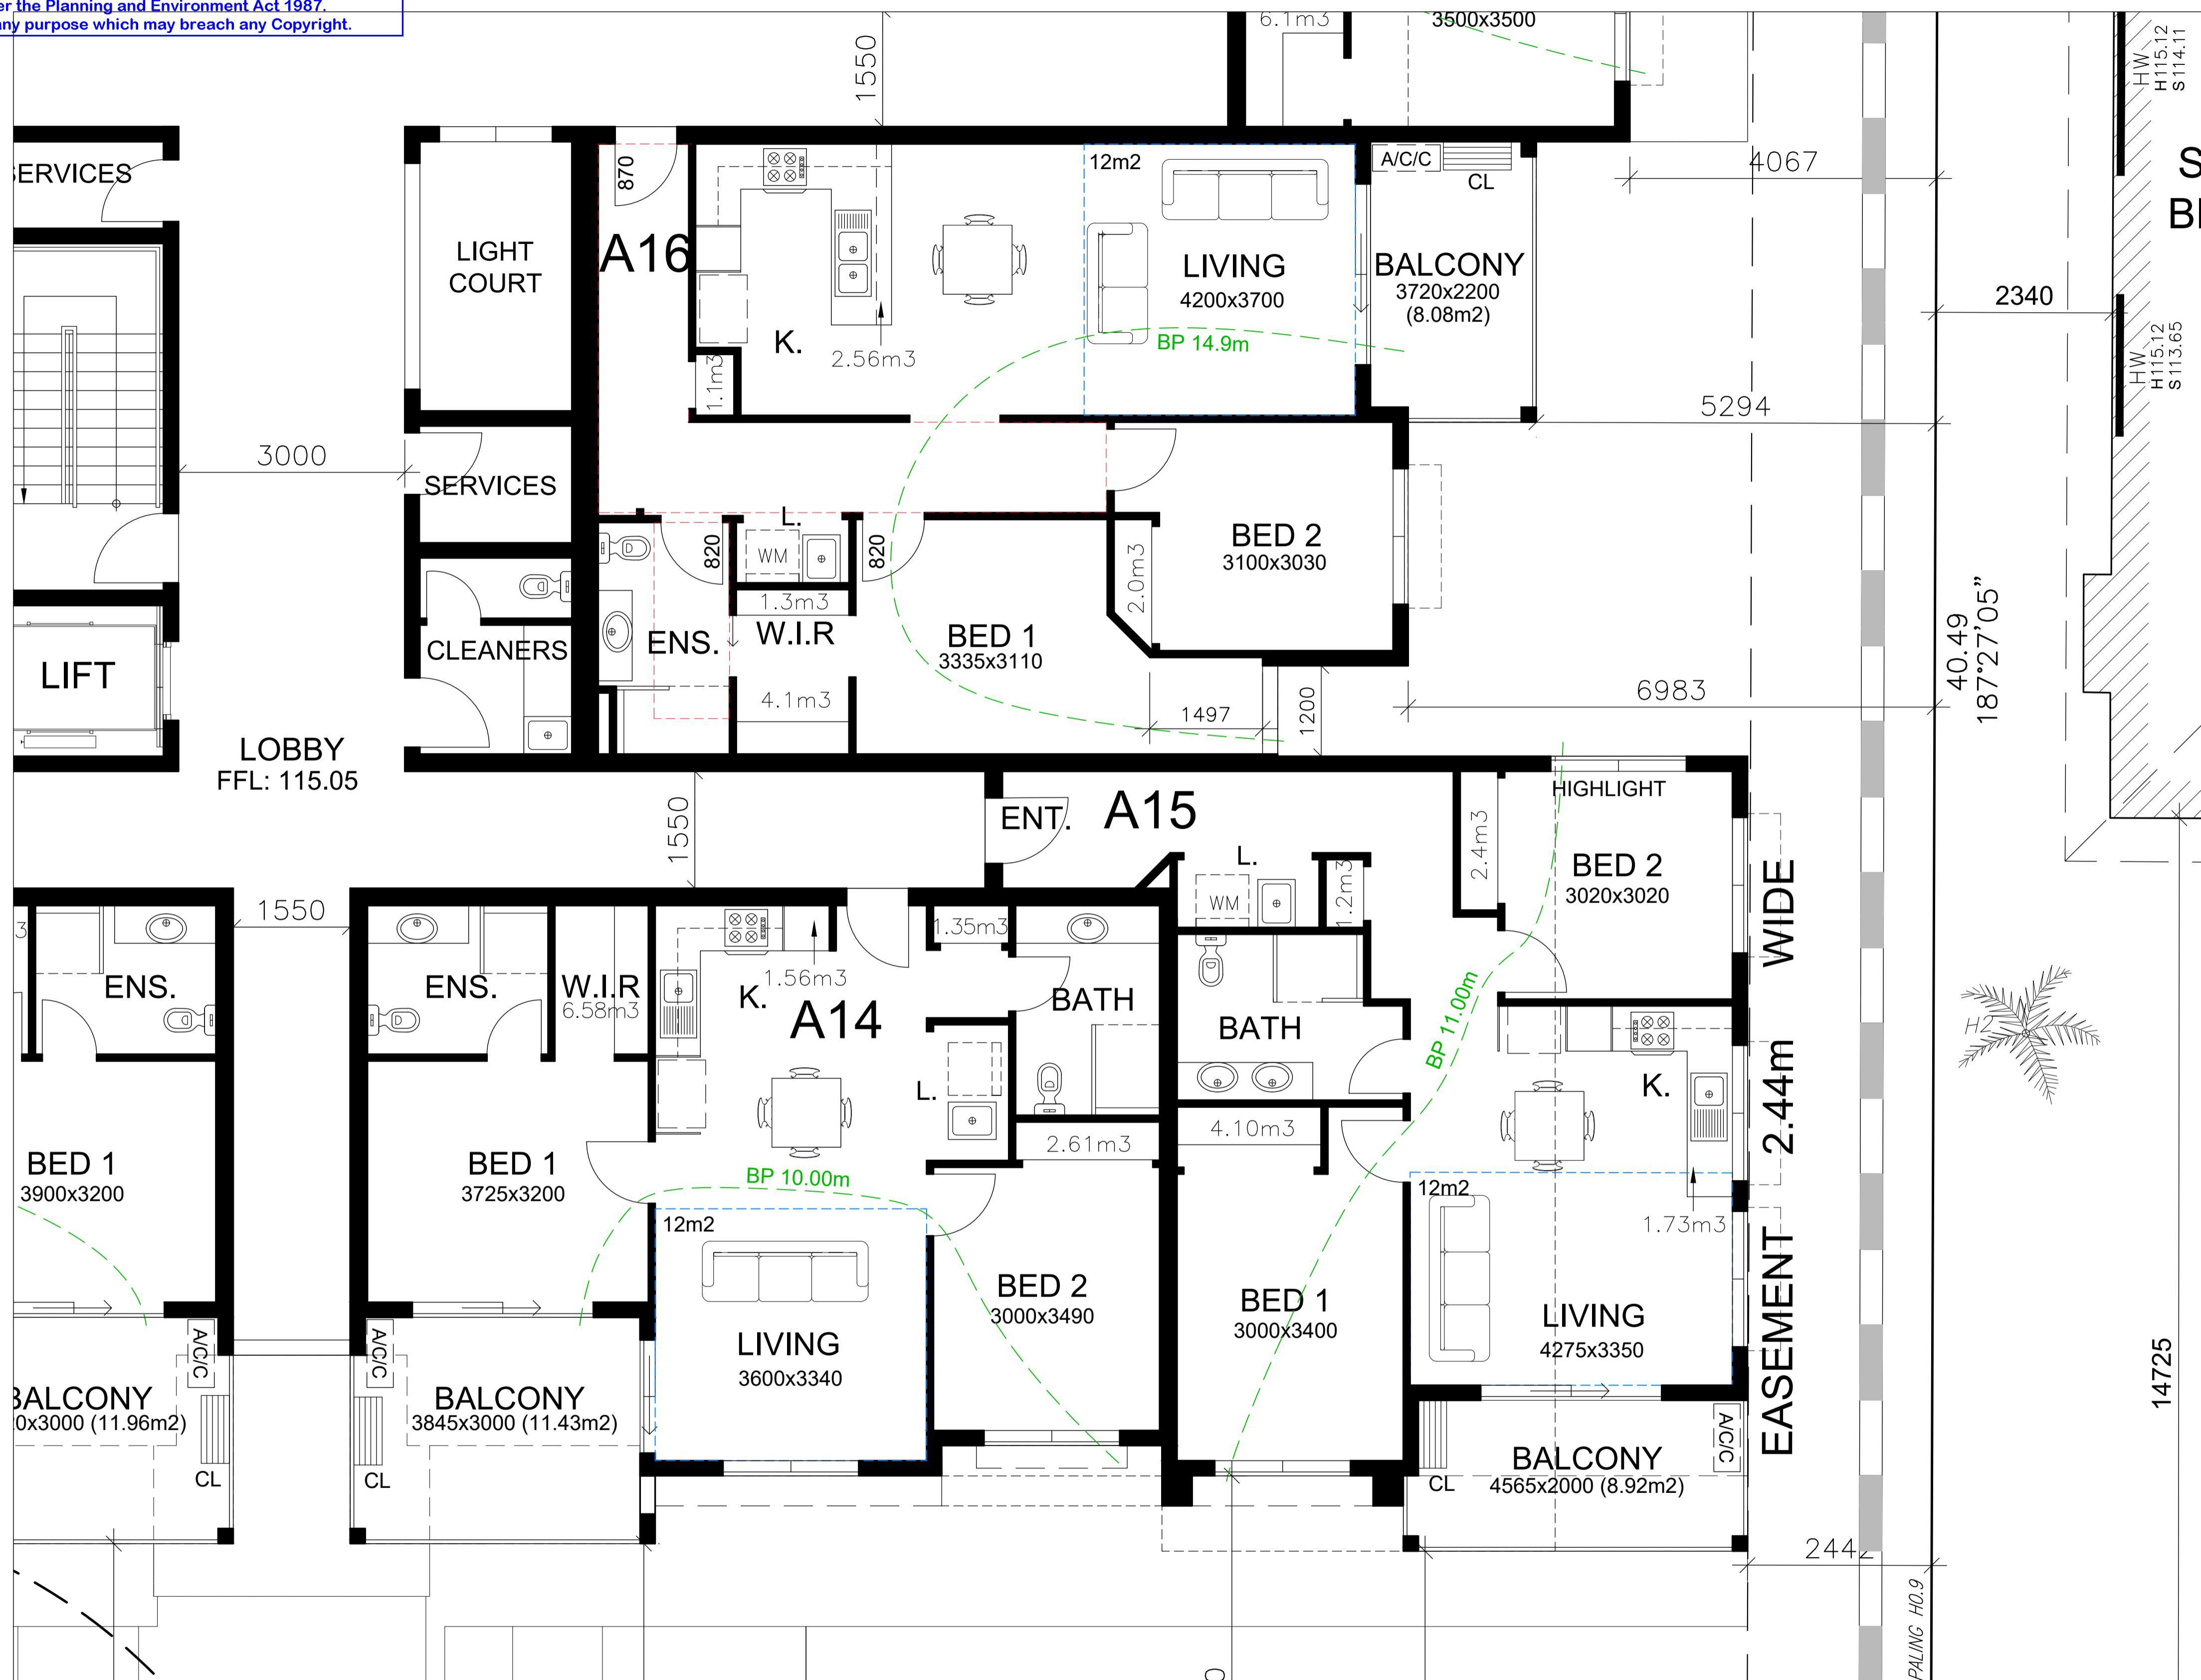- CL CLOTHES LINE
- ADAPTABLE AREA ZONE
- LIVING ROOM ZONE
- BP BREEZE PATH


ADAPTABLE APARTMENTS:  
APARTMENT 16 - ADAPTABLE

STORAGE VOLUME:

APARTMENT 14 - 12.10m³  
BASEMENT STORAGE- 6.00m³  
TOTAL- 18.10m³

APARTMENT 15 - 9.49m³  
BASEMENT STORAGE- 6.0m³  
TOTAL- 15.49m³

APARTMENT 16 - 11.06m³  
BASEMENT STORAGE- 6.0m³  
TOTAL- 17.06m³

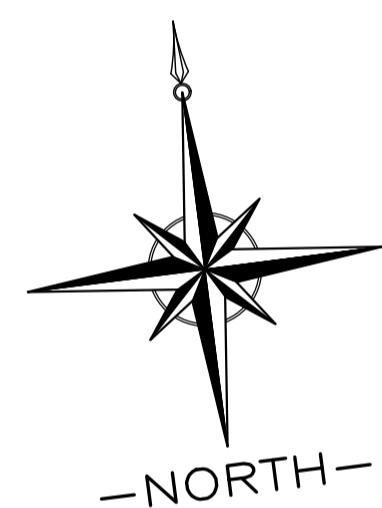

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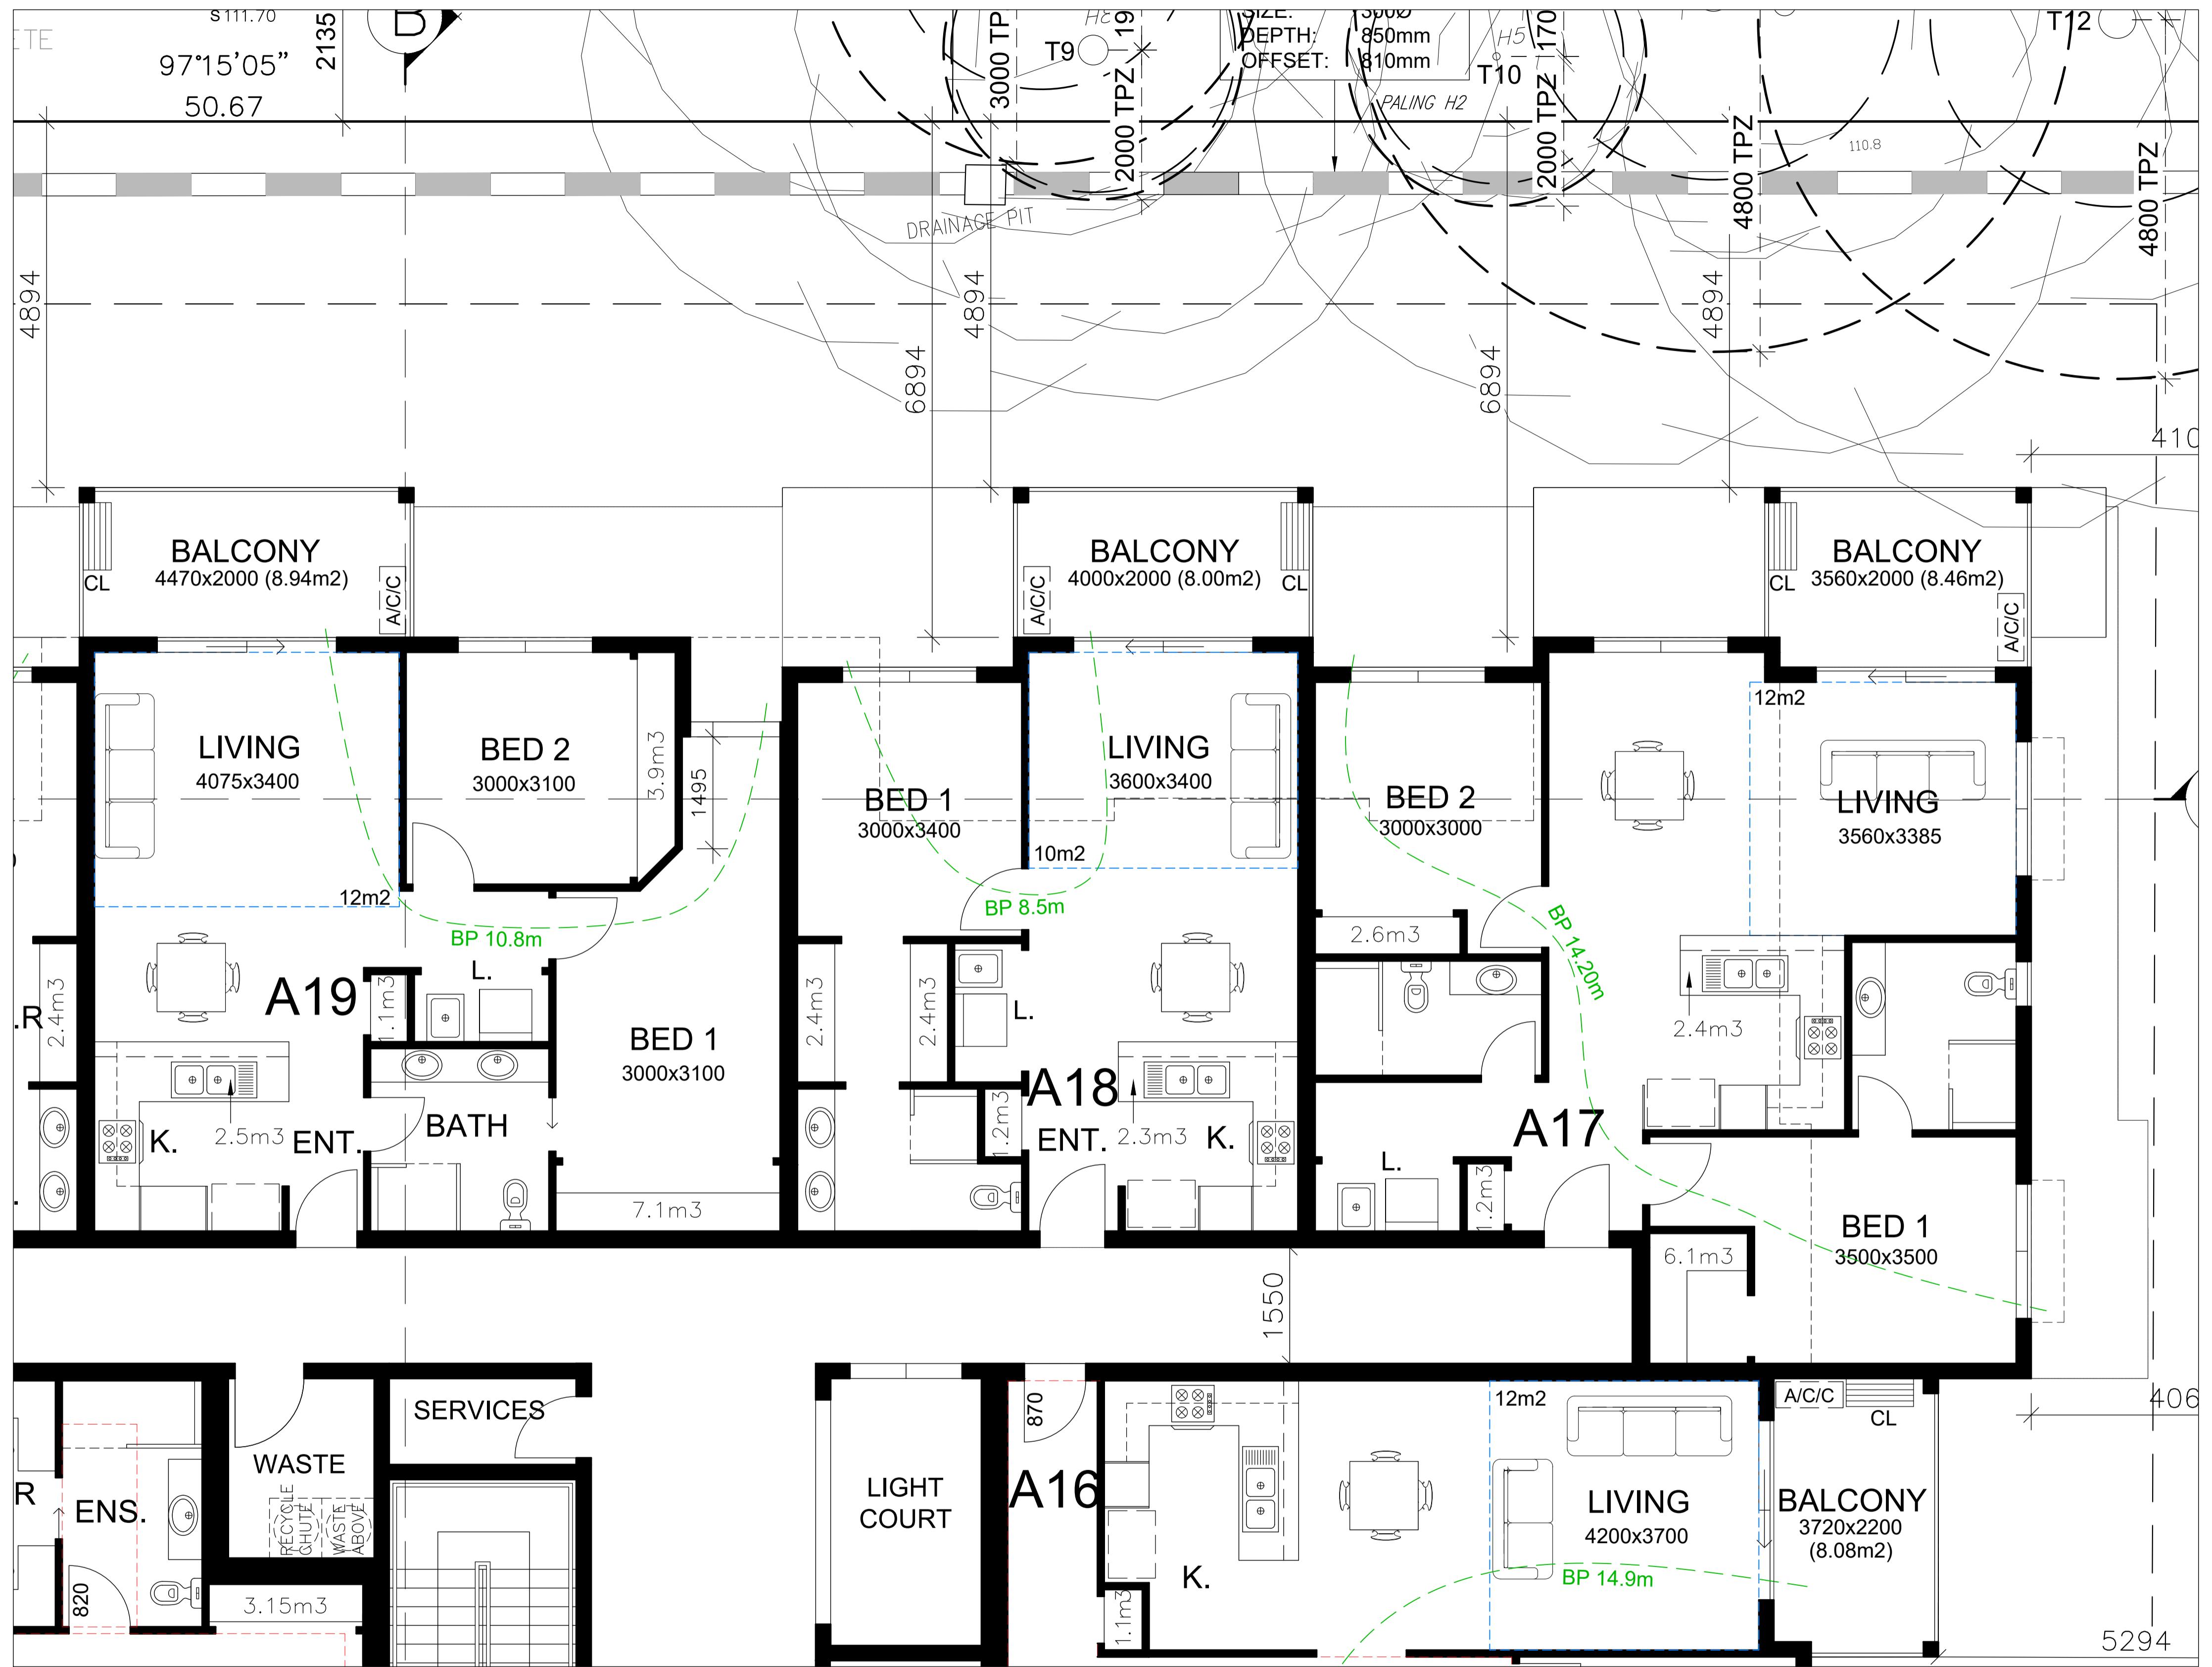
DATE:	AMENDMENT:
20/12/19	AMENDED FLOOR PLANS
22/04/20	COUNCIL RFI

PROJECT:  
PROPOSED APARTMENT DEVELOPMENT  
AT: No. 969–973,  
DONCASTER ROAD,  
DONCASTER EAST

FOR : ZHOU PROJECT	MAP
MELWAY REF:	SCALE: 1:50
DATE: APRIL 20	SHEET: 13 OF 25
DRAWN: A.M.	REFERENCE NO: 1659-2

APARTMENTS 14, 15 & 16  
FLOORPLANS

SCALE 1:50




## APARTMENTS 17, 18 & 19 FLOORPLANS

SCALE 1:50

PLANNING AND ENVIRONMENT ACT 1987  
MANNINGHAM PLANNING SCHEME  
ADVERTISED PLANS  
Planning Application Number: PLN19/0226  
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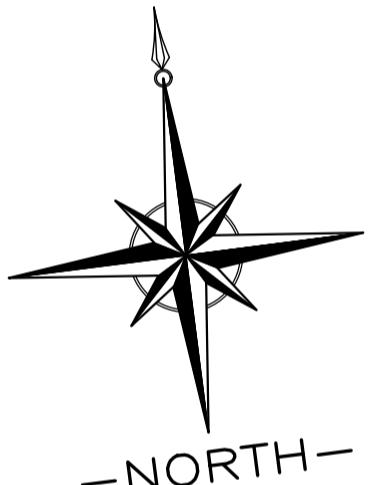


### STORAGE VOLUME:

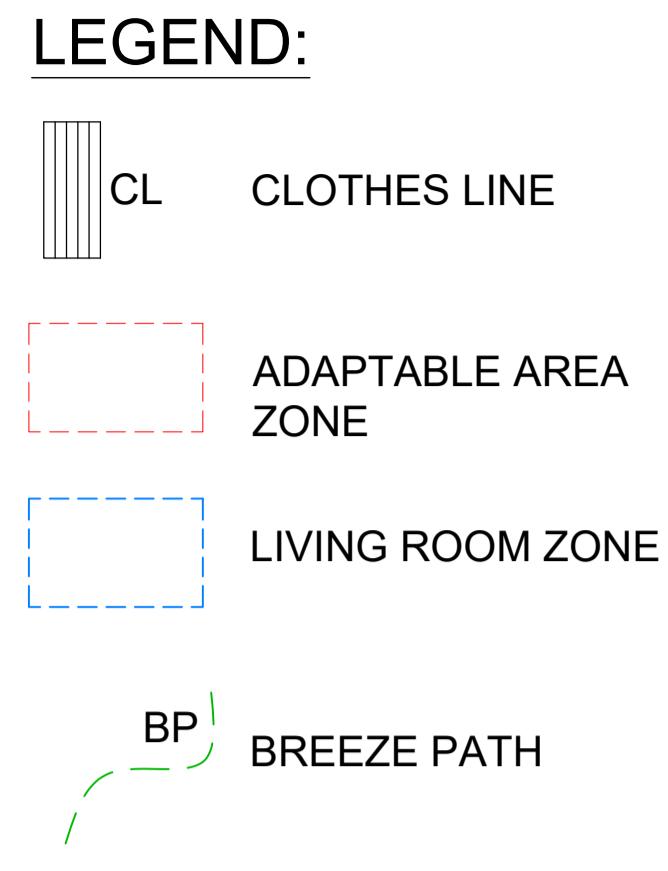APARTMENT 17 - 12.30m<sup>3</sup>  
BASEMENT STORAGE- 6.0m<sup>3</sup>  
TOTAL- 18.30m<sup>3</sup>

APARTMENT 18 - 14.60m<sup>3</sup>  
BASEMENT STORAGE- 6.0m<sup>3</sup>  
TOTAL- 20.60m<sup>3</sup>

APARTMENT 19 - 14.60m<sup>3</sup>  
BASEMENT STORAGE- 6.0m<sup>3</sup>  
TOTAL- 20.60m<sup>3</sup>



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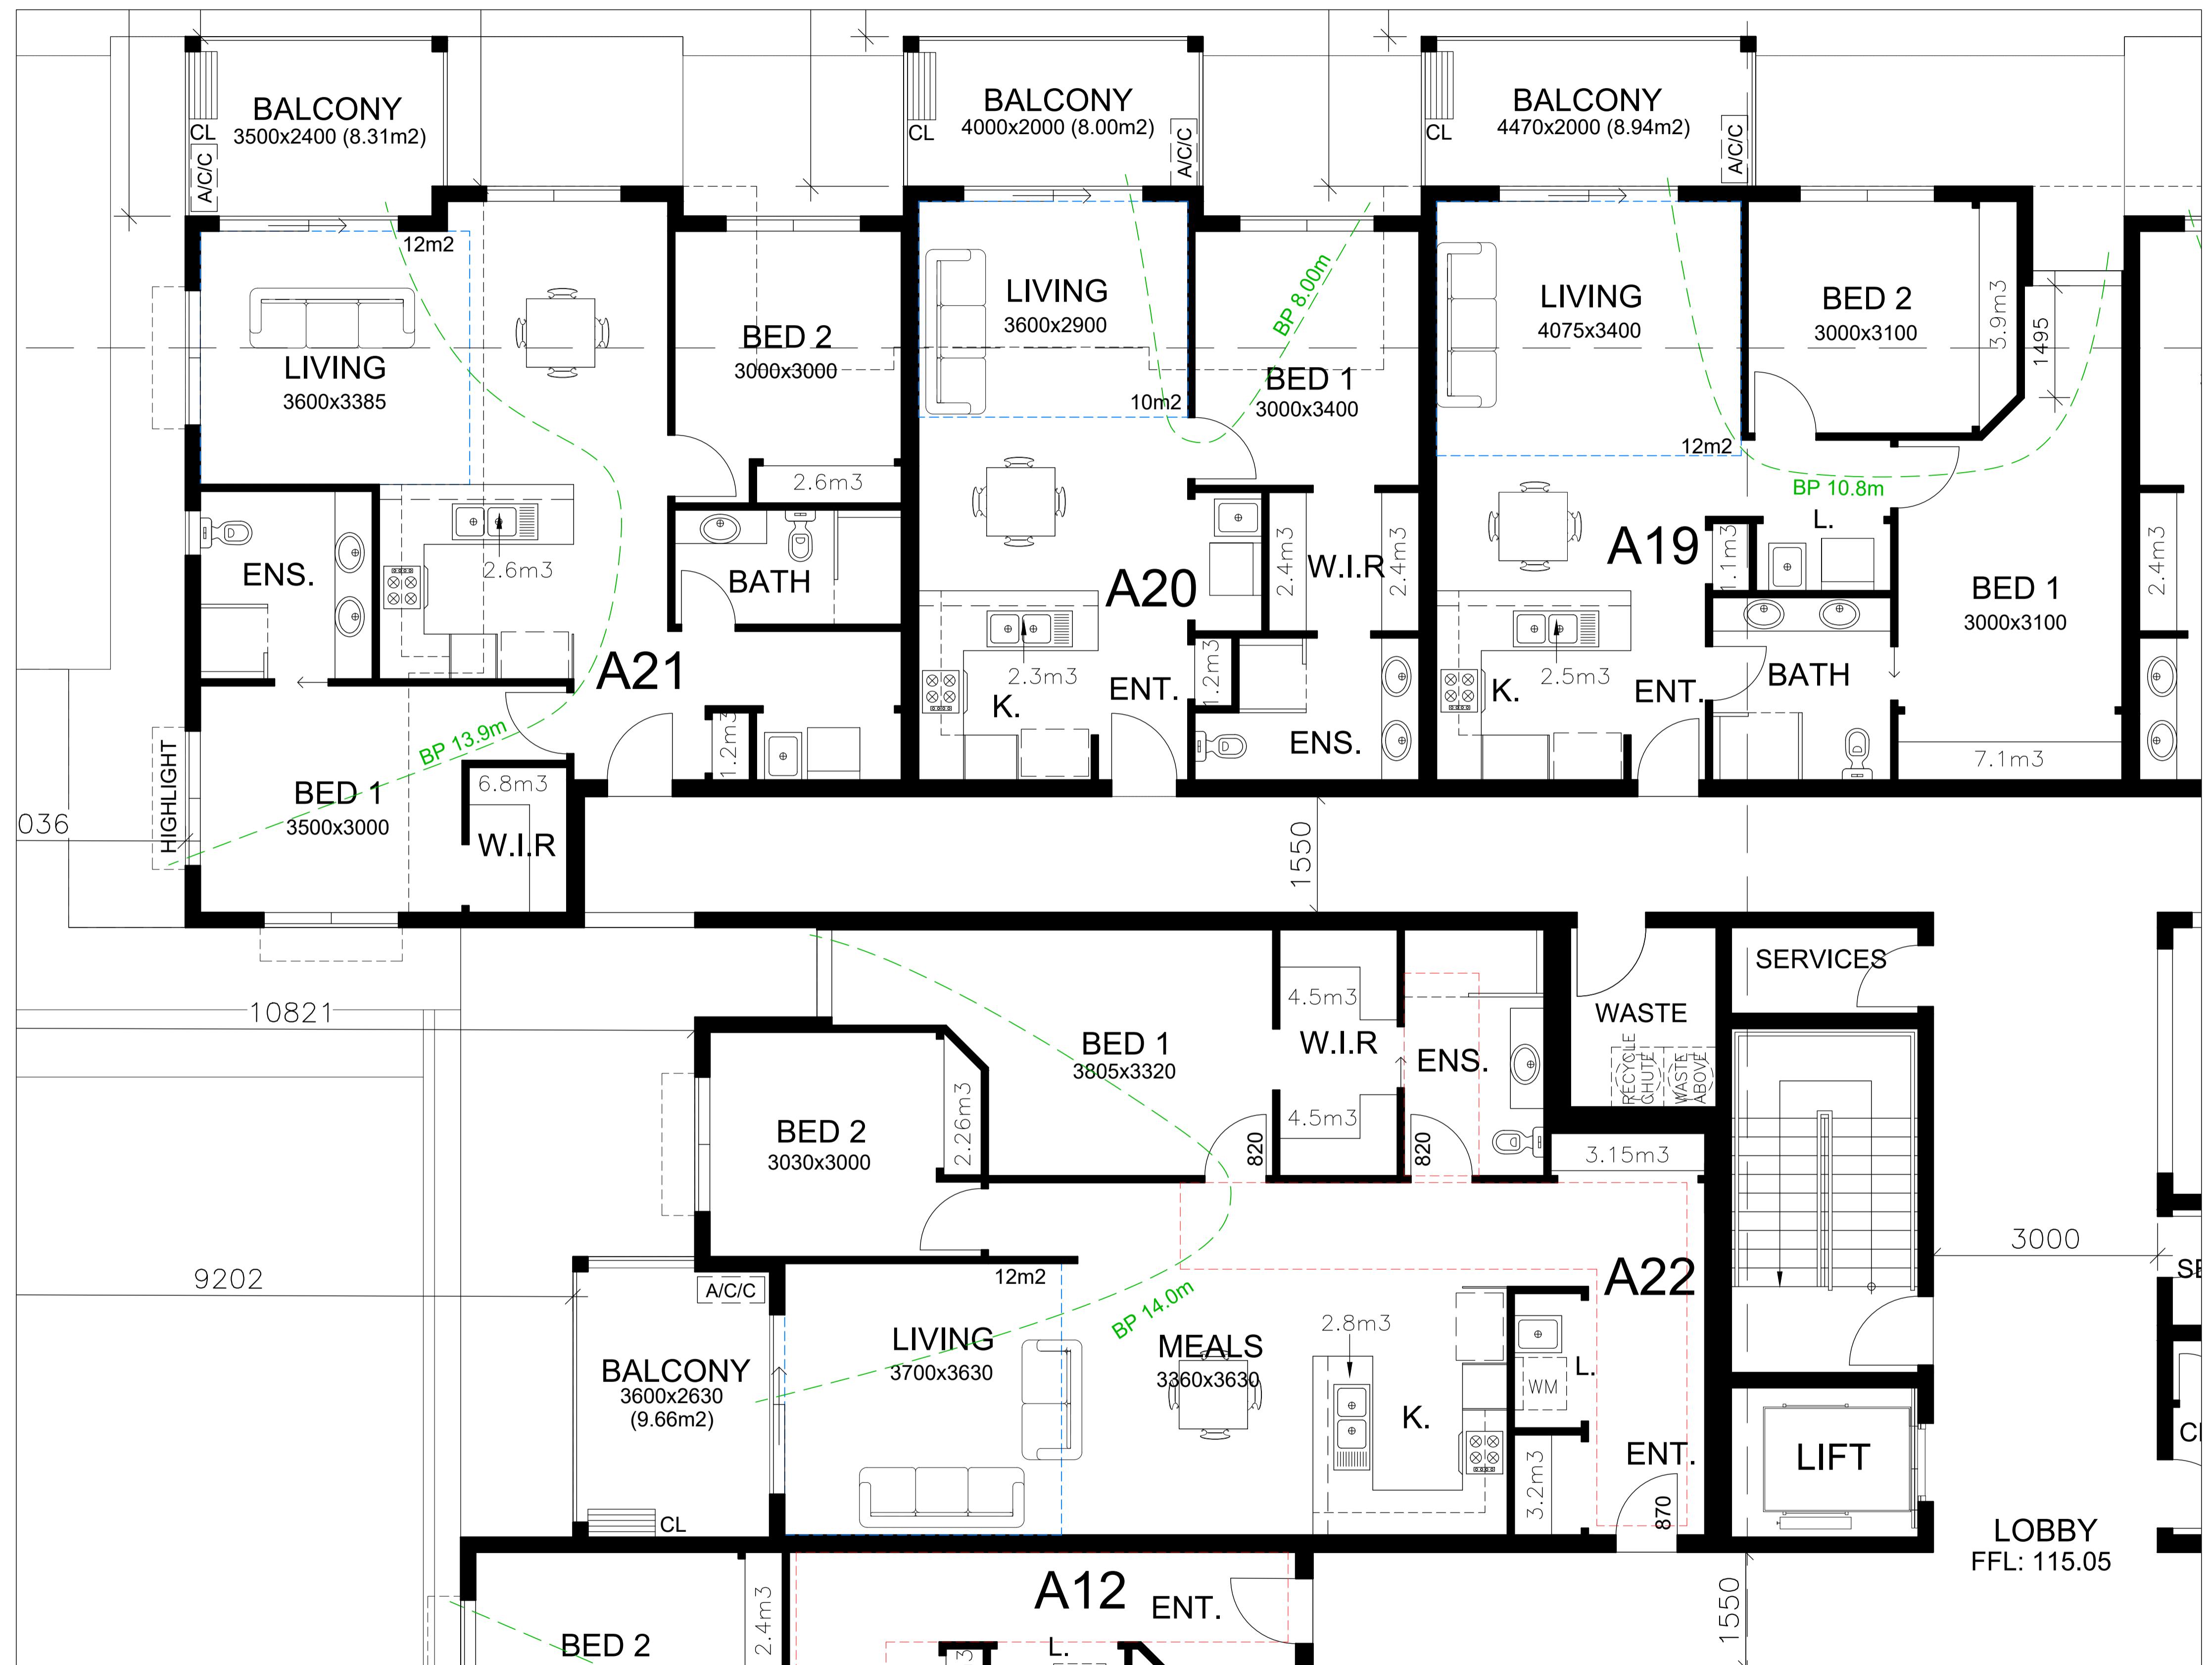
DATE: AMENDMENT:  
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22/04/20 COUNCIL RFI

PROJECT:  
PROPOSED APARTMENT  
DEVELOPMENT  
AT: No. 969–973,  
DONCASTER ROAD,  
DONCASTER EAST

FOR : ZHOU PROJECT	MAP
MELWAY REF:	1659-2
DATE: APRIL 20	SCALE: 1:50
SHEET: 14 OF 25	REFERENCE NO:
DRAWN: A.M.	1659-2

# APARTMENTS 20, 21 & 22 FLOORPLANS

SCALE 1:50



# **PLANNING AND ENVIRONMENT ACT 1987**

## **MANNINGHAM PLANNING SCHEME**

## **ADVERTISED PLANS**

**Planning Application Number: PLN19/0226**  
**Date: 11 May 2020**  
**Sheet 15 of 25**

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## LEGEND:



# CL CLOTHES LINE

# ADAPTABLE AREA ZONE

## LIVING ROOM Z

# ADAPTABLE APARTMENTS:

**APARTMENT 22 - ADAPTABLE**


---

**STORAGE VOLUME:**

APARTMENT 20 -	8.3m <sup>3</sup>
BASEMENT STORAGE-	6.0m <sup>3</sup>
<b>TOTAL-</b>	<b>14.30m<sup>3</sup></b>

**APARTMENT 21 - 13.20m<sup>3</sup>**  
**BASEMENT STORAGE- 6.0m<sup>3</sup>**  
**TOTAL- 19.20m<sup>3</sup>**

APARTMENT 22 - 20.41m<sup>3</sup>  
BASEMENT STORAGE- 6.0m<sup>3</sup>  
TOTAL- 26.41m<sup>3</sup>

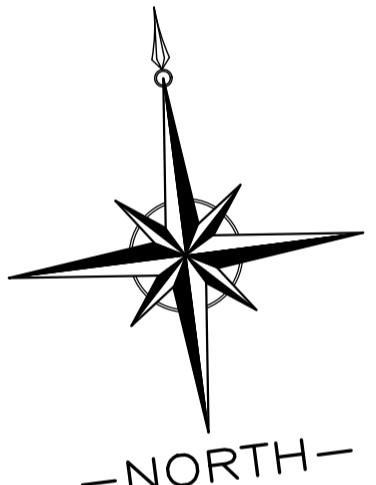

The logo consists of a black square containing a white stylized letter 'e' with a horizontal bar through it, resembling a copyright symbol.

DATE:	AMENDMENT:
/12/19	AMENDED FLOOR PLANS
/01/00	COUNCIL - RELEASER

**PROJECT:  
PROPOSED APARTMENT  
DEVELOPMENT**

AT: No. 969-973,  
DONCASTER ROAD,  
DONCASTER EAST


QR : ZHOU PROJECT

EL WAY REF: M

DATE: APRIL 20 SCALE: 1:50

PAGE: 15 OF 25


1659-2

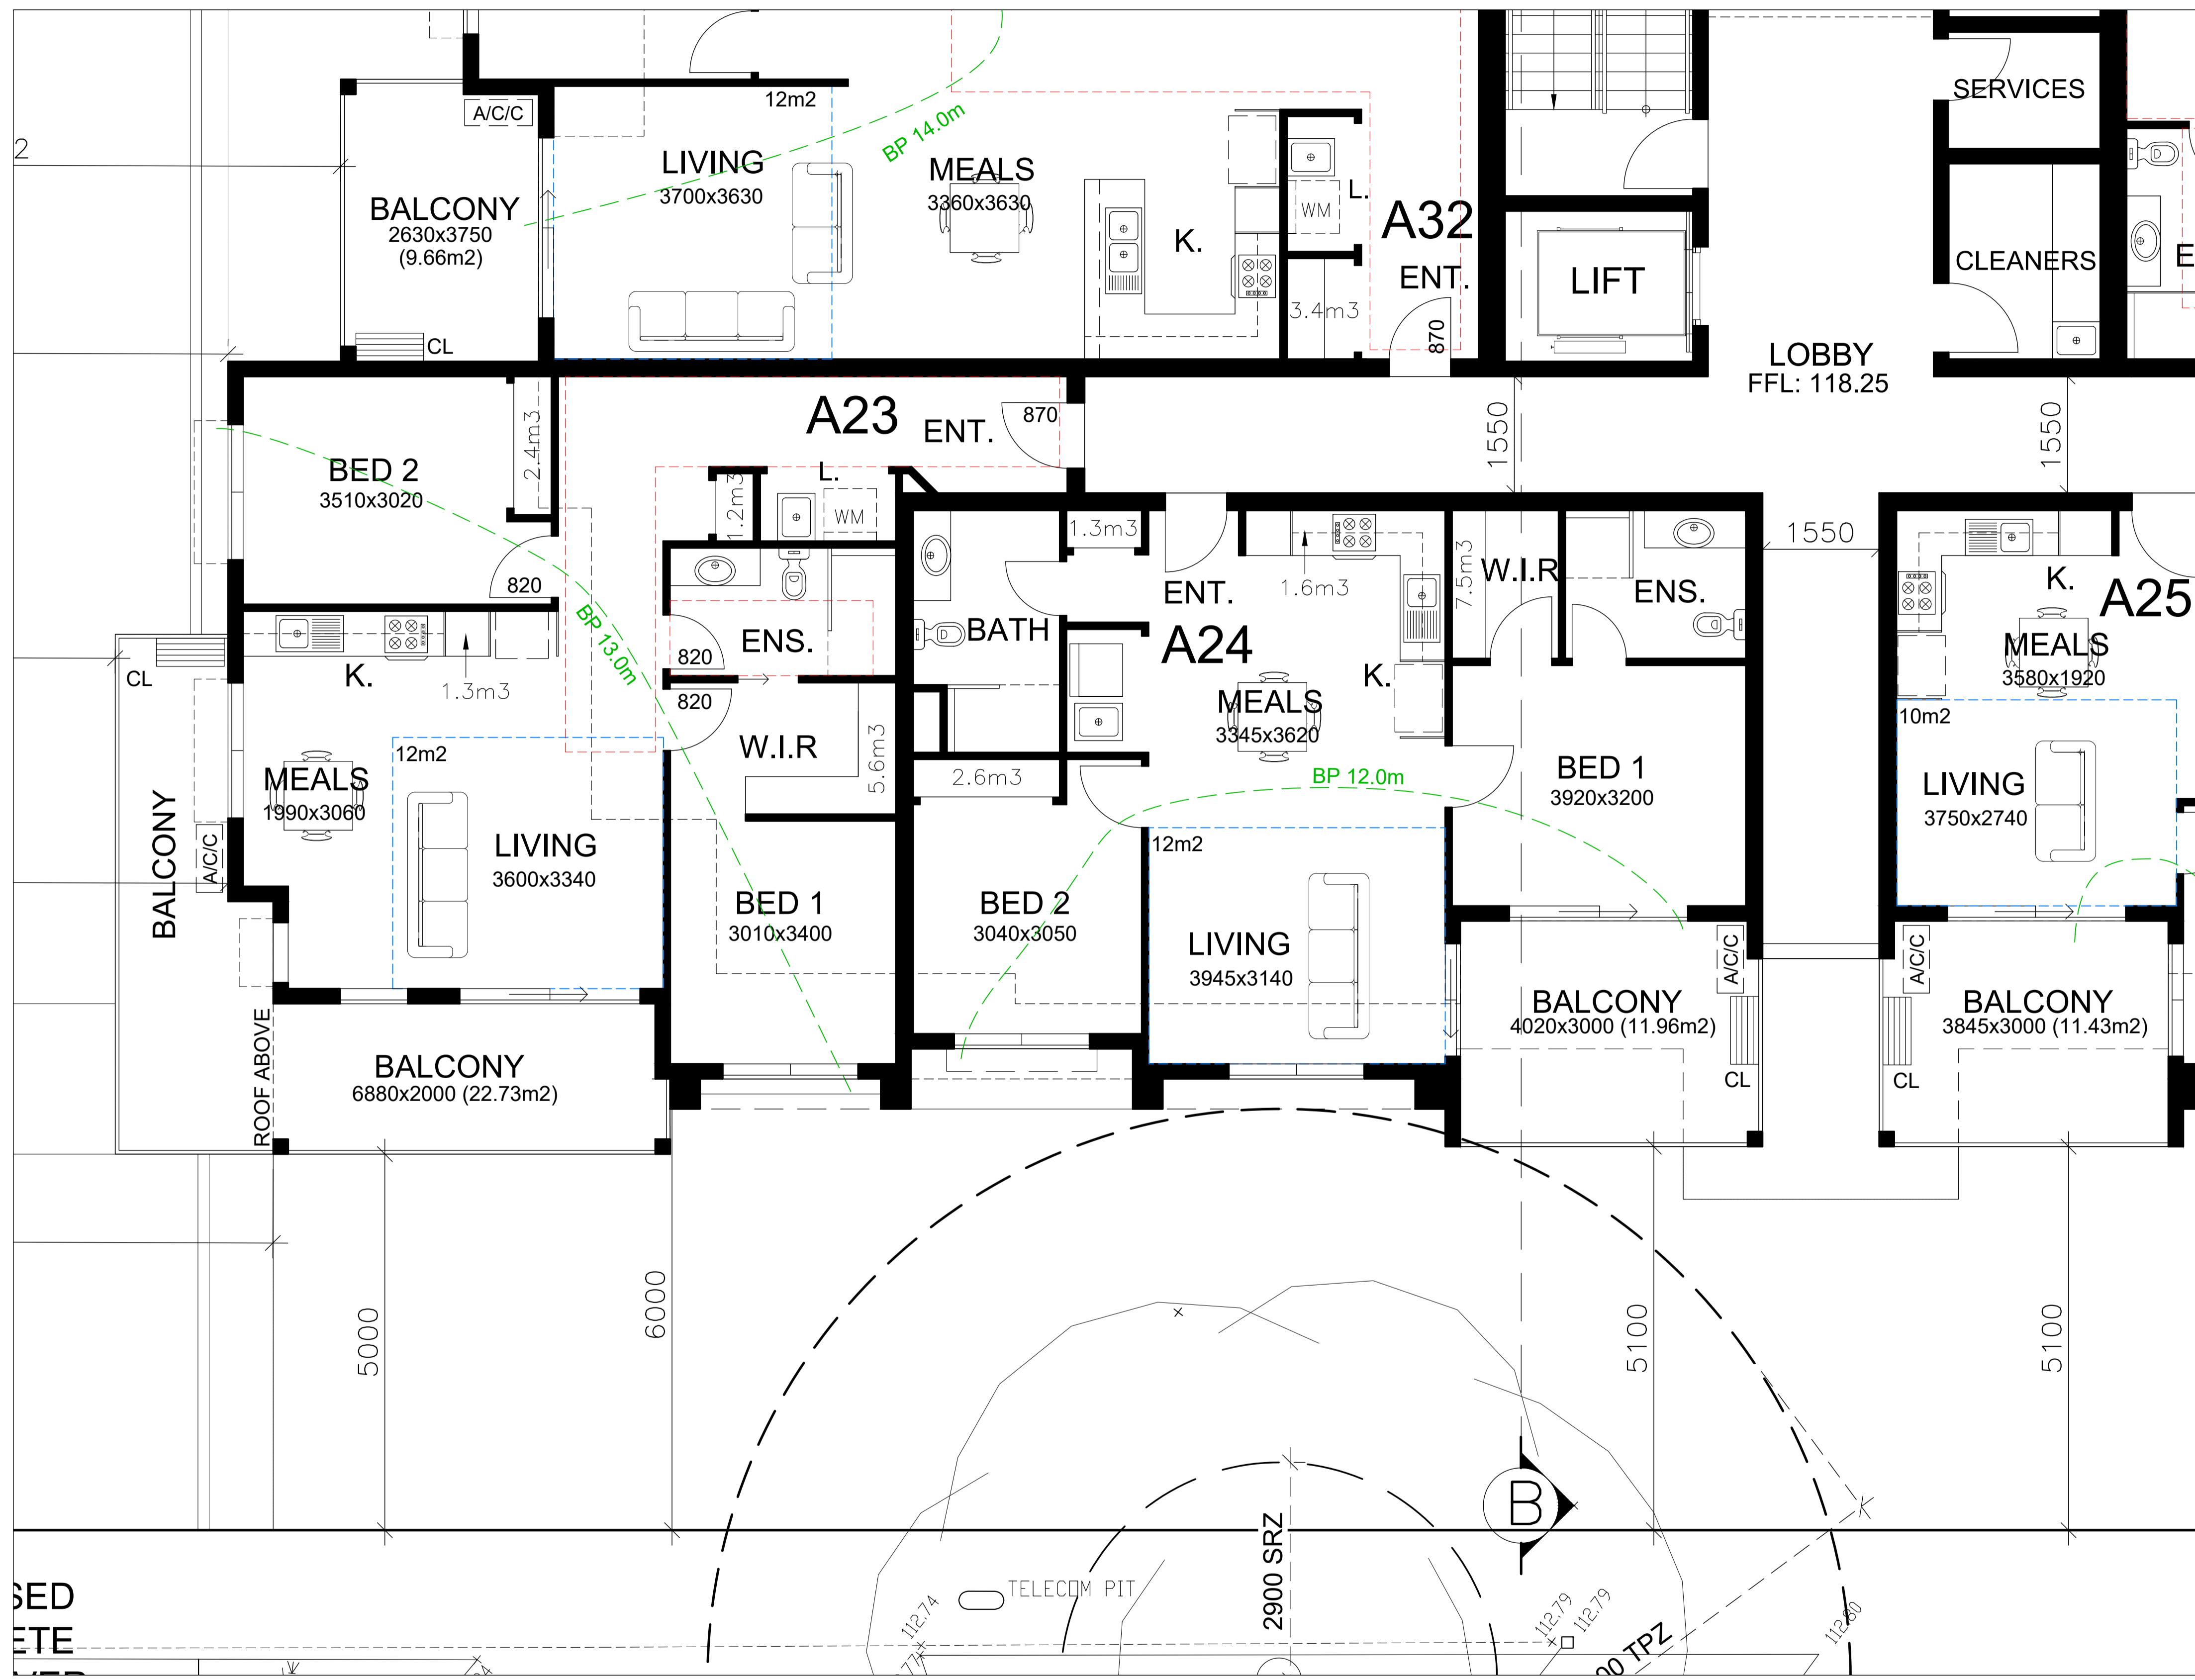

## APARTMENTS 23 & 24 FLOORPLANS

SCALE 1:50

PLANNING AND ENVIRONMENT ACT 1987  
MANNINGHAM PLANNING SCHEME  
  
ADVERTISED PLANS  
  
Planning Application Number: PLN19/0226  
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Sheet 16 of 25  
  
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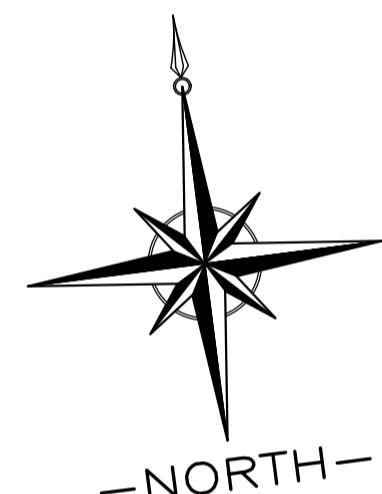
### ADAPTABLE APARTMENTS:

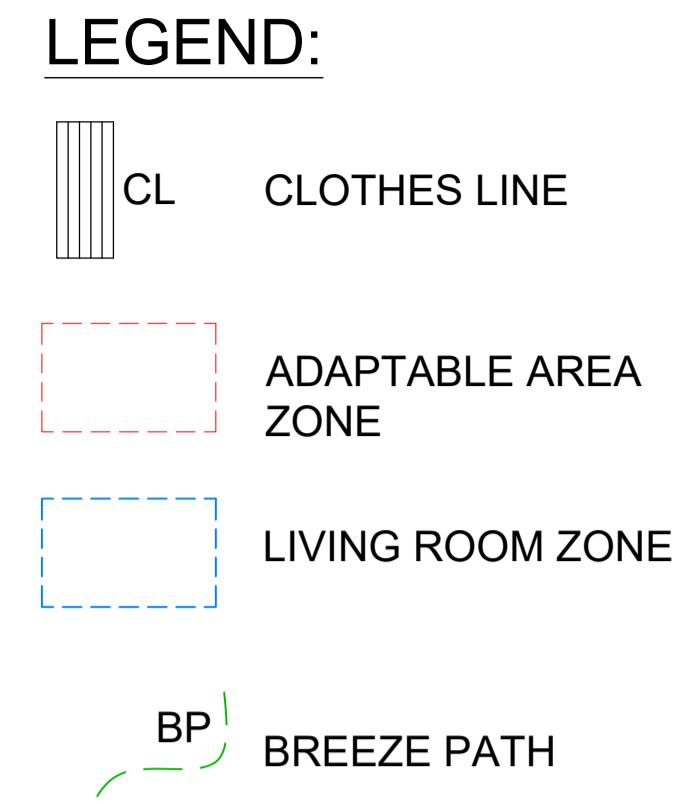APARTMENT 23 - ADAPTABLE

### STORAGE VOLUME:

APARTMENT 23 - 10.5m³  
BASEMENT STORAGE- 6.0m³  
TOTAL- 16.50m³

APARTMENT 24 - 13.0m³  
BASEMENT STORAGE- 6.8m³  
TOTAL- 19.80m³





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DATE:	AMENDMENT:
20/12/19	AMENDED FLOOR PLANS
22/04/20	COUNCIL RFI

PROJECT:  
PROPOSED APARTMENT  
DEVELOPMENT  
AT: No. 969–973,  
DONCASTER ROAD,  
DONCASTER EAST

FOR : ZHOU PROJECT	MAP
MELWAY REF:	DATE: APRIL 20 SCALE: 1:50
SHEET: 16 OF 25	REFERENCE NO:
DRAWN: A.M.	1659-2



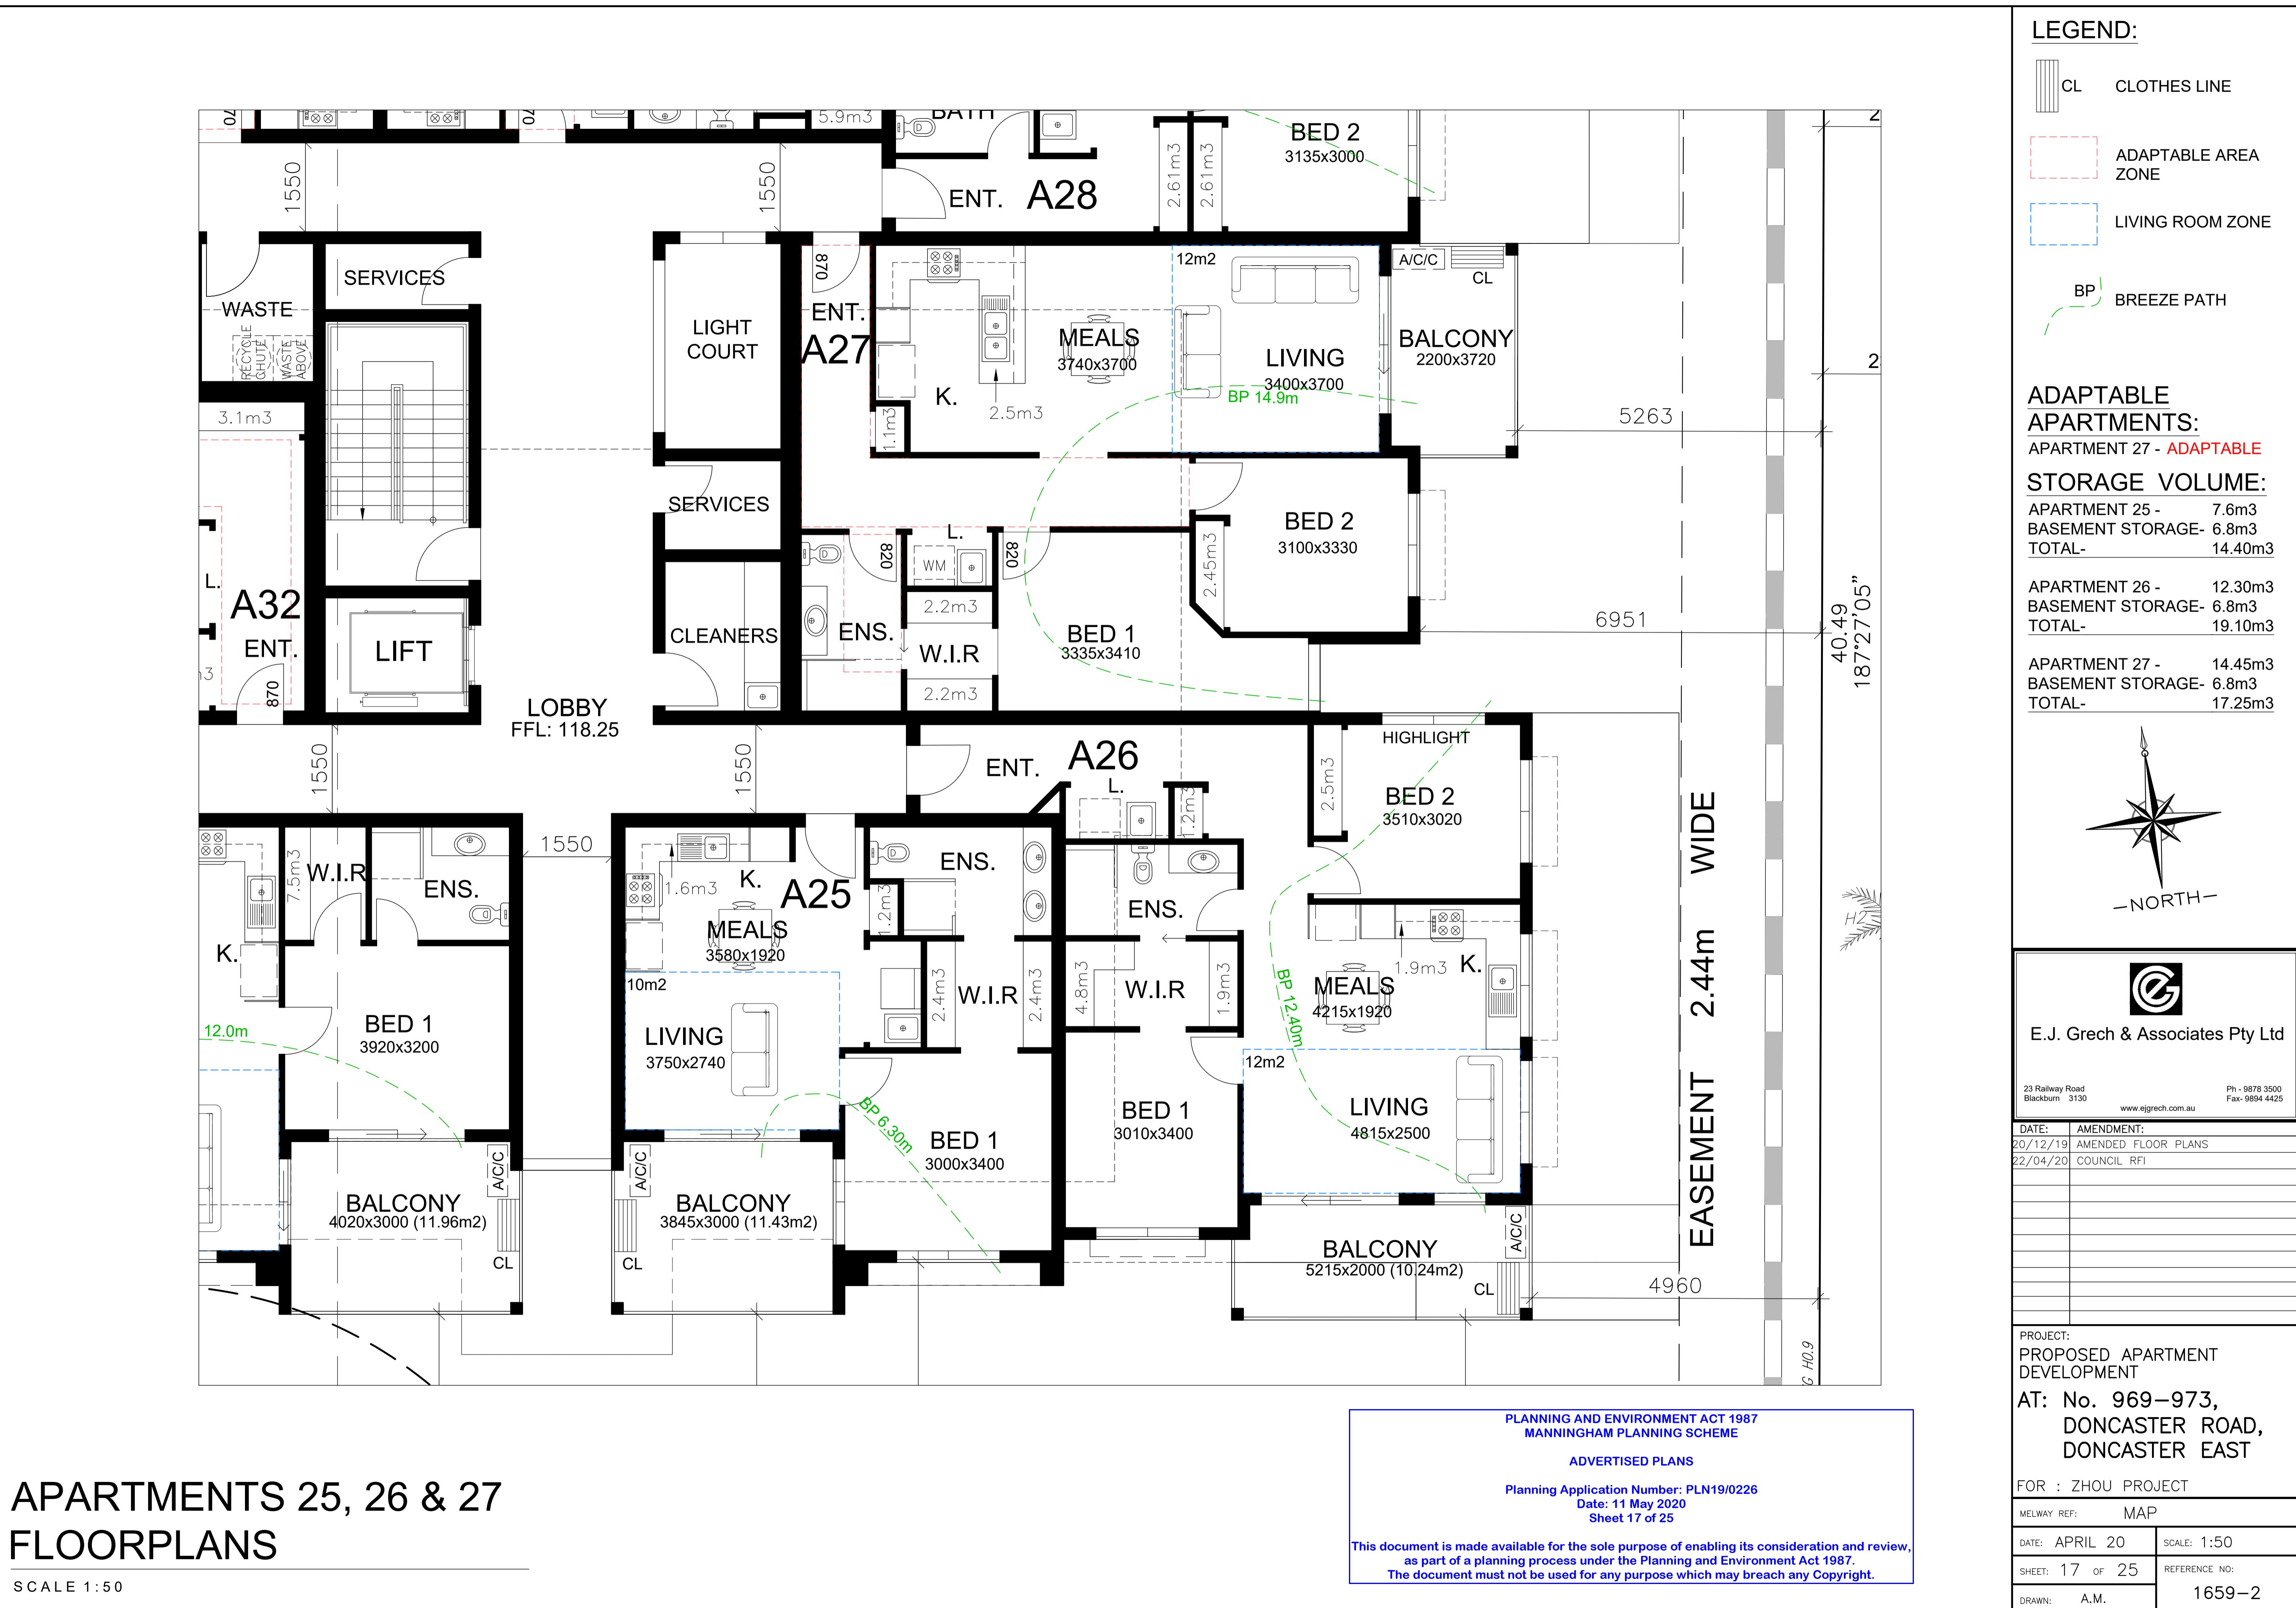

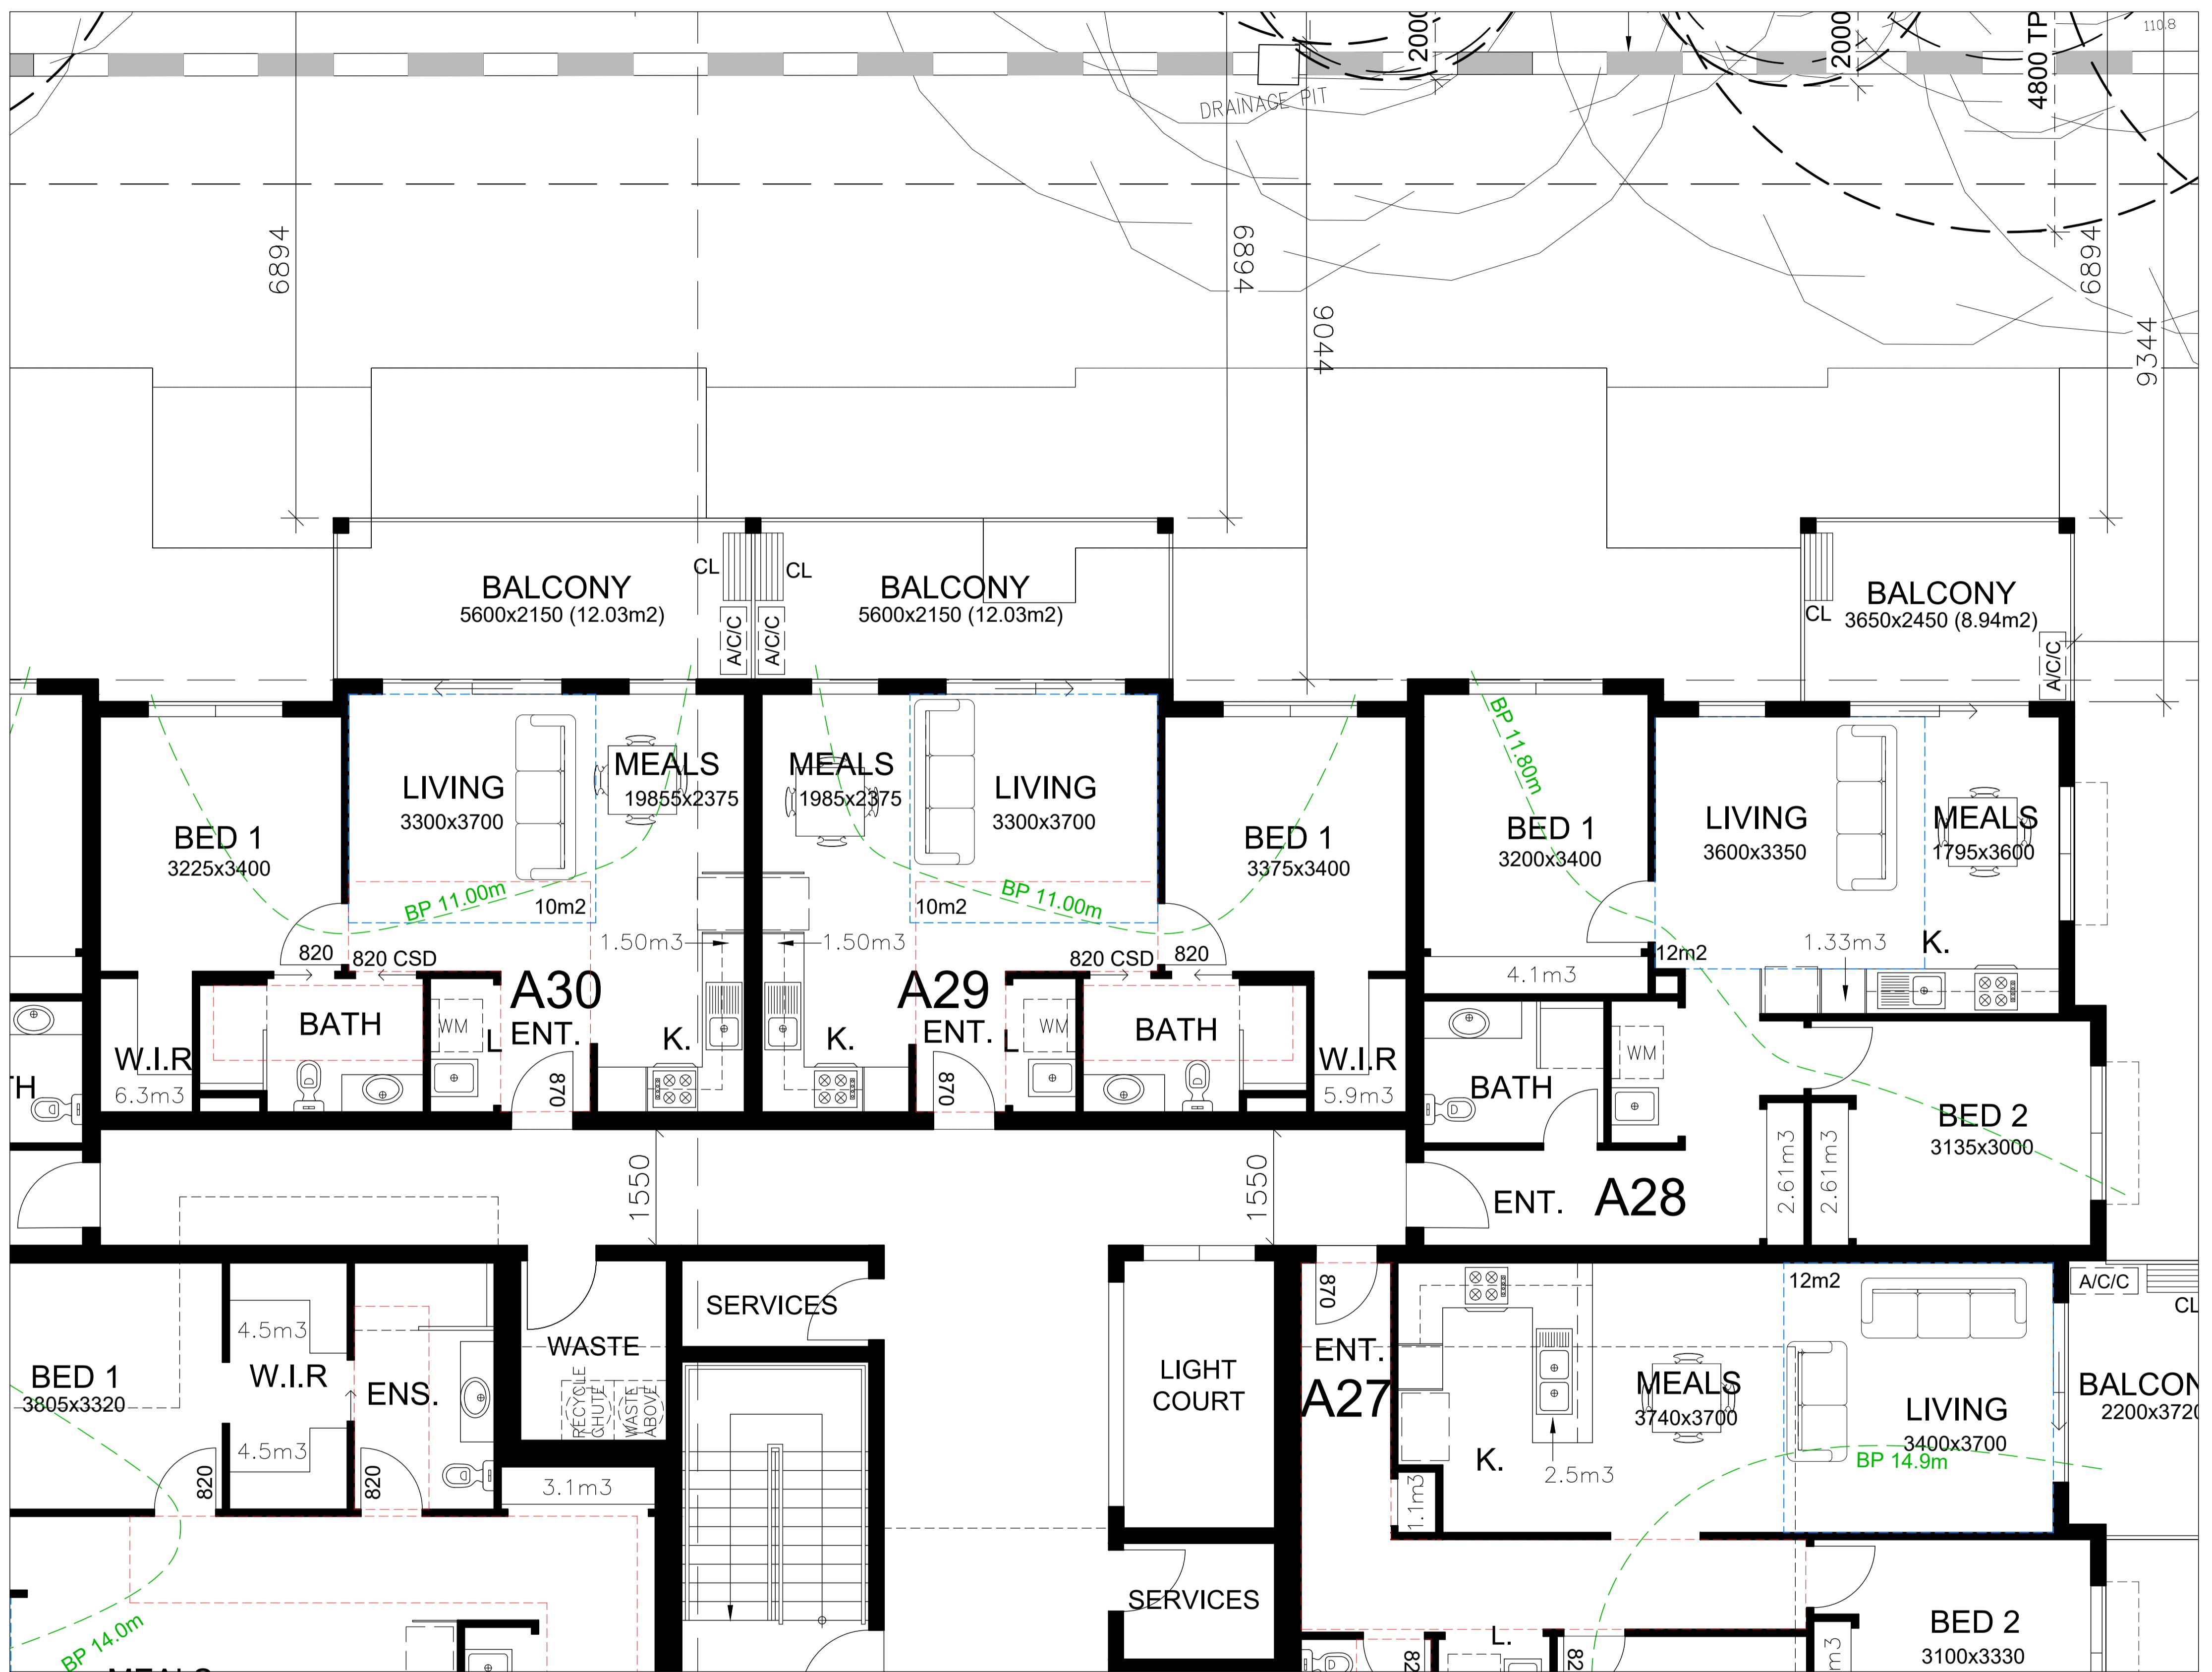PLANNING AND ENVIRONMENT ACT 1987  
MANNINGHAM PLANNING SCHEME

ADVERTISED PLANS

Planning Application Number: PLN19/0226  
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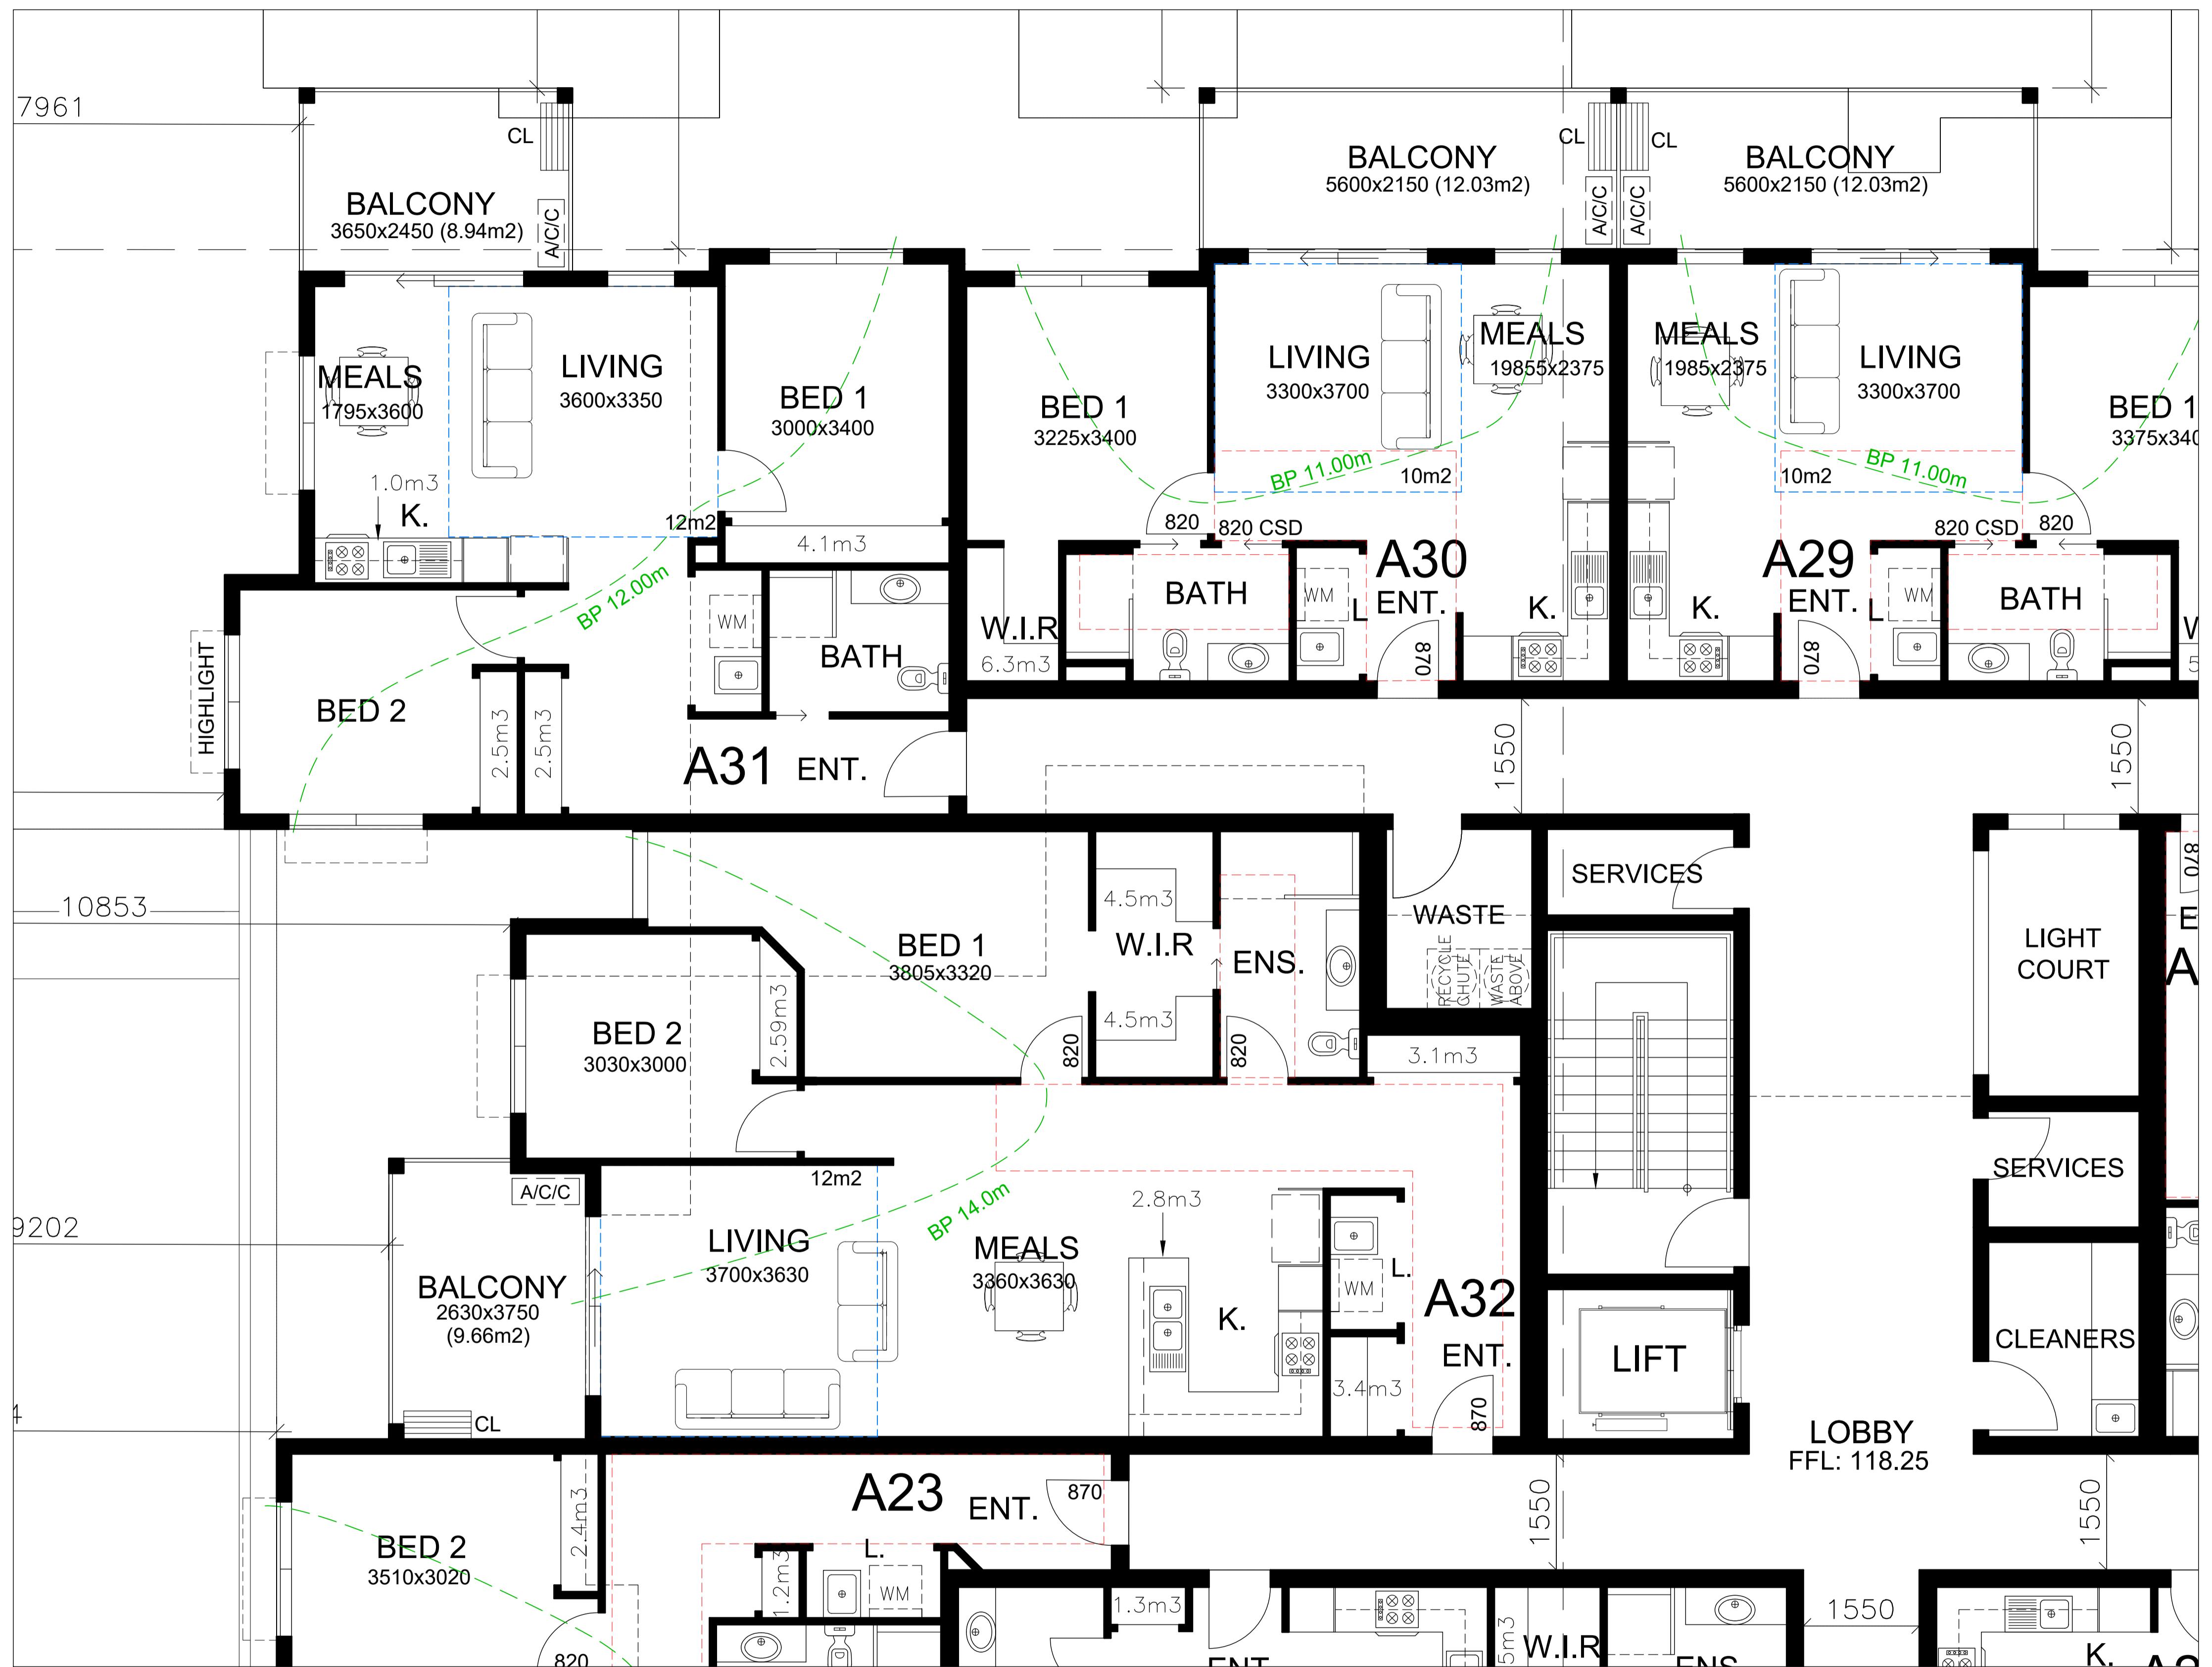
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22/04/20 COUNCIL RFI

PROJECT:  
PROPOSED APARTMENT DEVELOPMENT  
AT: No. 969–973,  
DONCASTER ROAD,  
DONCASTER EAST

FOR : ZHOU PROJECT	MAP
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DATE: APRIL 20	SCALE: 1:50
SHEET: 18 OF 25	REFERENCE NO:
DRAWN: A.M.	1659-2



## APARTMENTS 31 & 32 FLOORPLANS

SCALE 1:50

PLANNING AND ENVIRONMENT ACT 1987  
MANNINGHAM PLANNING SCHEME

ADVERTISED PLANS

Planning Application Number: PLN19/0226  
Date: 11 May 2020  
Sheet 19 of 25

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### LEGEND:

- CL CLOTHES LINE
- ADAPTABLE AREA ZONE
- LIVING ROOM ZONE
- BREEZE PATH


### ADAPTABLE APARTMENTS:

APARTMENT 32 - ADAPTABLE

### STORAGE VOLUME:

APARTMENT 31 -	10.1m <sup>3</sup>
BASEMENT STORAGE-	6.8m <sup>3</sup>
TOTAL-	16.90m <sup>3</sup>

APARTMENT 32 -	20.89m <sup>3</sup>
BASEMENT STORAGE-	6.8m <sup>3</sup>
TOTAL-	27.69m <sup>3</sup>

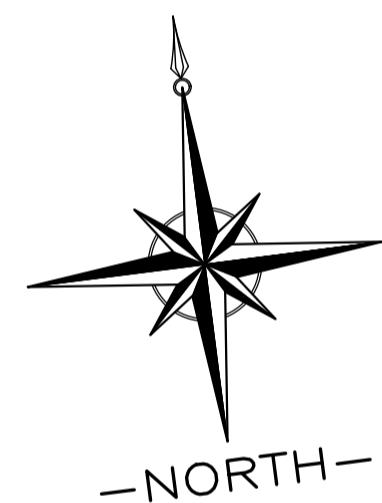


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DATE:	AMENDMENT:
20/12/19	AMENDED FLOOR PLANS
22/04/20	COUNCIL RFI

PROJECT:  
PROPOSED APARTMENT  
DEVELOPMENT  
AT: No. 969–973,  
DONCASTER ROAD,  
DONCASTER EAST

FOR : ZHOU PROJECT	MAP
MELWAY REF:	1659-2
DATE: APRIL 20	SCALE: 1:50
SHEET: 19 OF 25	REFERENCE NO:
DRAWN: A.M.	1659-2



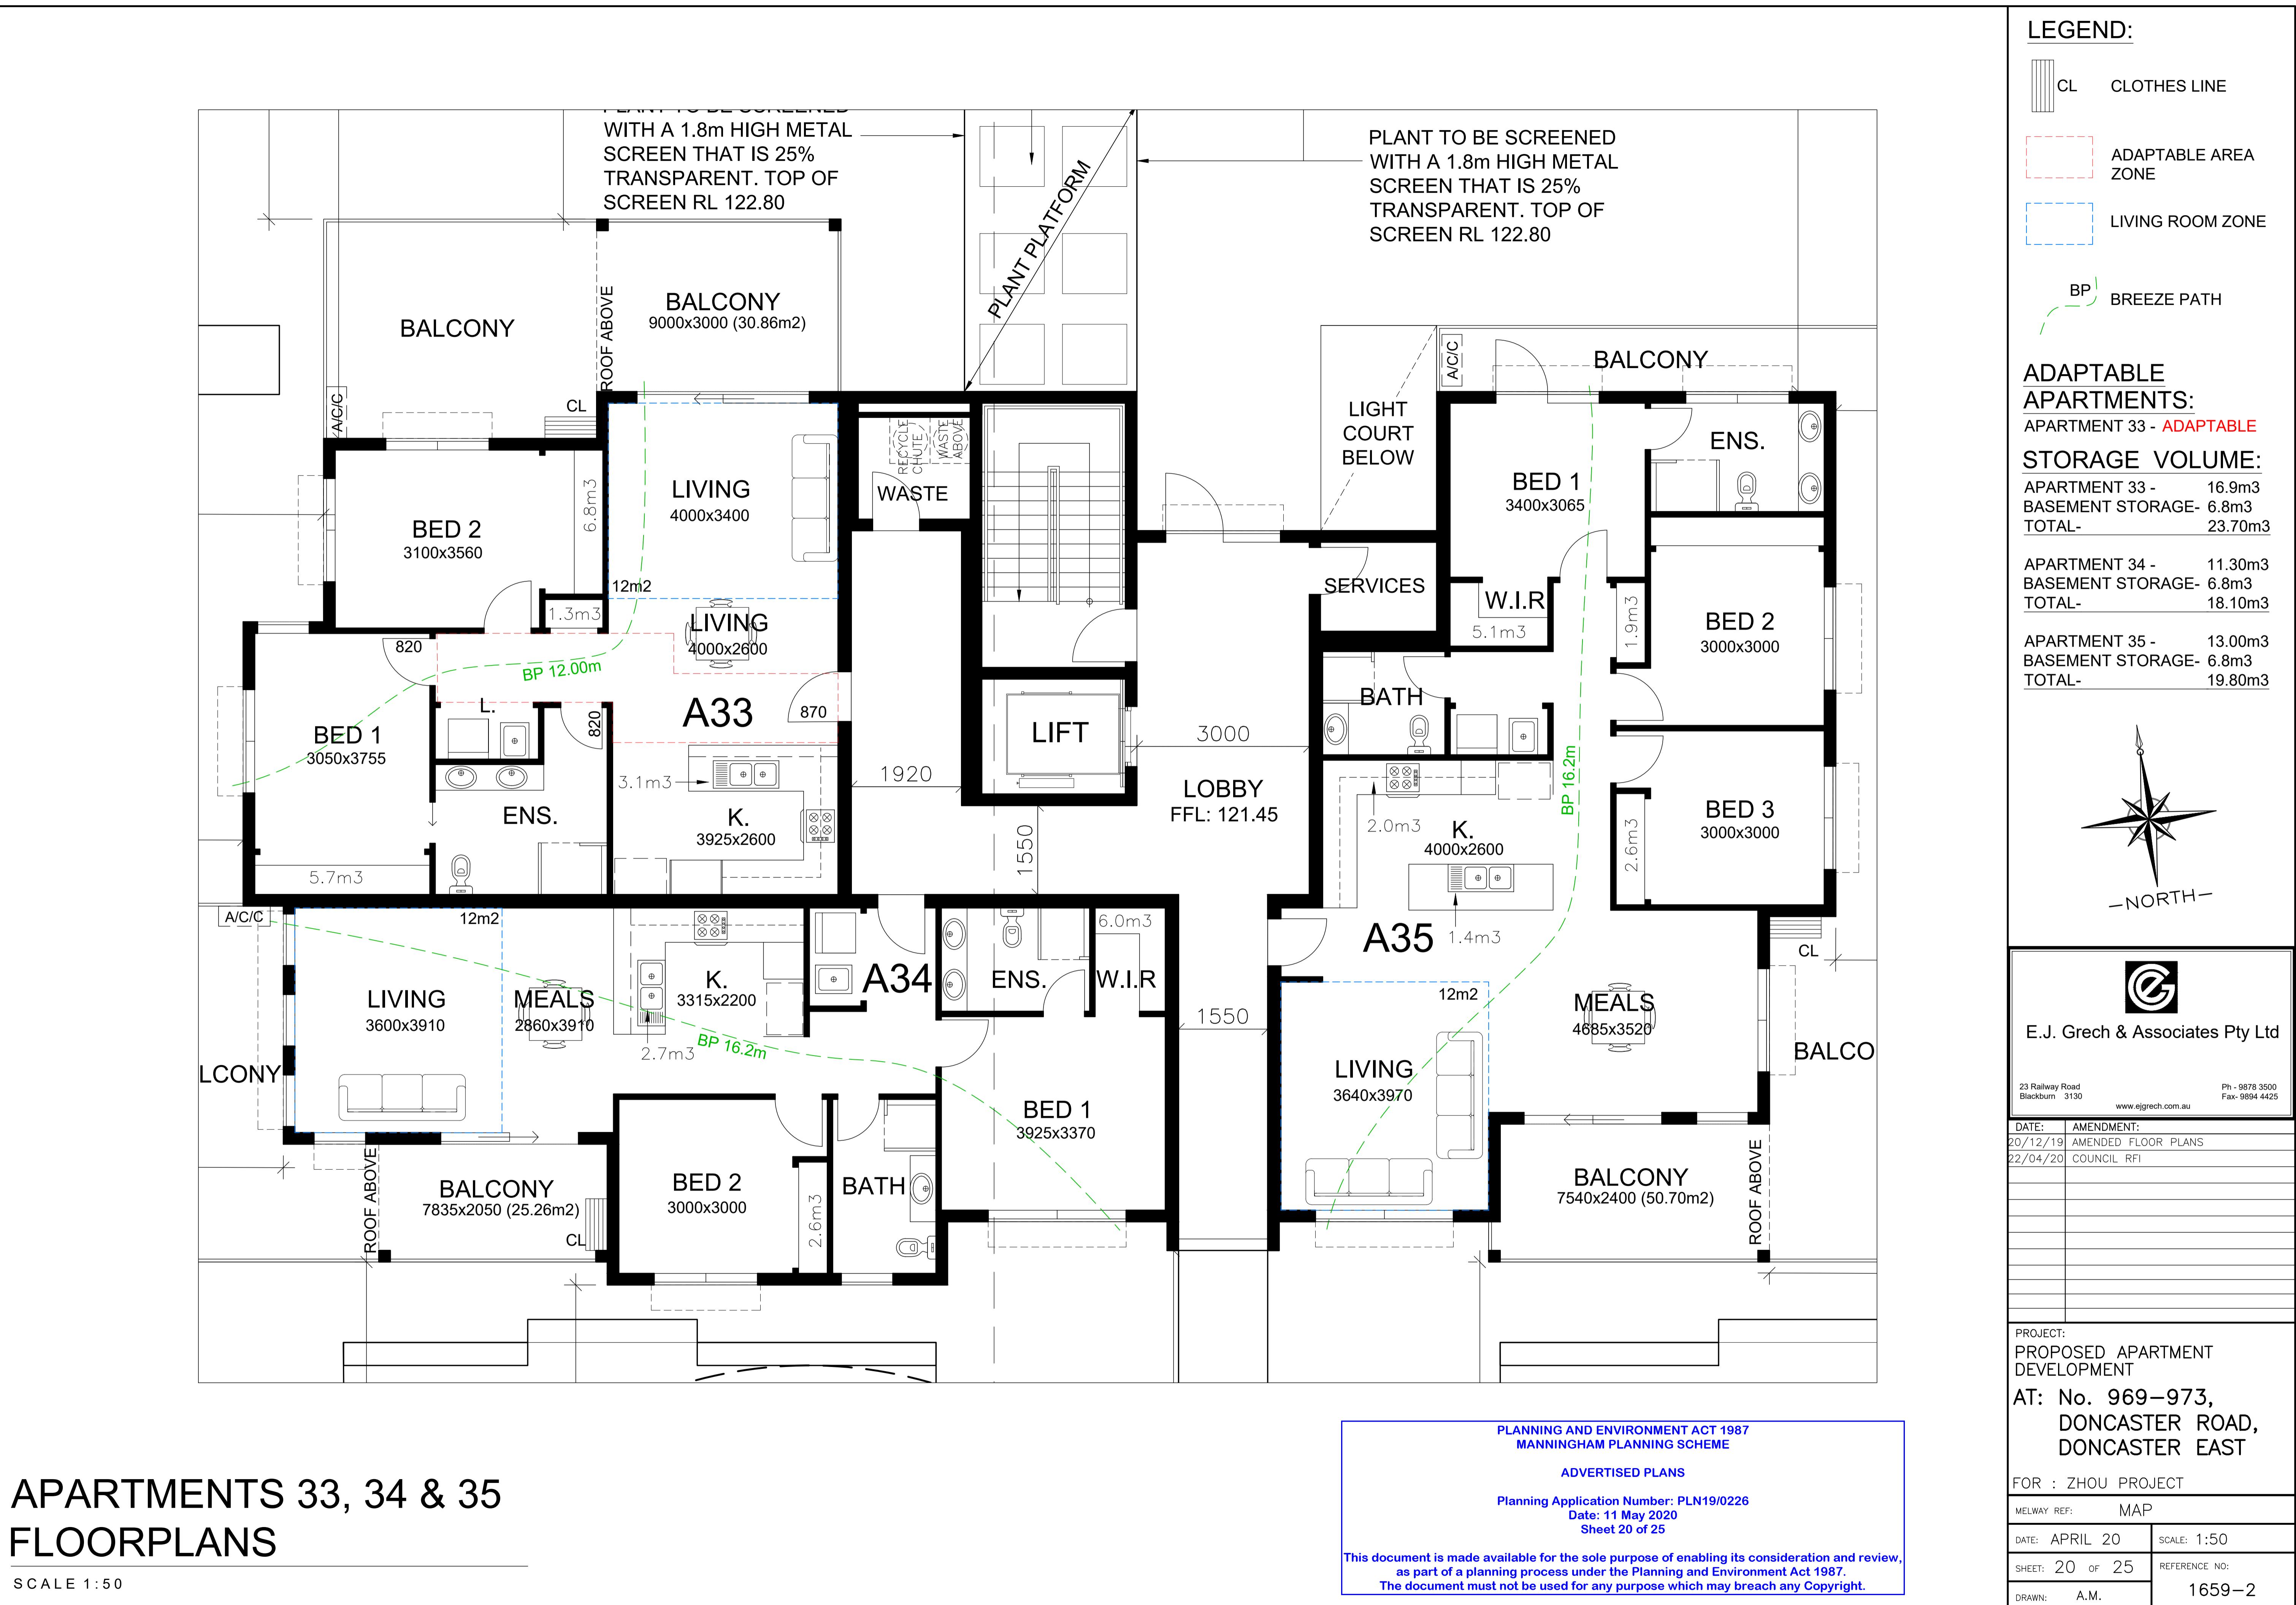


# **PLANNING AND ENVIRONMENT ACT 1987 MANNINGHAM PLANNING SCHEME**

#### **ARMED FORCES PLANS**


**Planning Application Number: PLN19/0226**  
**Date: 11 May 2020**  
**Sheet 22 of 25**

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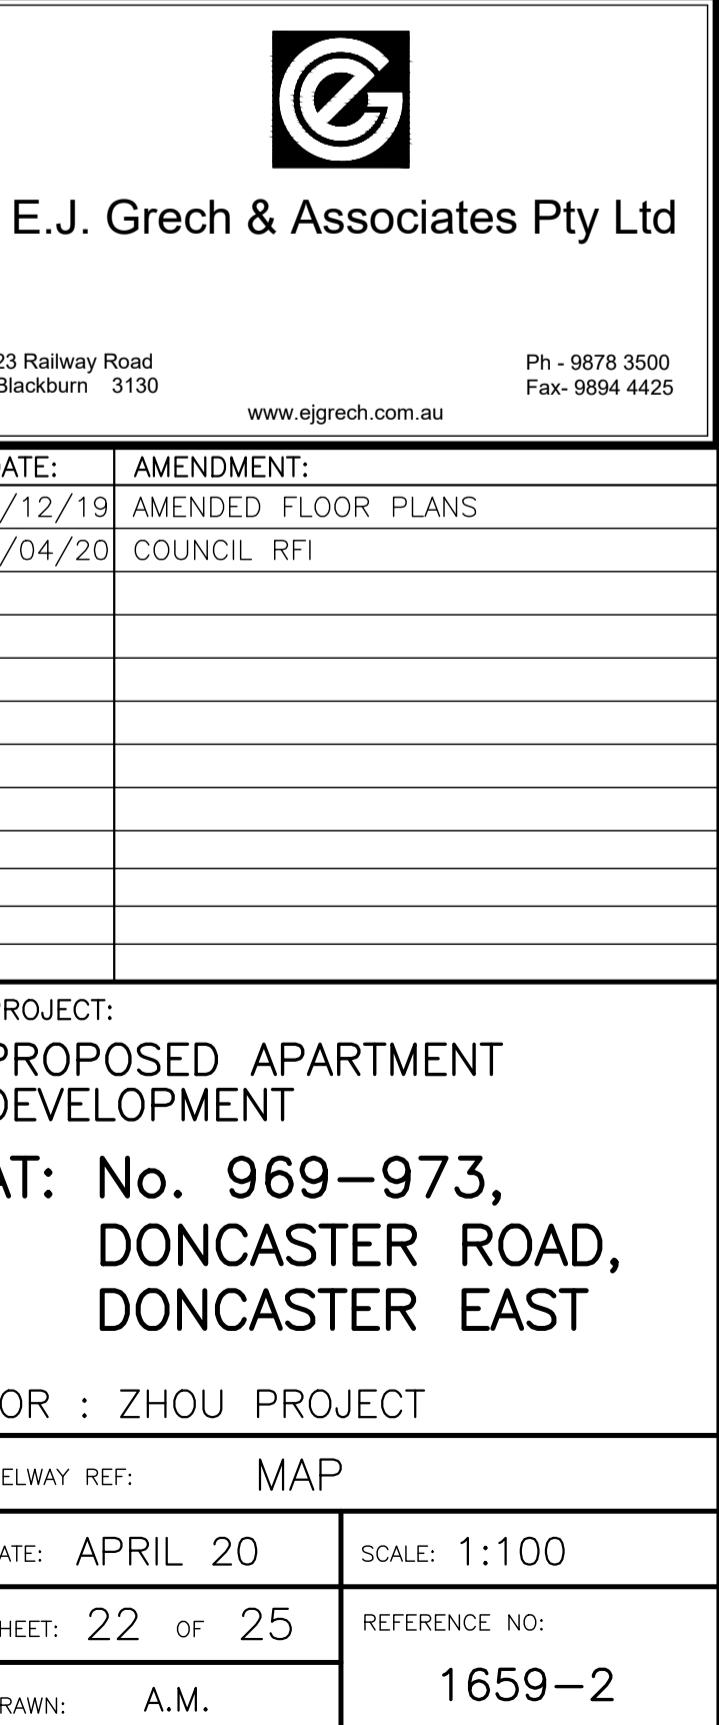
# EAST ELEVATION

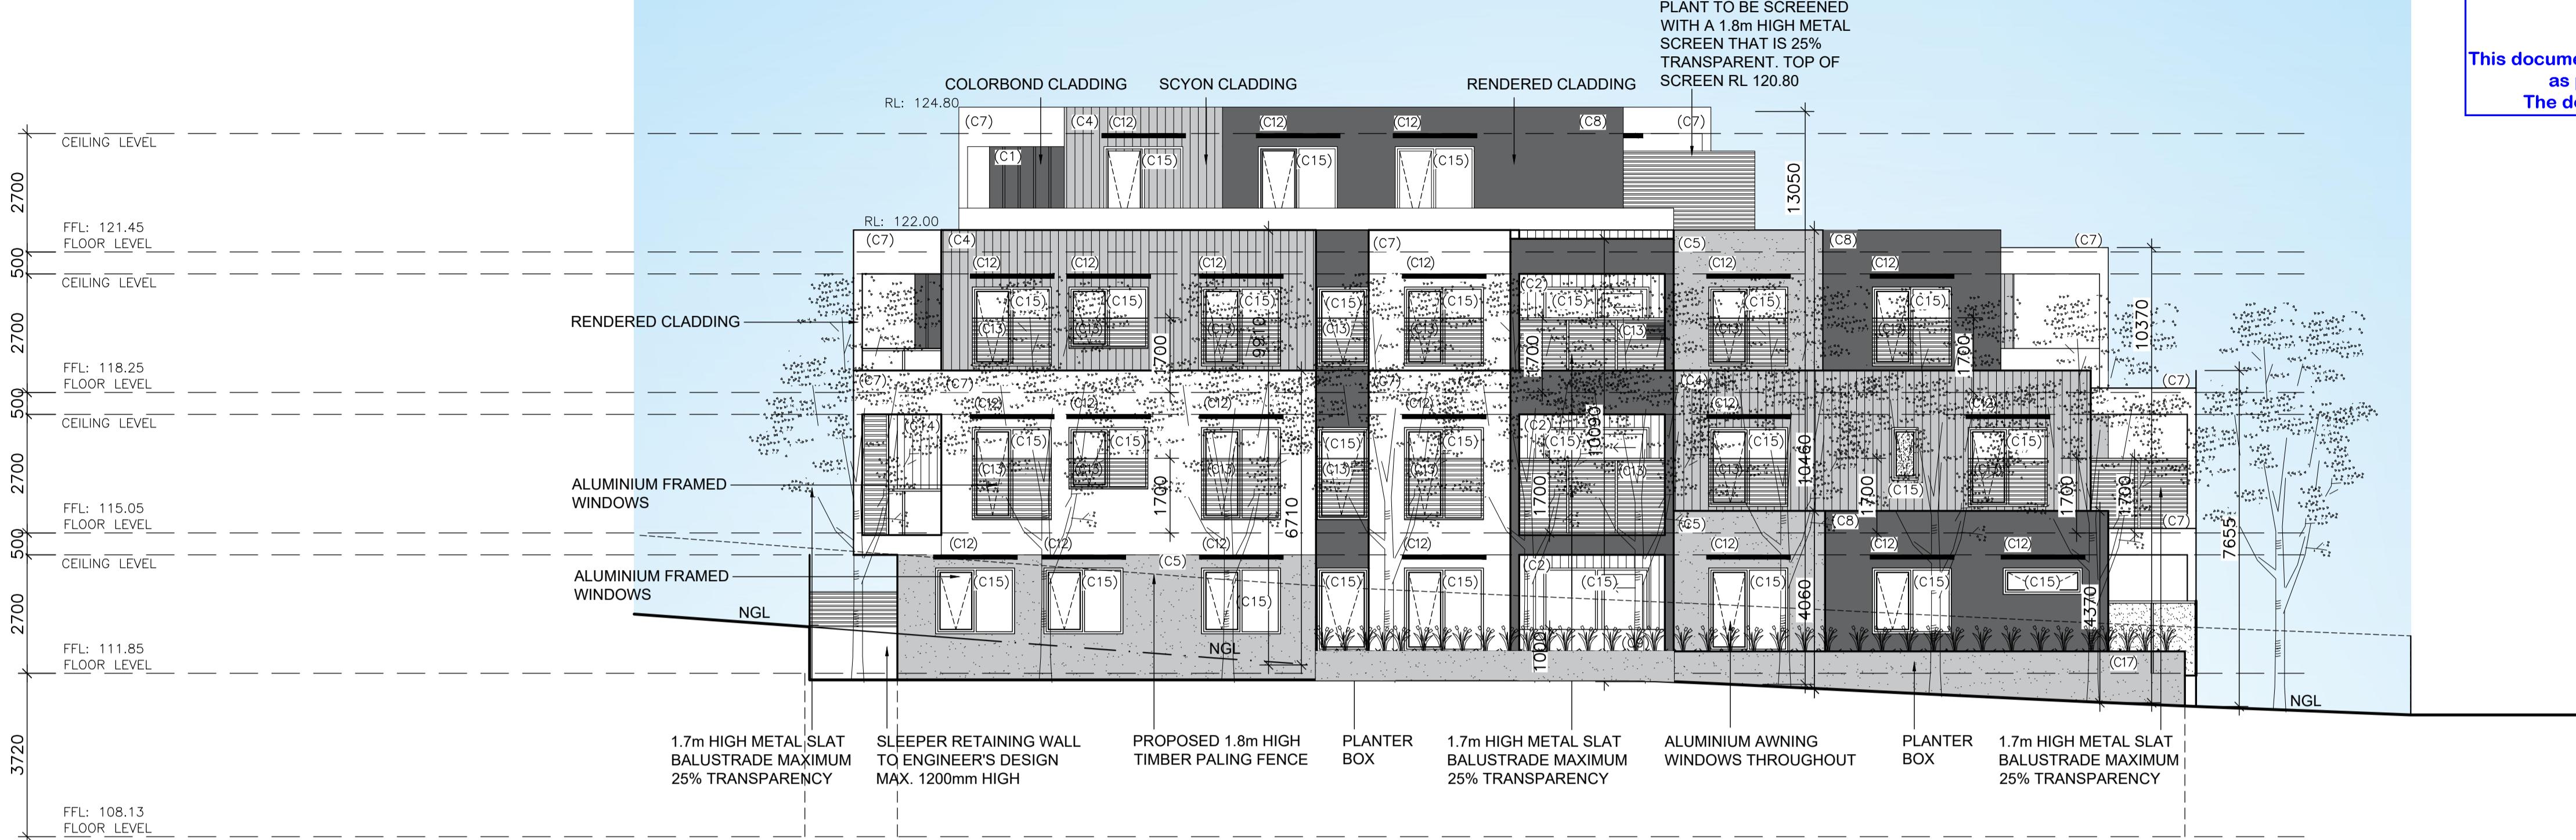SCALE 1:100



# WEST ELEVATION /SECTION A-A

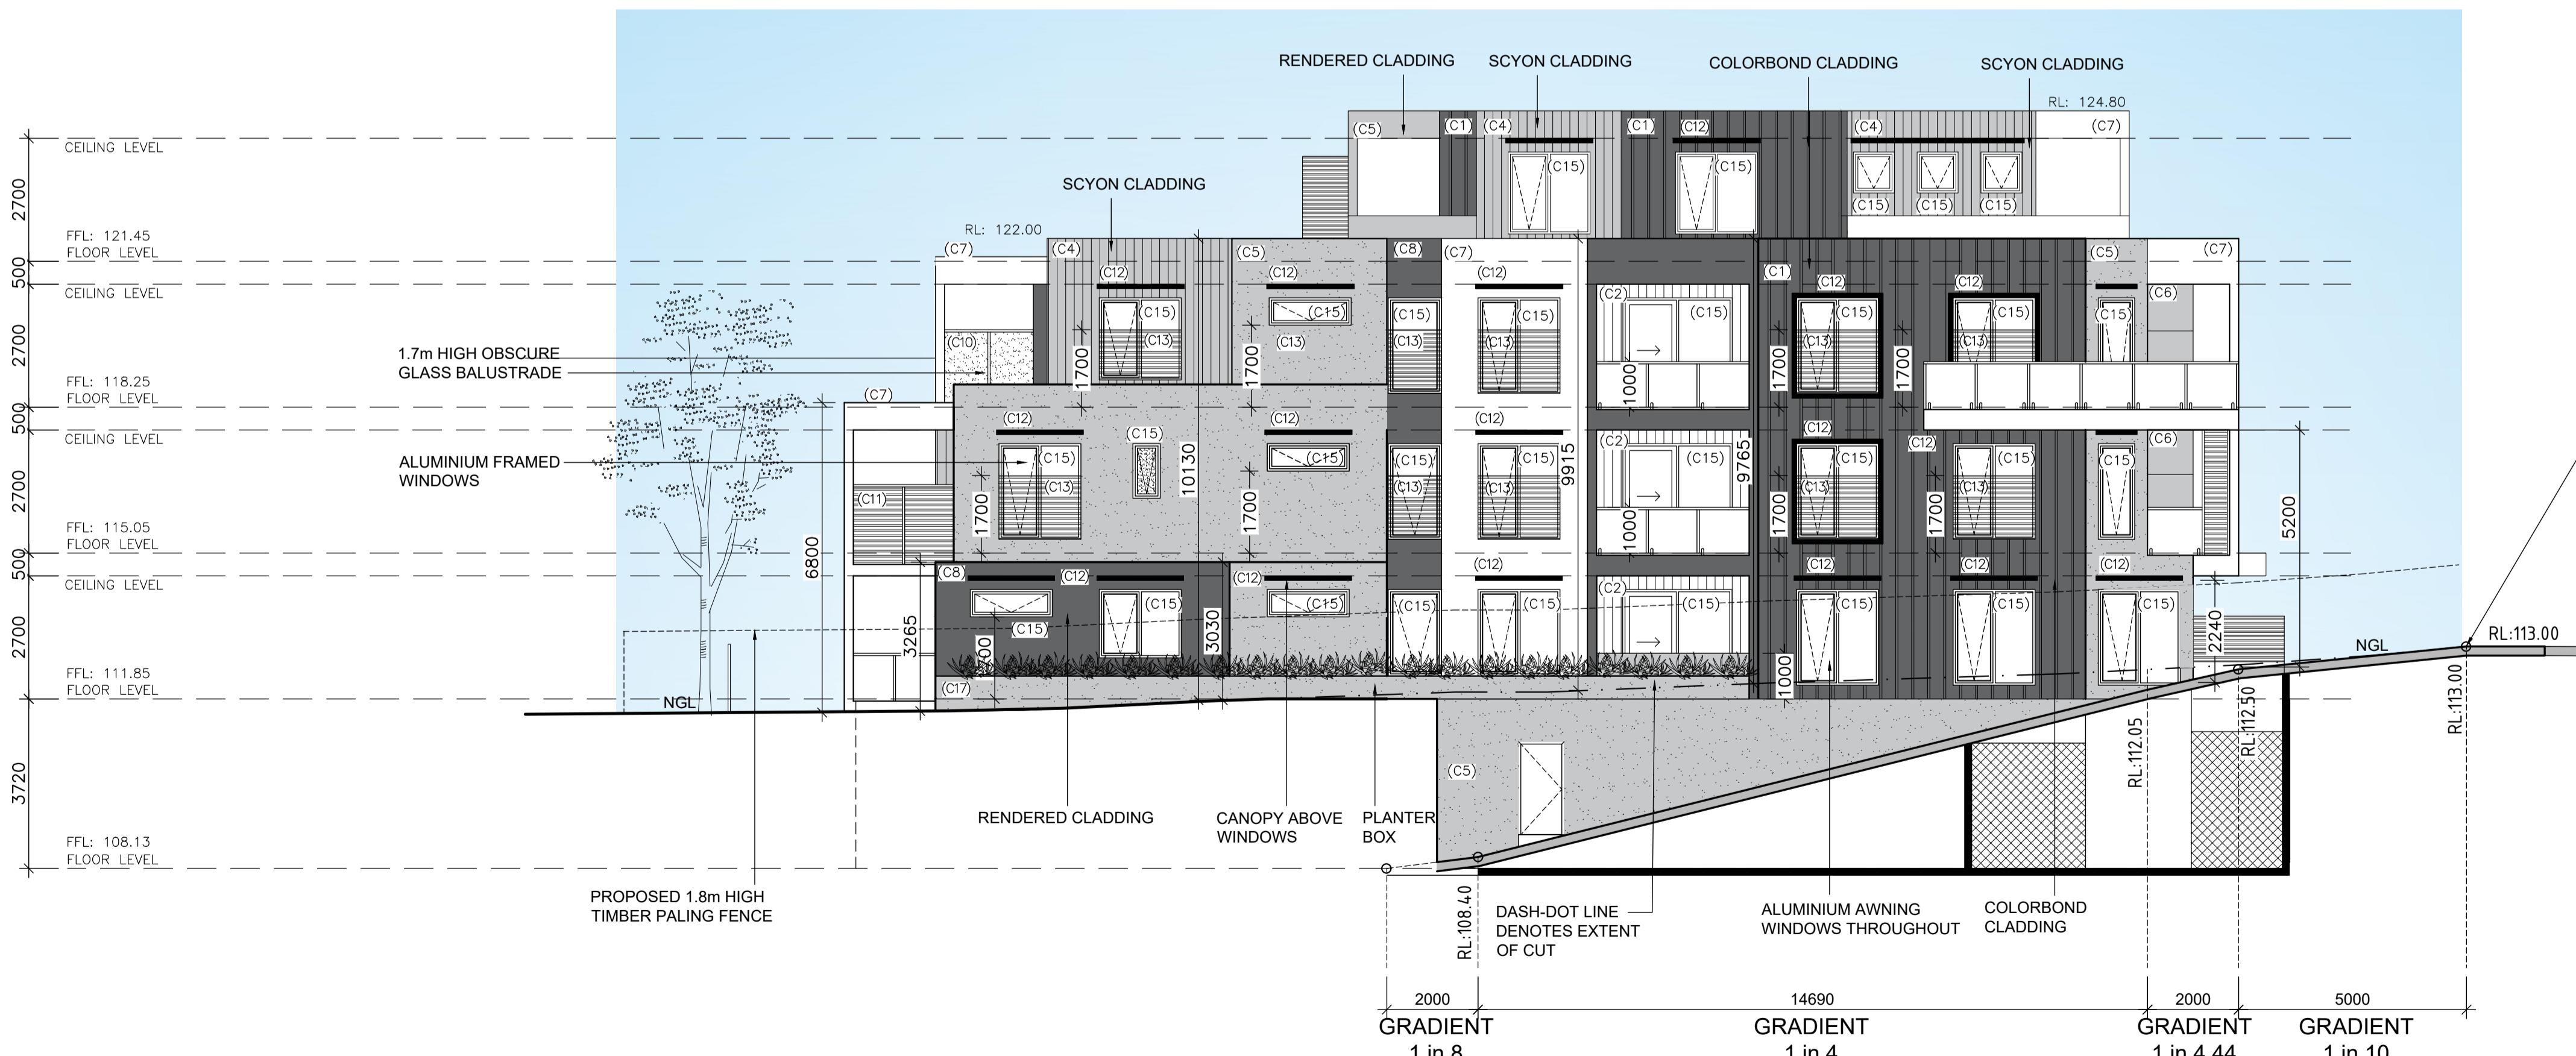SCALE 1:100




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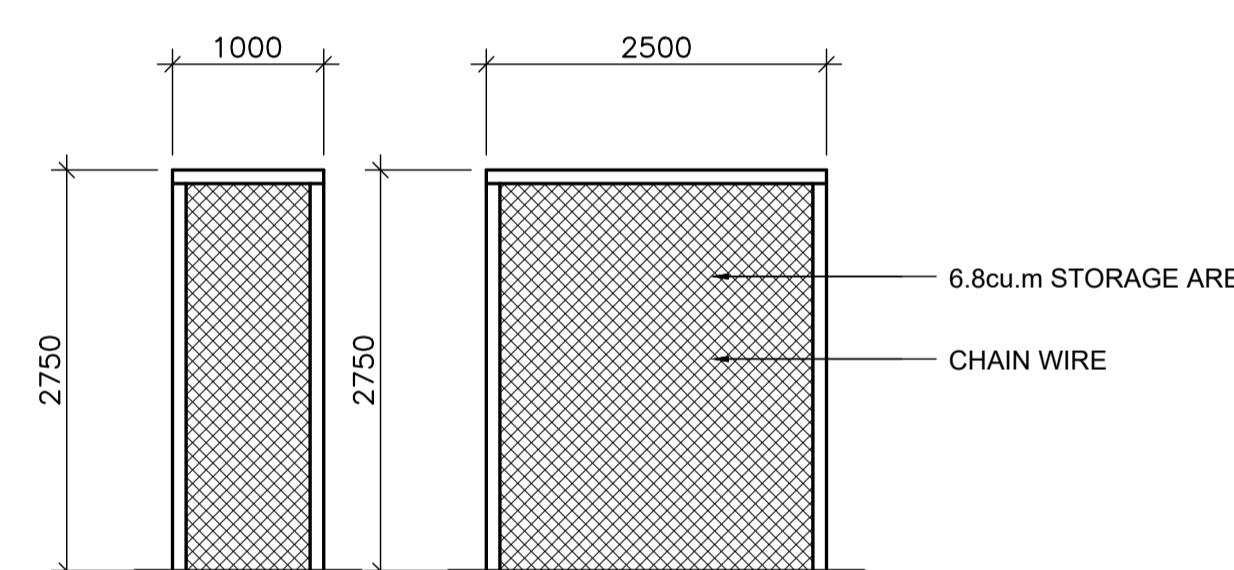
## STREETSCAPE ELEVATION

SCALE 1:200




## MAILBOX ELEVATION

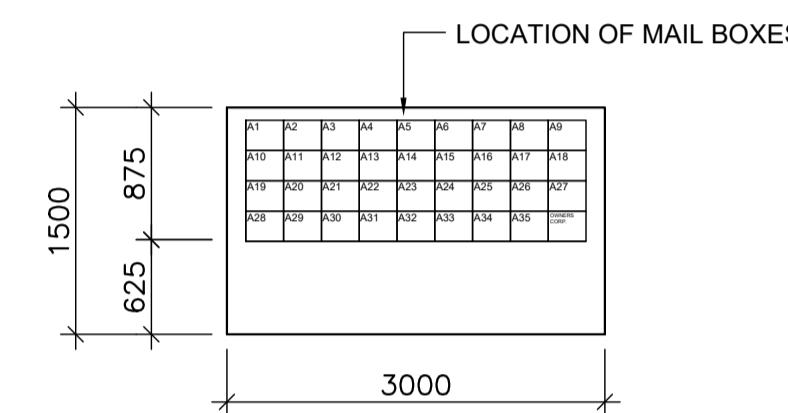SCALE 1:50




## STORAGE CAGE ELEVATIONS A24-A35

SCALE 1:50

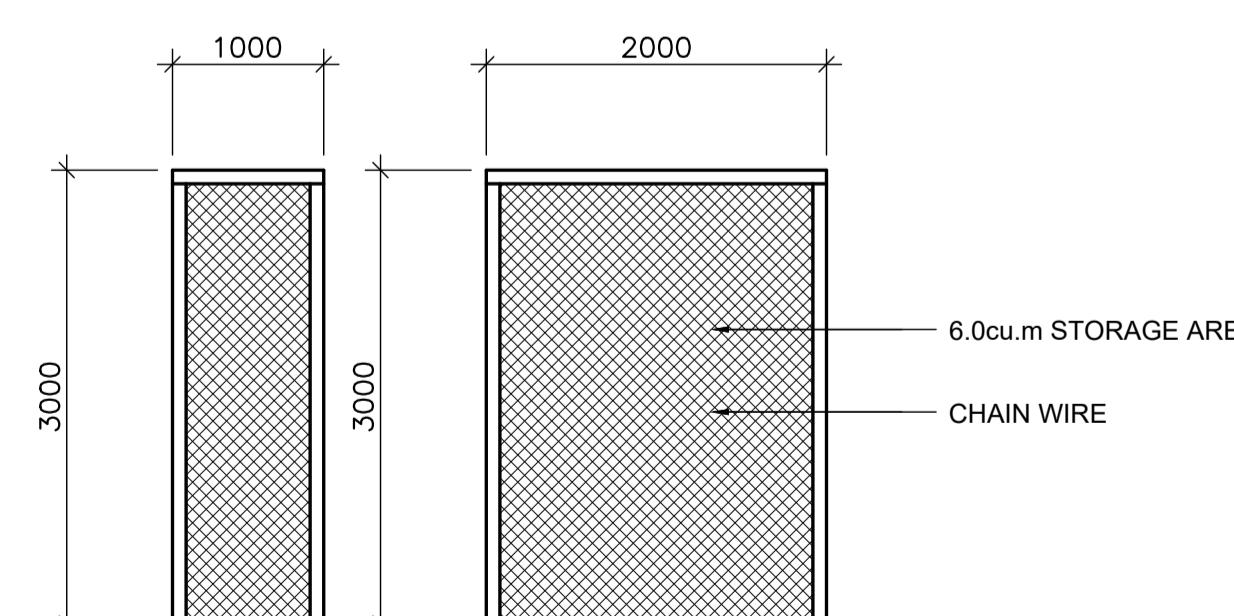


## STORAGE CAGE ELEVATIONS A1-A23

SCALE 1:50

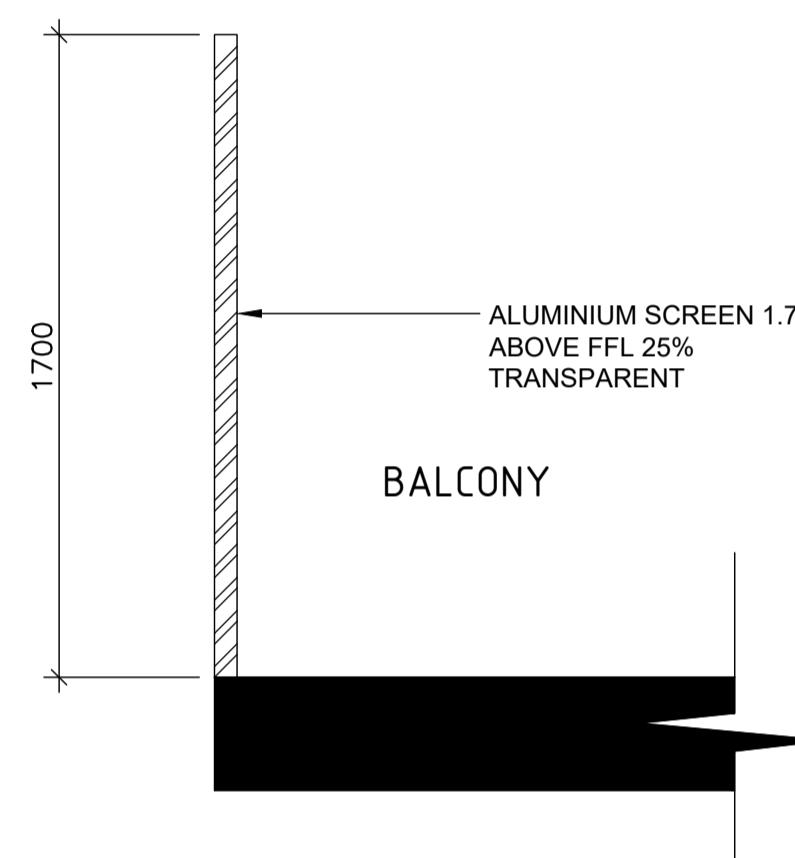


## BALCONY SCREEN DETAIL

SCALE 1:20

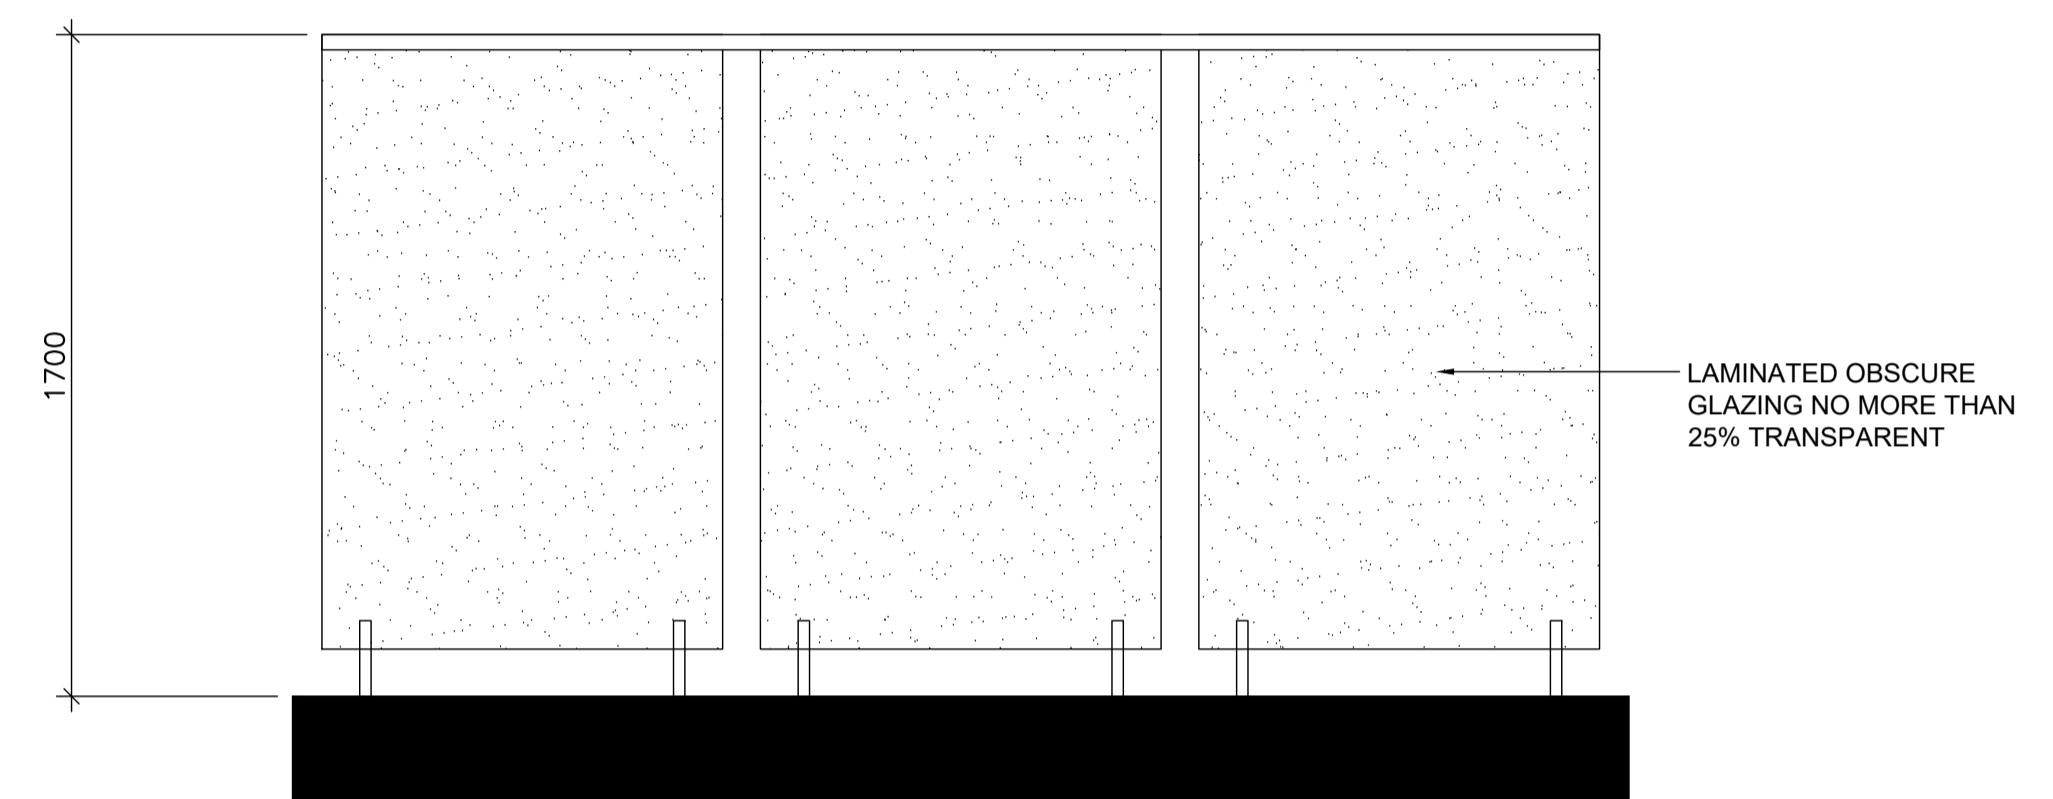

## BALCONY GROUND FLOOR GLASS SCREEN DETAIL

SCALE 1:20

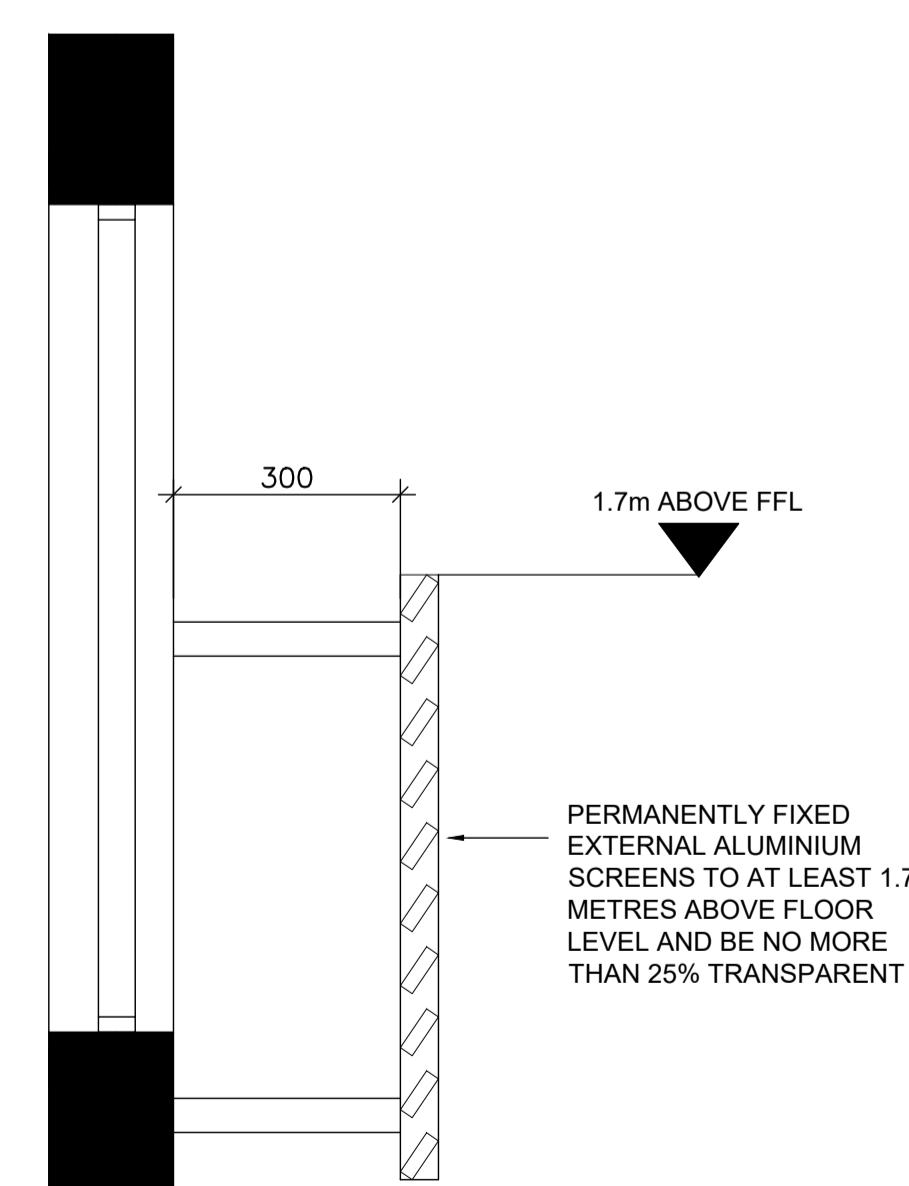

## WINDOW SCREEN DETAIL

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DATE:	AMENDMENT:
20/12/19	AMENDED FLOOR PLANS
22/04/20	COUNCIL RFI
PROJECT:	PROPOSED APARTMENT DEVELOPMENT
AT:	No. 969–973, DONCASTER ROAD, DONCASTER EAST
FOR :	ZHOU PROJECT
MELWAY REF:	MAP
DATE:	APRIL 20
SHEET:	23 OF 25
DRAWN:	A.M.
REFERENCE NO:	1659-2



## NORTHERN FENCE DETAIL


SCALE 1:100

PLANNING AND ENVIRONMENT ACT 1987  
MANNINGHAM PLANNING SCHEME

ADVERTISED PLANS

Planning Application Number: PLN19/0226  
Date: 11 May 2020  
Sheet 24 of 25


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## SECTION B-B

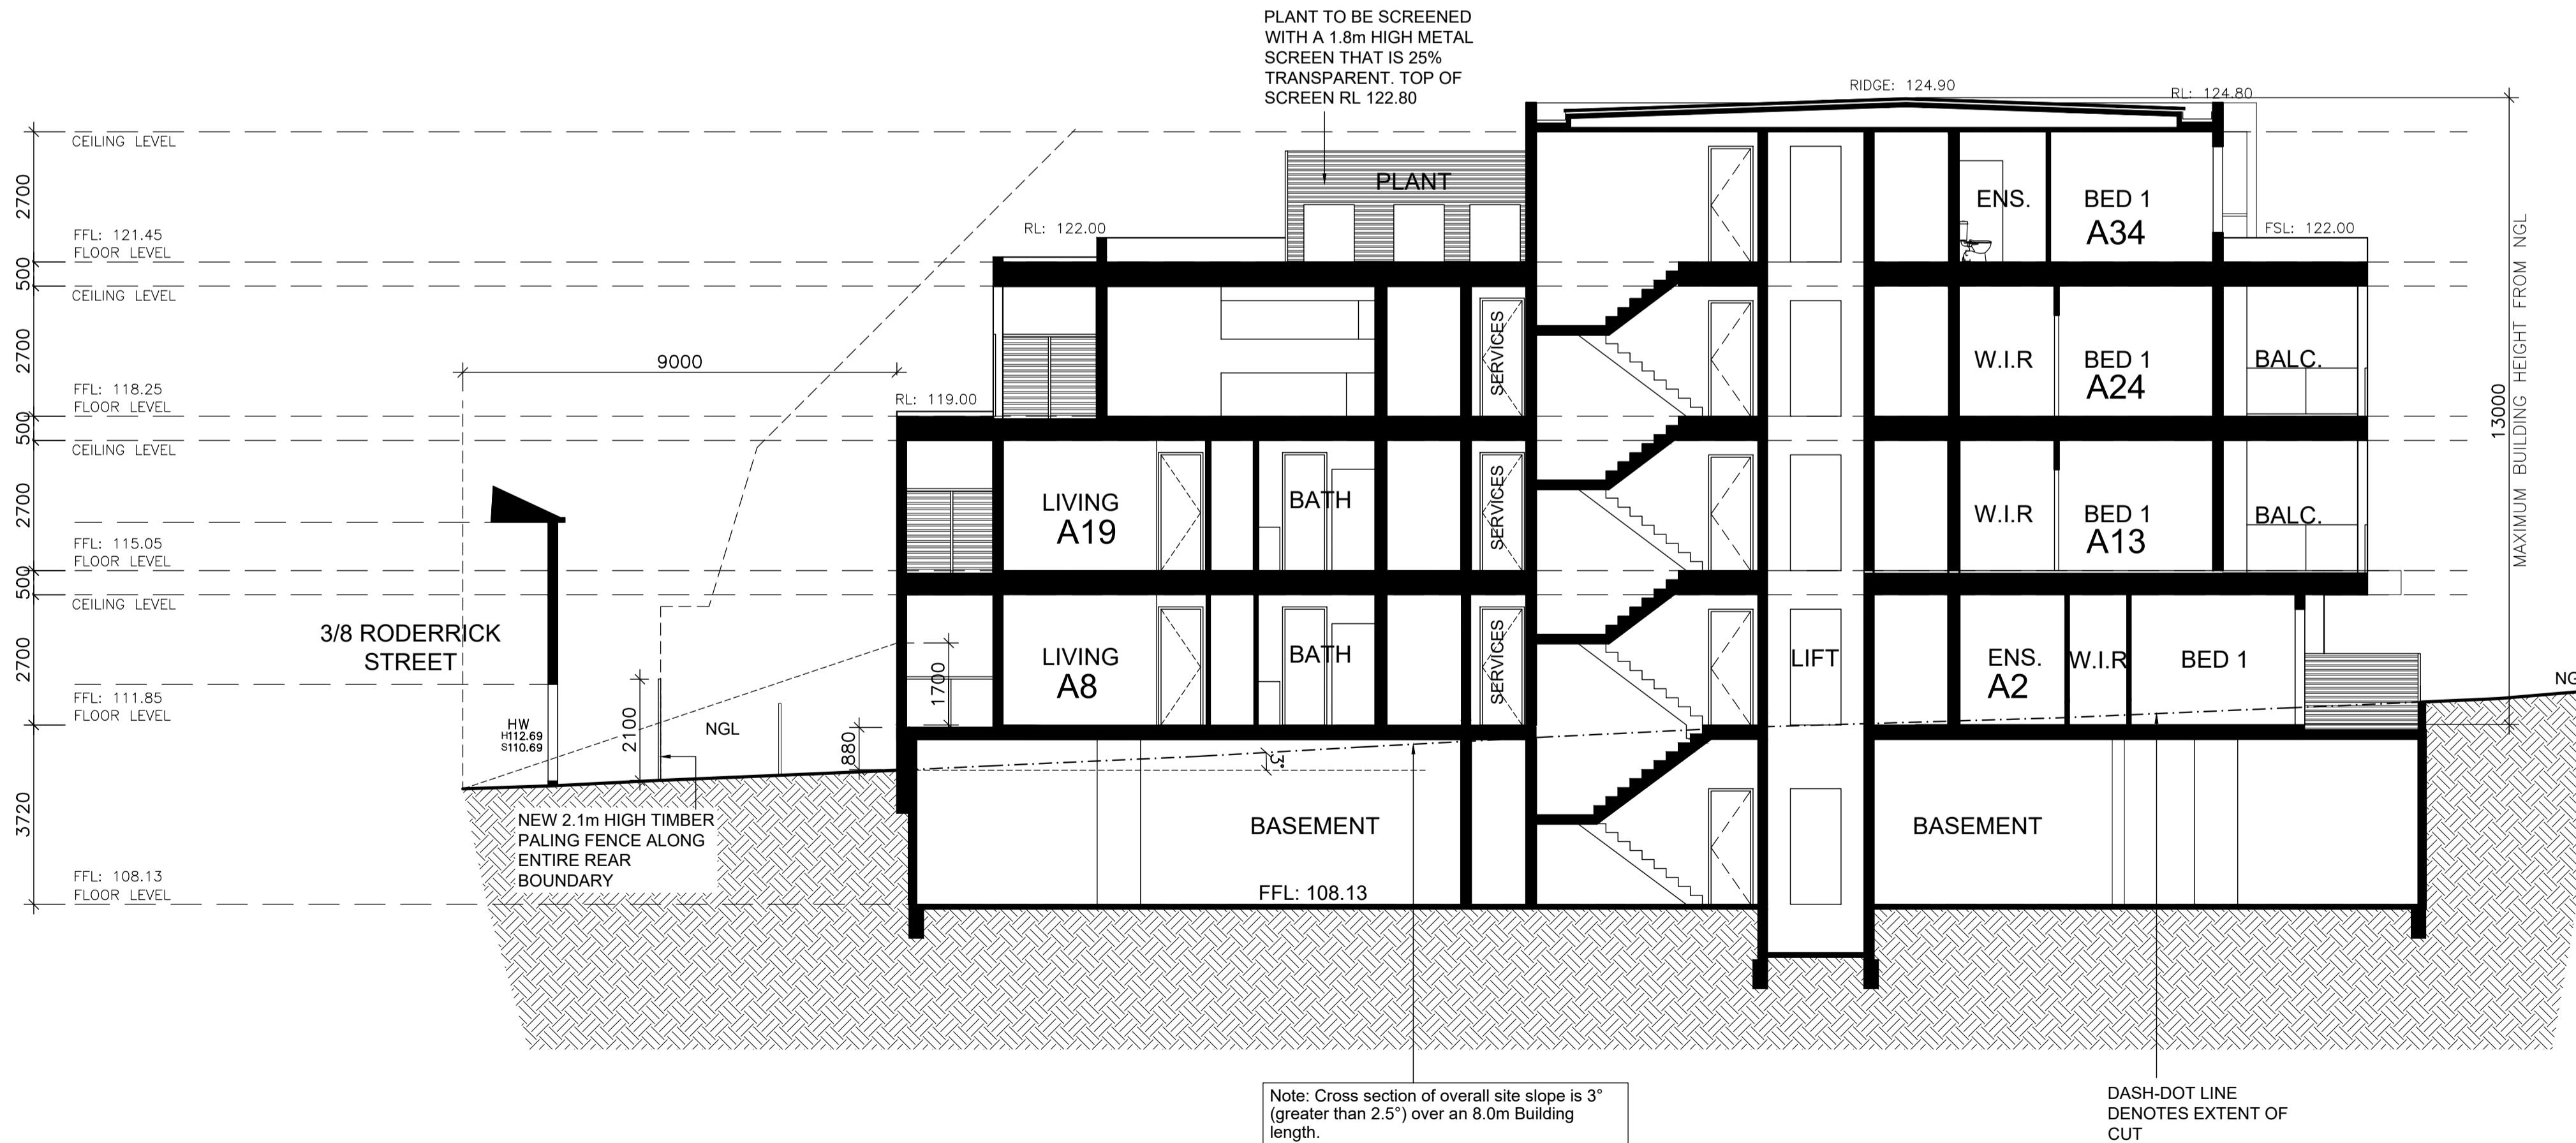SCALE 1:200

E.J. Grech & Associates Pty Ltd	
23 Railway Road Blackburn 3130 Ph - 9878 3500	
www.ejgrech.com.au Fax - 9894 4425	
DATE:	AMENDMENT:
20/12/19	AMENDED FLOOR PLANS
22/04/20	COUNCIL RFI
PROJECT:	
PROPOSED APARTMENT DEVELOPMENT	
AT: No. 969–973, DONCASTER ROAD, DONCASTER EAST	
FOR : ZHOU PROJECT	
MELWAY REF: MAP	
DATE: APRIL 20	SCALE: 1:100
SHEET: 24 OF 25	REFERENCE NO:
DRAWN: A.M.	1659-2



PLANNING AND ENVIRONMENT ACT 1987  
MANNINGHAM PLANNING SCHEME

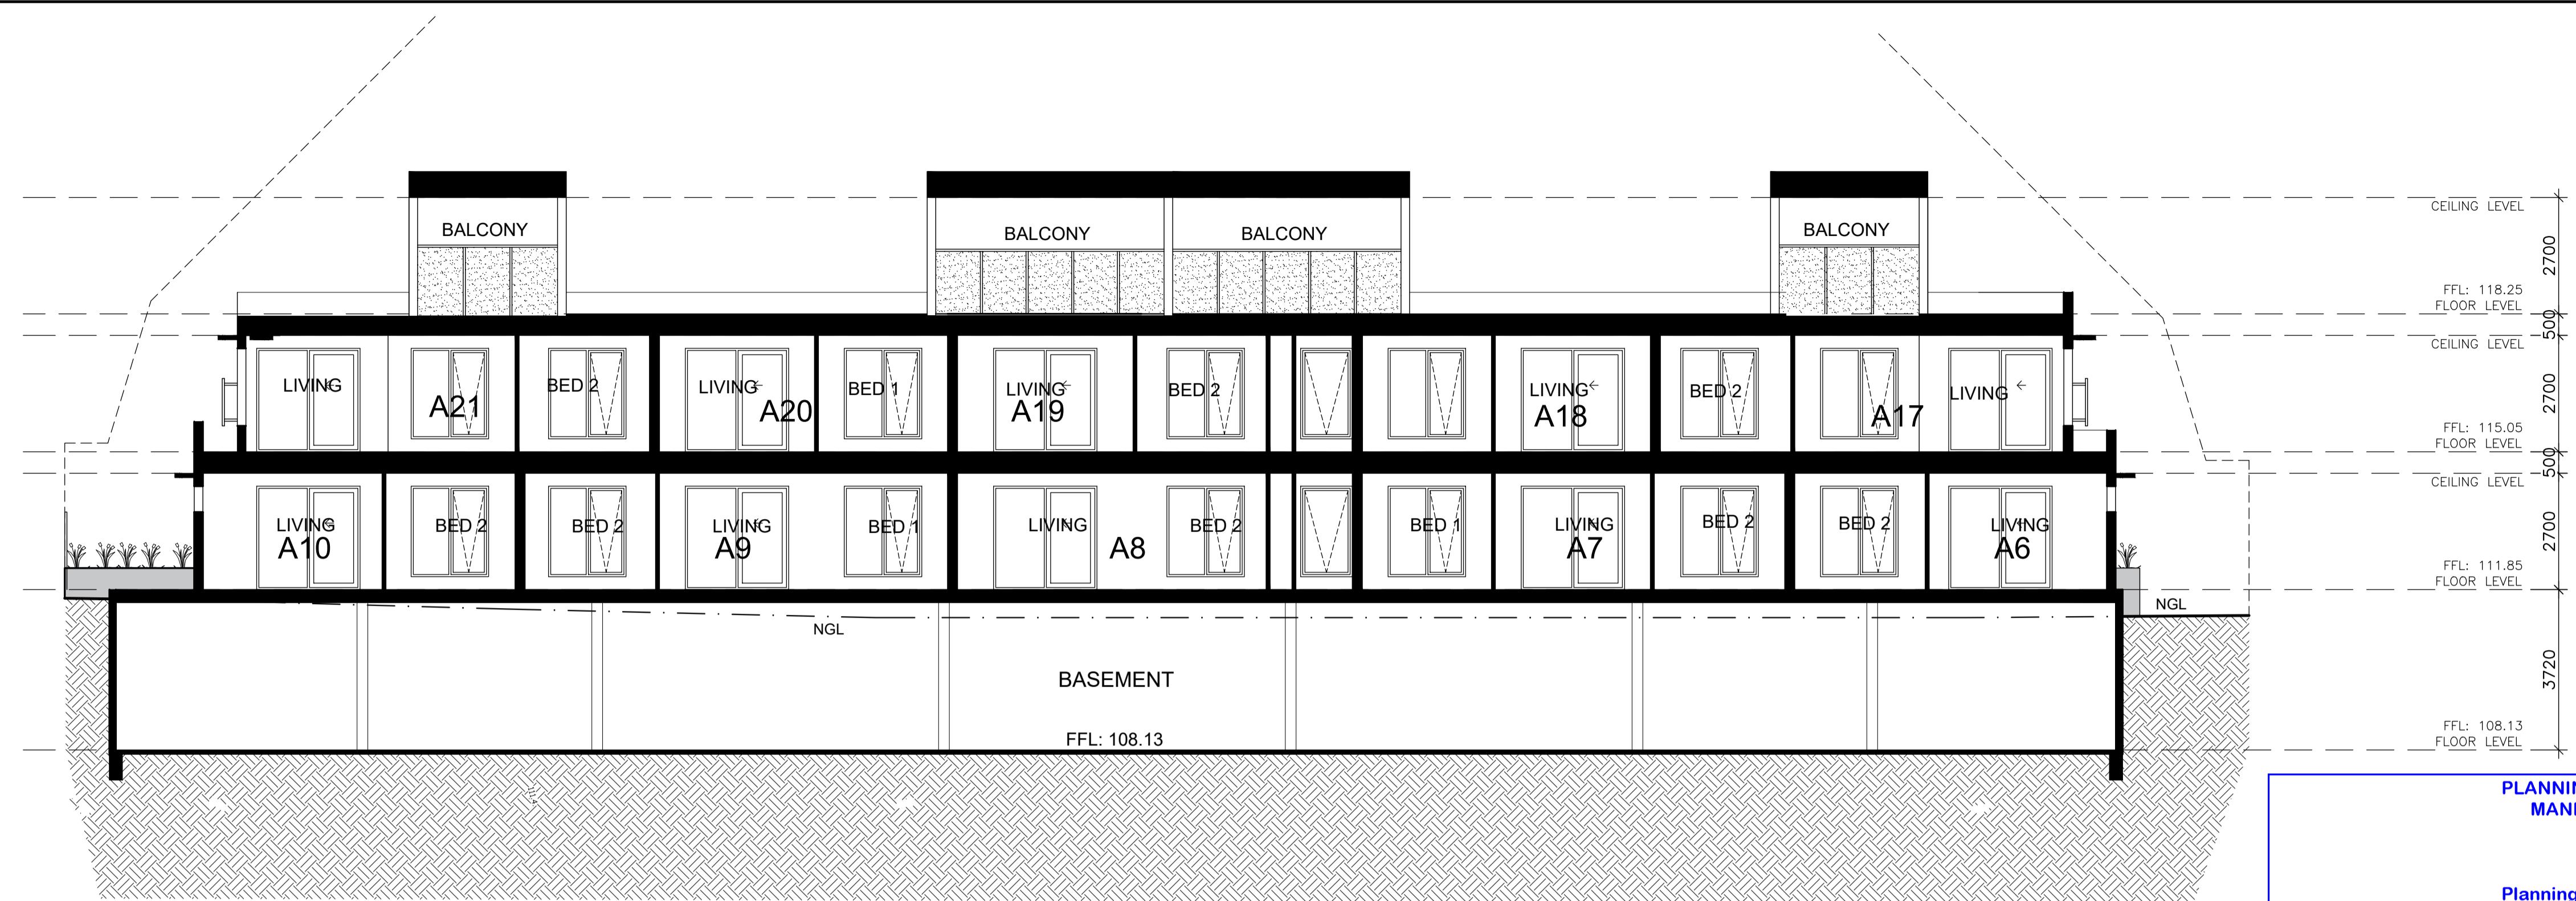
ADVERTISED PLANS

Planning Application Number: PLN19/0226  
Date: 11 May 2020  
Sheet 25 of 25

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## SECTION C-C

SCALE 1:200

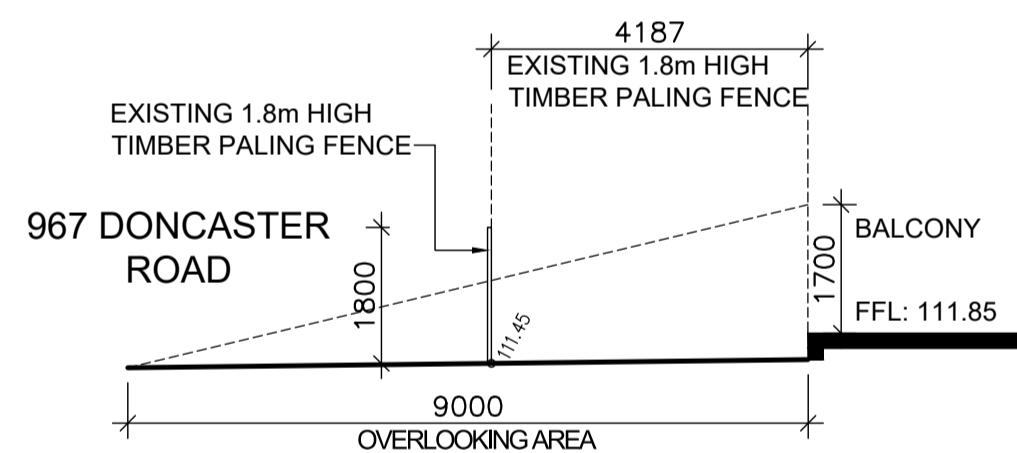


## APARTMENT 10 BALCONY OVERLOOKING DIAGRAM

SCALE 1:200




BUILDING ENTRY

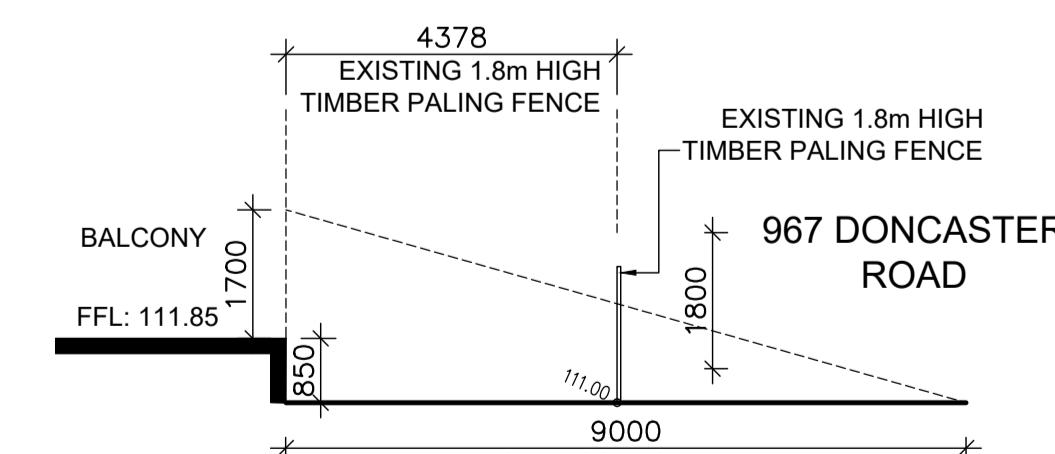

## APARTMENT 6 BALCONY OVERLOOKING DIAGRAM


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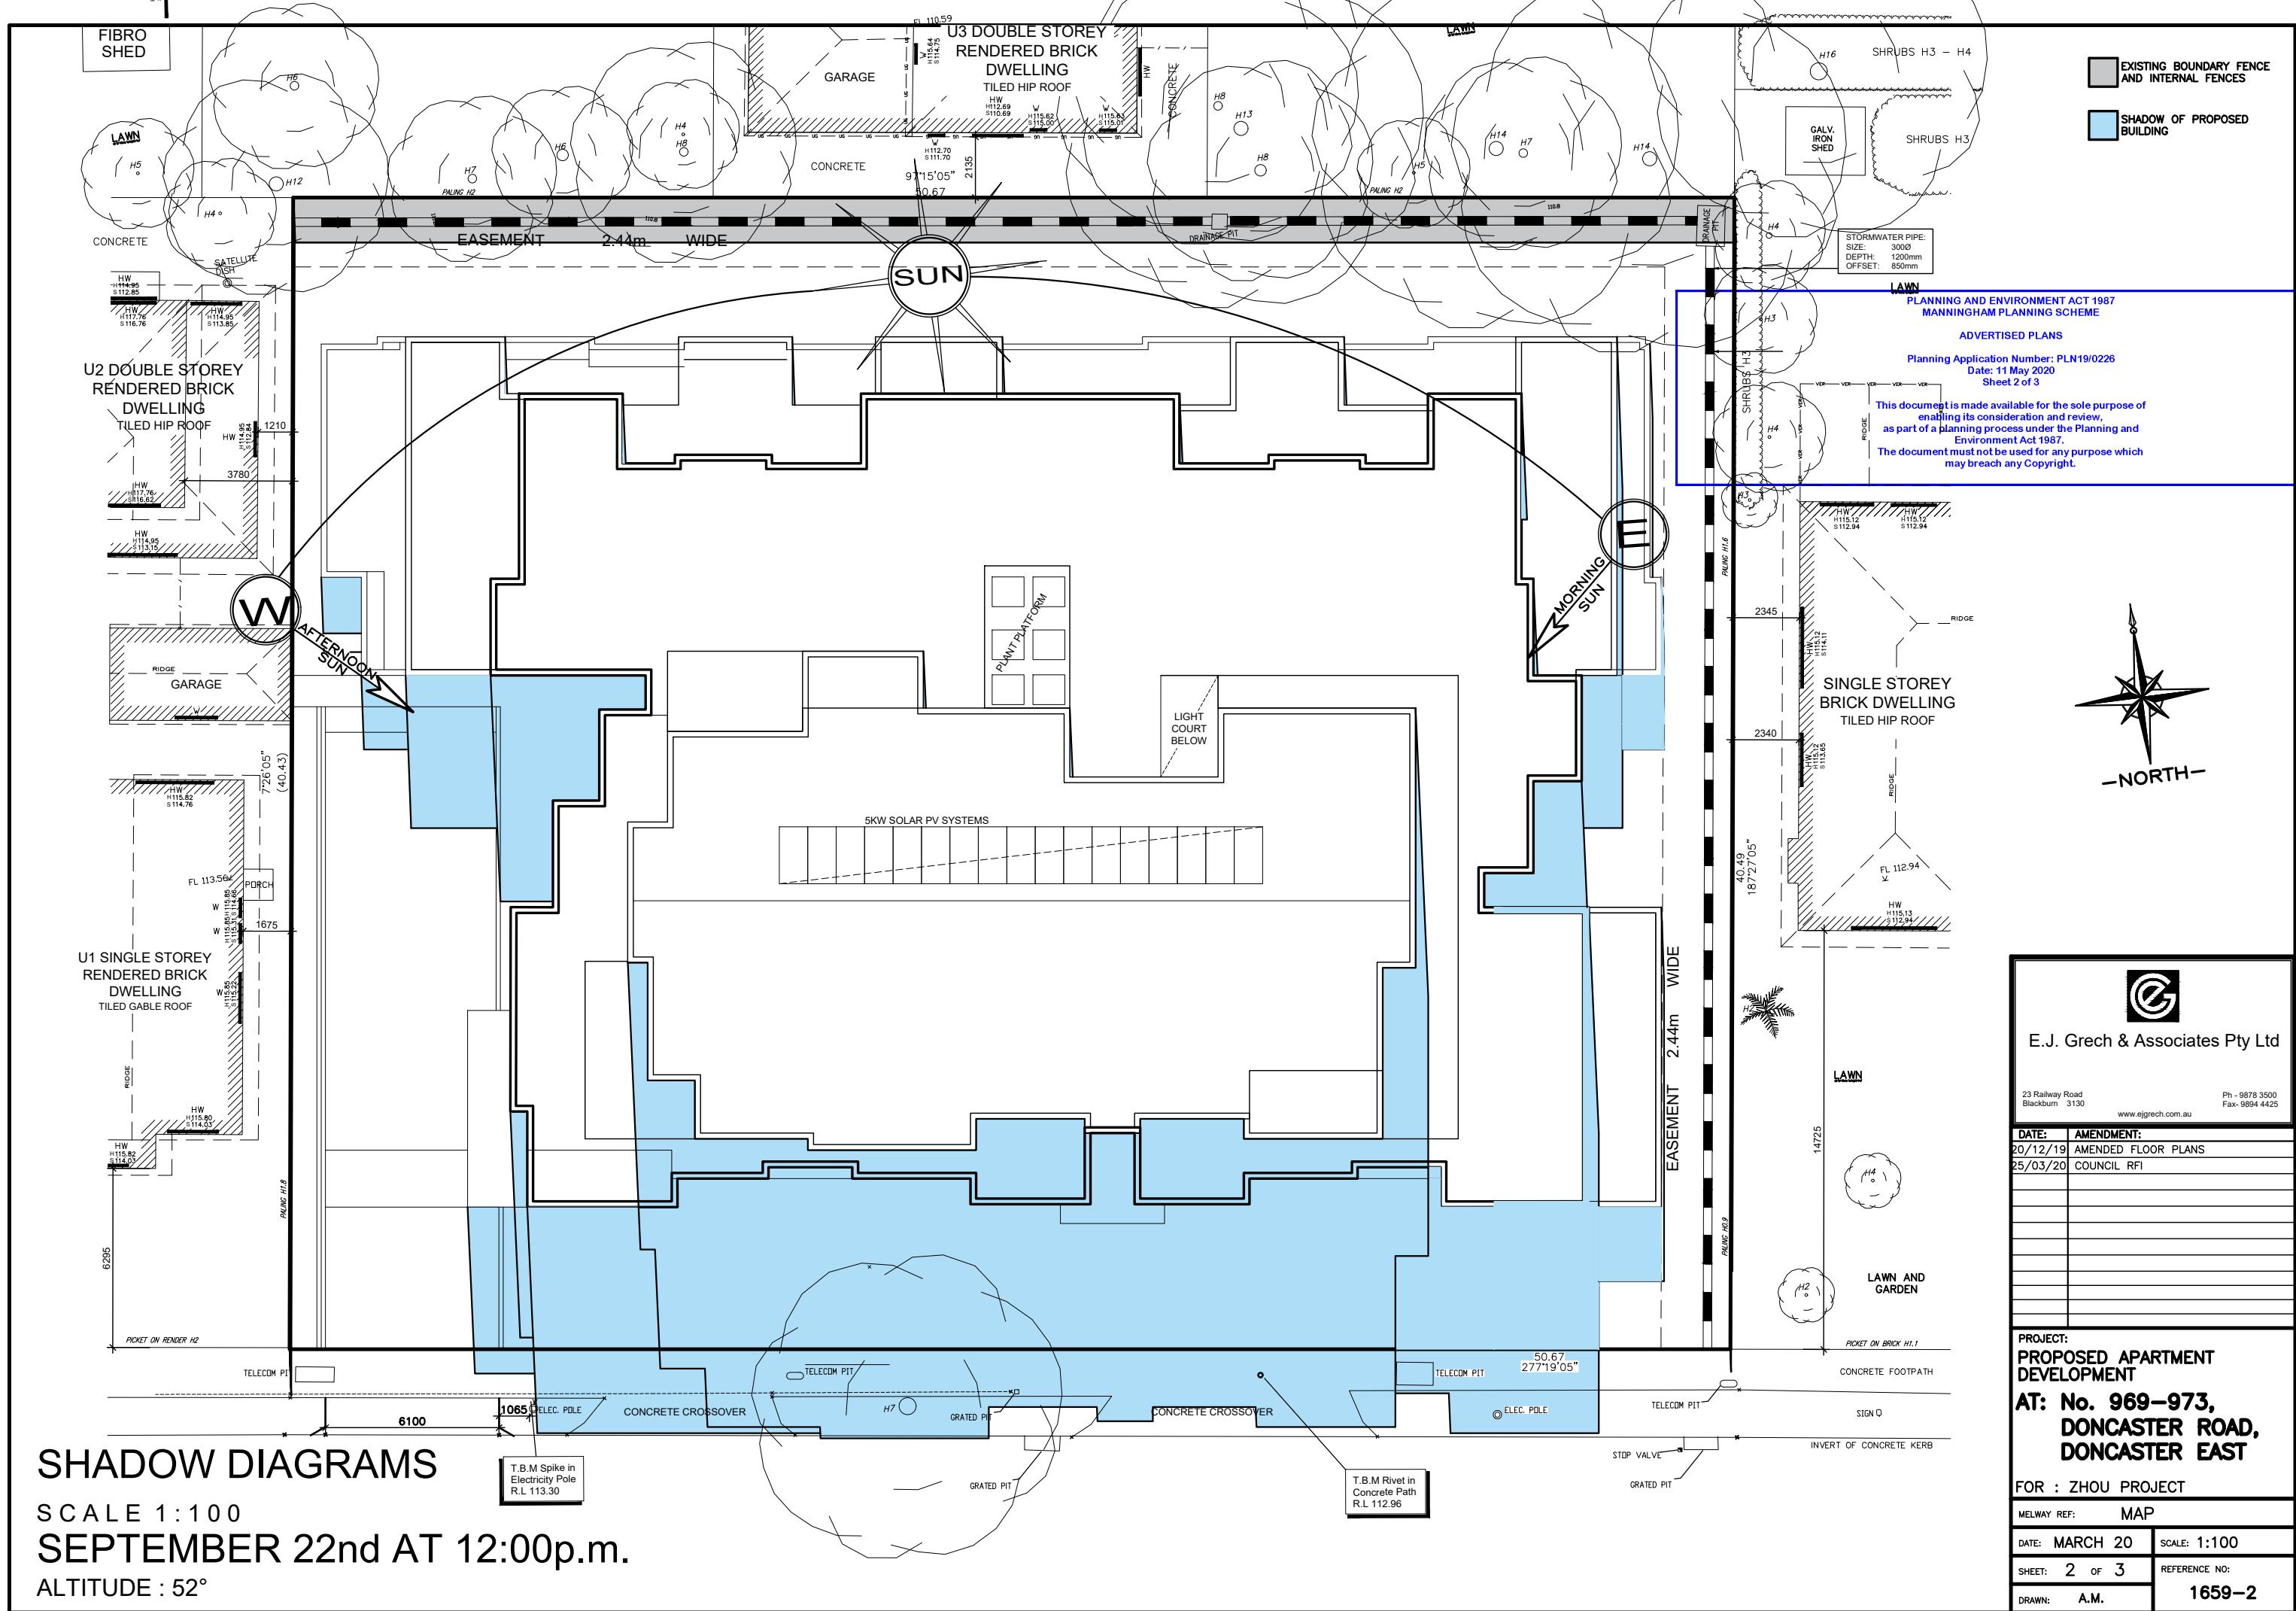

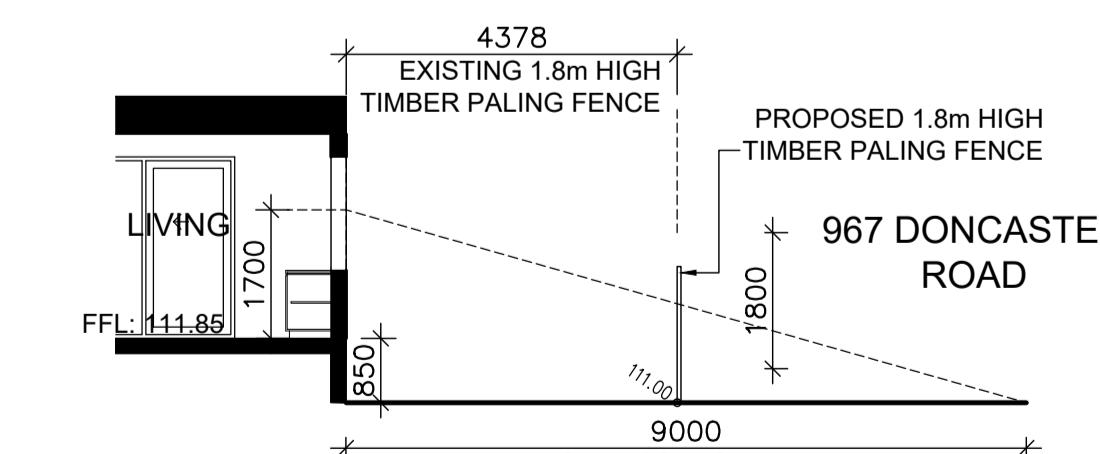
## APARTMENT 6 KITCHEN WINDOW OVERLOOKING DIAGRAM

SCALE 1:200

E.J. Grech & Associates Pty Ltd	
23 Railway Road Blackburn 3130	
Ph - 9878 3500 Fax - 9894 4425 www.ejgrech.com.au	
DATE:	AMENDMENT:
20/12/19	AMENDED FLOOR PLANS
22/04/20	COUNCIL RFI
PROJECT: PROPOSED APARTMENT DEVELOPMENT AT: No. 969–973, DONCASTER ROAD, DONCASTER EAST	
FOR : ZHOU PROJECT	
MELWAY REF: MAP	
DATE: APRIL 20	SCALE: 1:100
SHEET: 25 OF 25	REFERENCE NO:
DRAWN: A.M.	1659-2



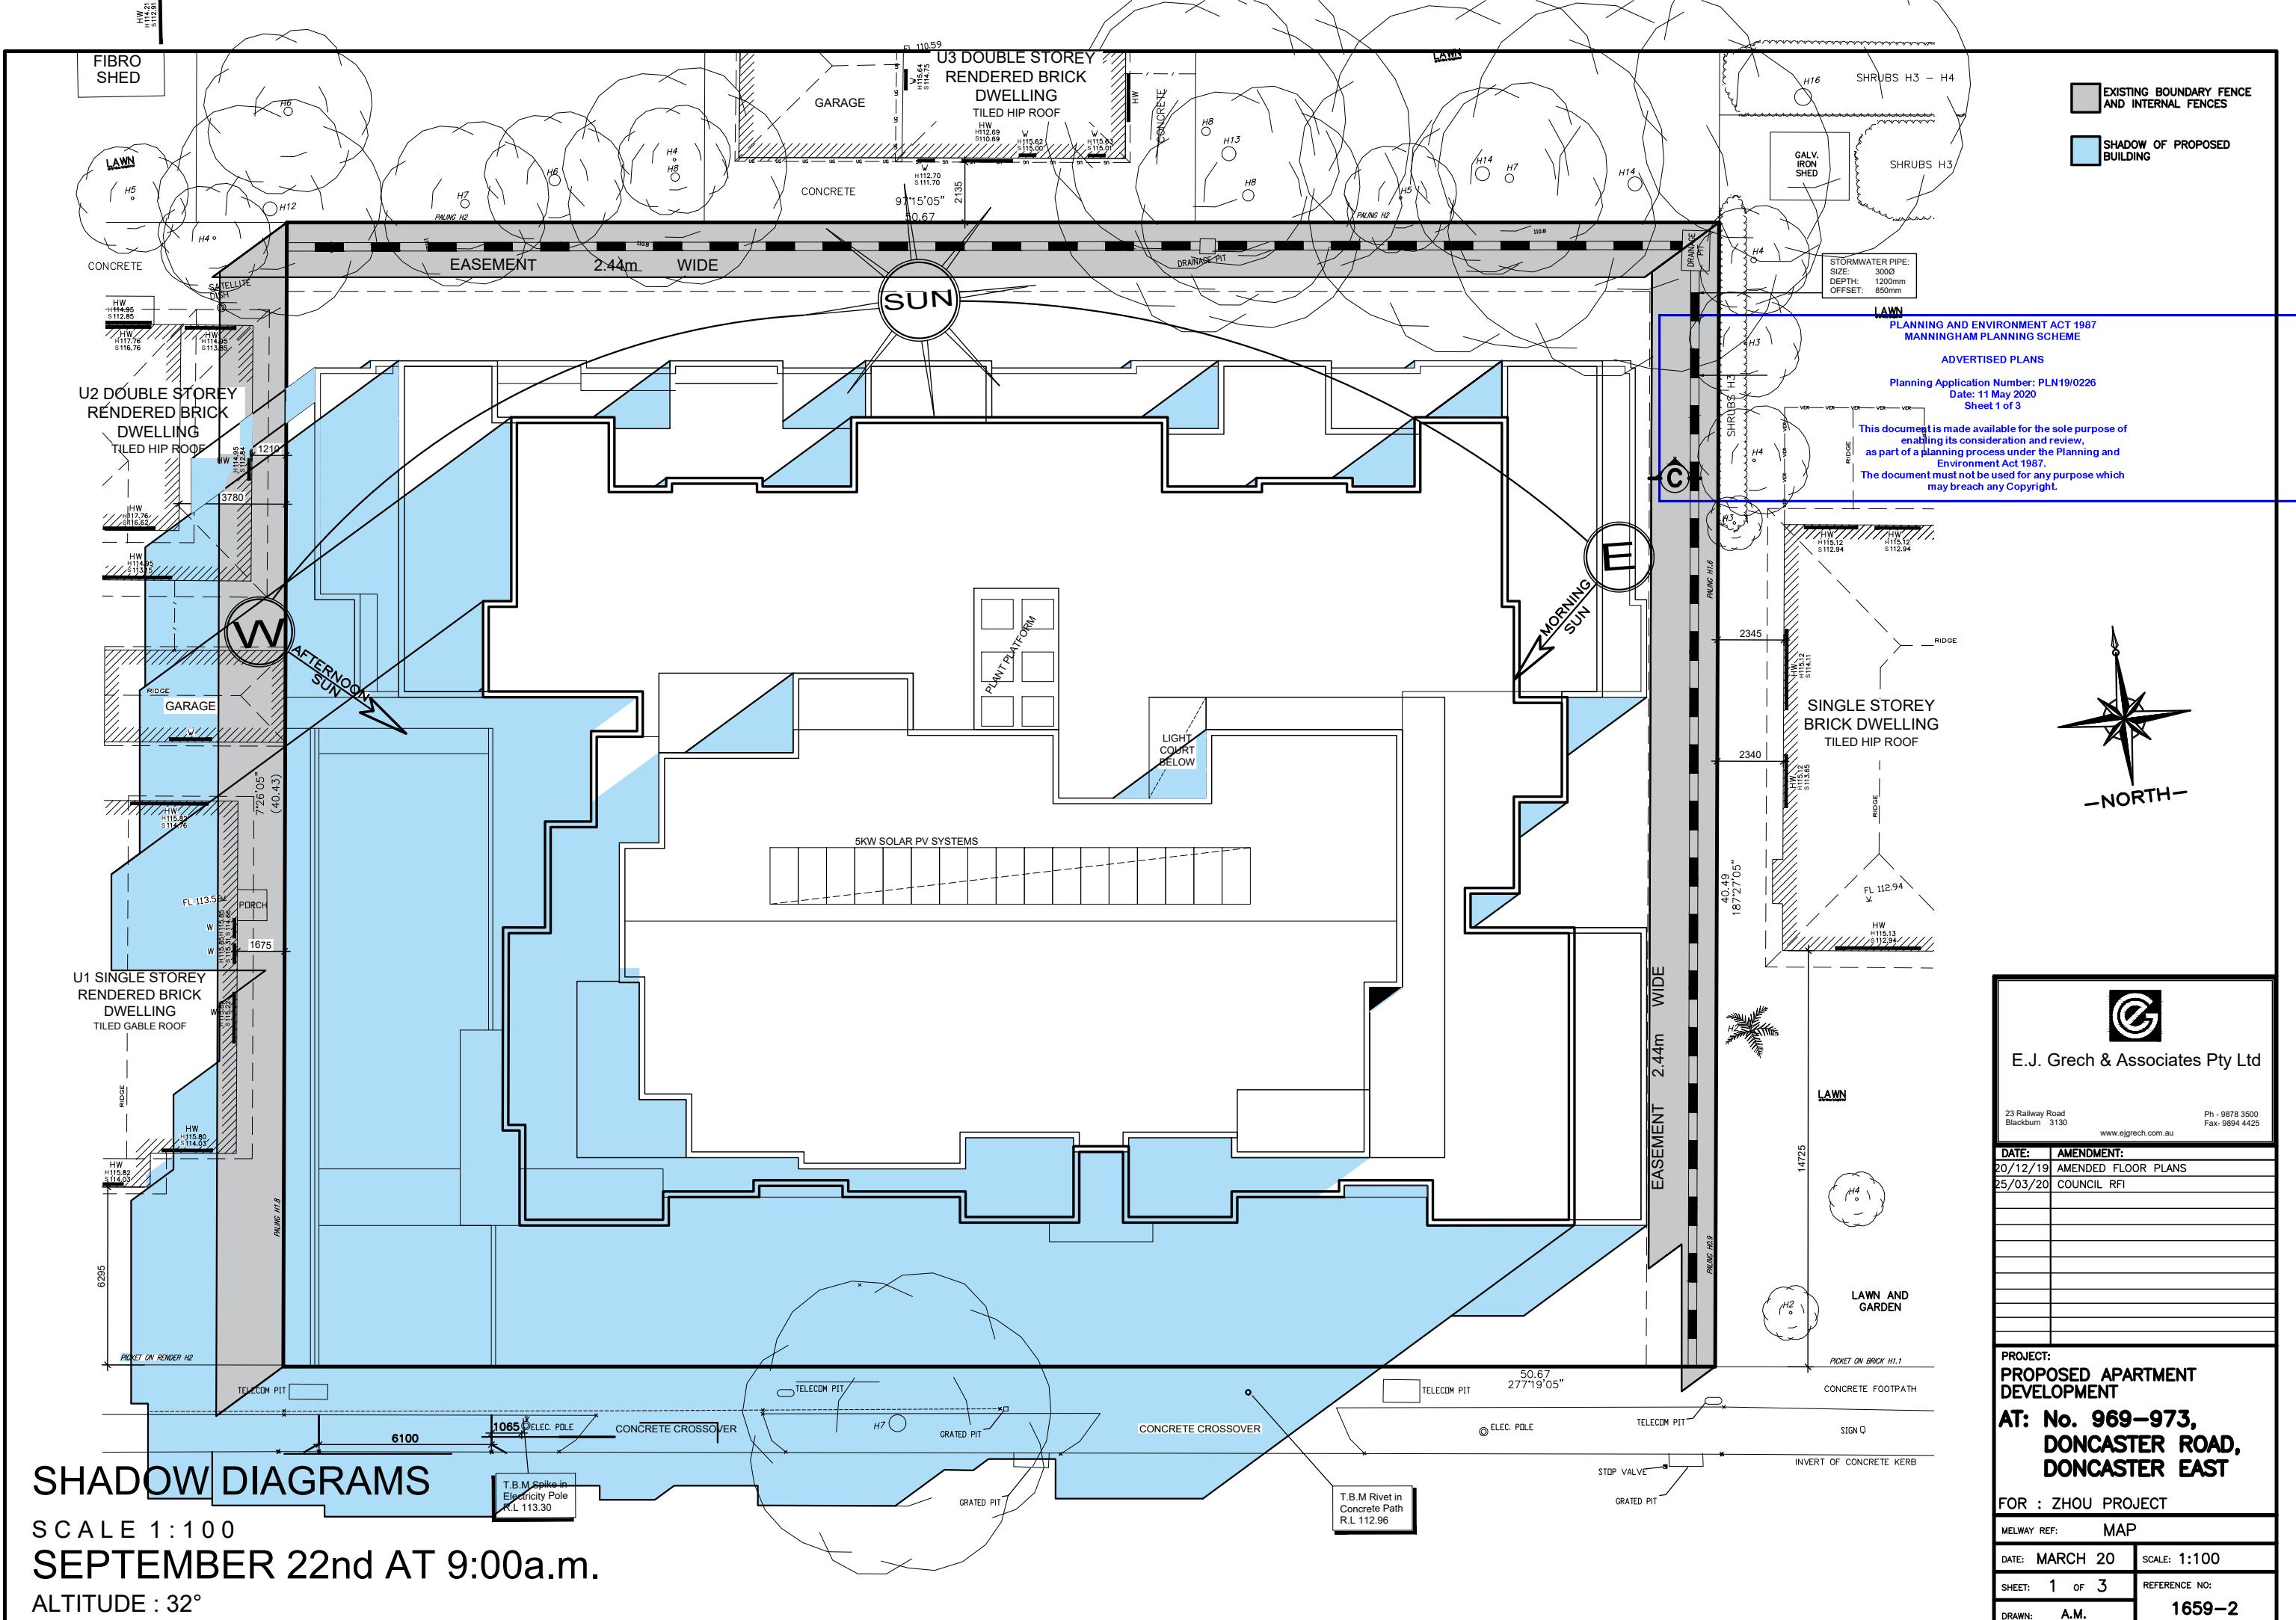


**E.J. Grech & Associates Pty Ltd**  
23 Railway Road  
Blackburn 3130  
Ph - 9878 3500  
Fax - 9894 4425  
www.ejgrech.com.au

DATE:	AMENDMENT:
20/12/19	AMENDED FLOOR PLANS
25/03/20	COUNCIL RFI



**PROJECT:**  
**PROPOSED APARTMENT DEVELOPMENT**  
**AT: No. 969-973, DONCASTER ROAD, DONCASTER EAST**

FOR : ZHOU PROJECT

MELWAY REF:	MAP	
DATE:	MARCH 20	SCALE: 1:100
SHEET:	2 OF 3	REFERENCE NO:
DRAWN:	A.M.	1659-2

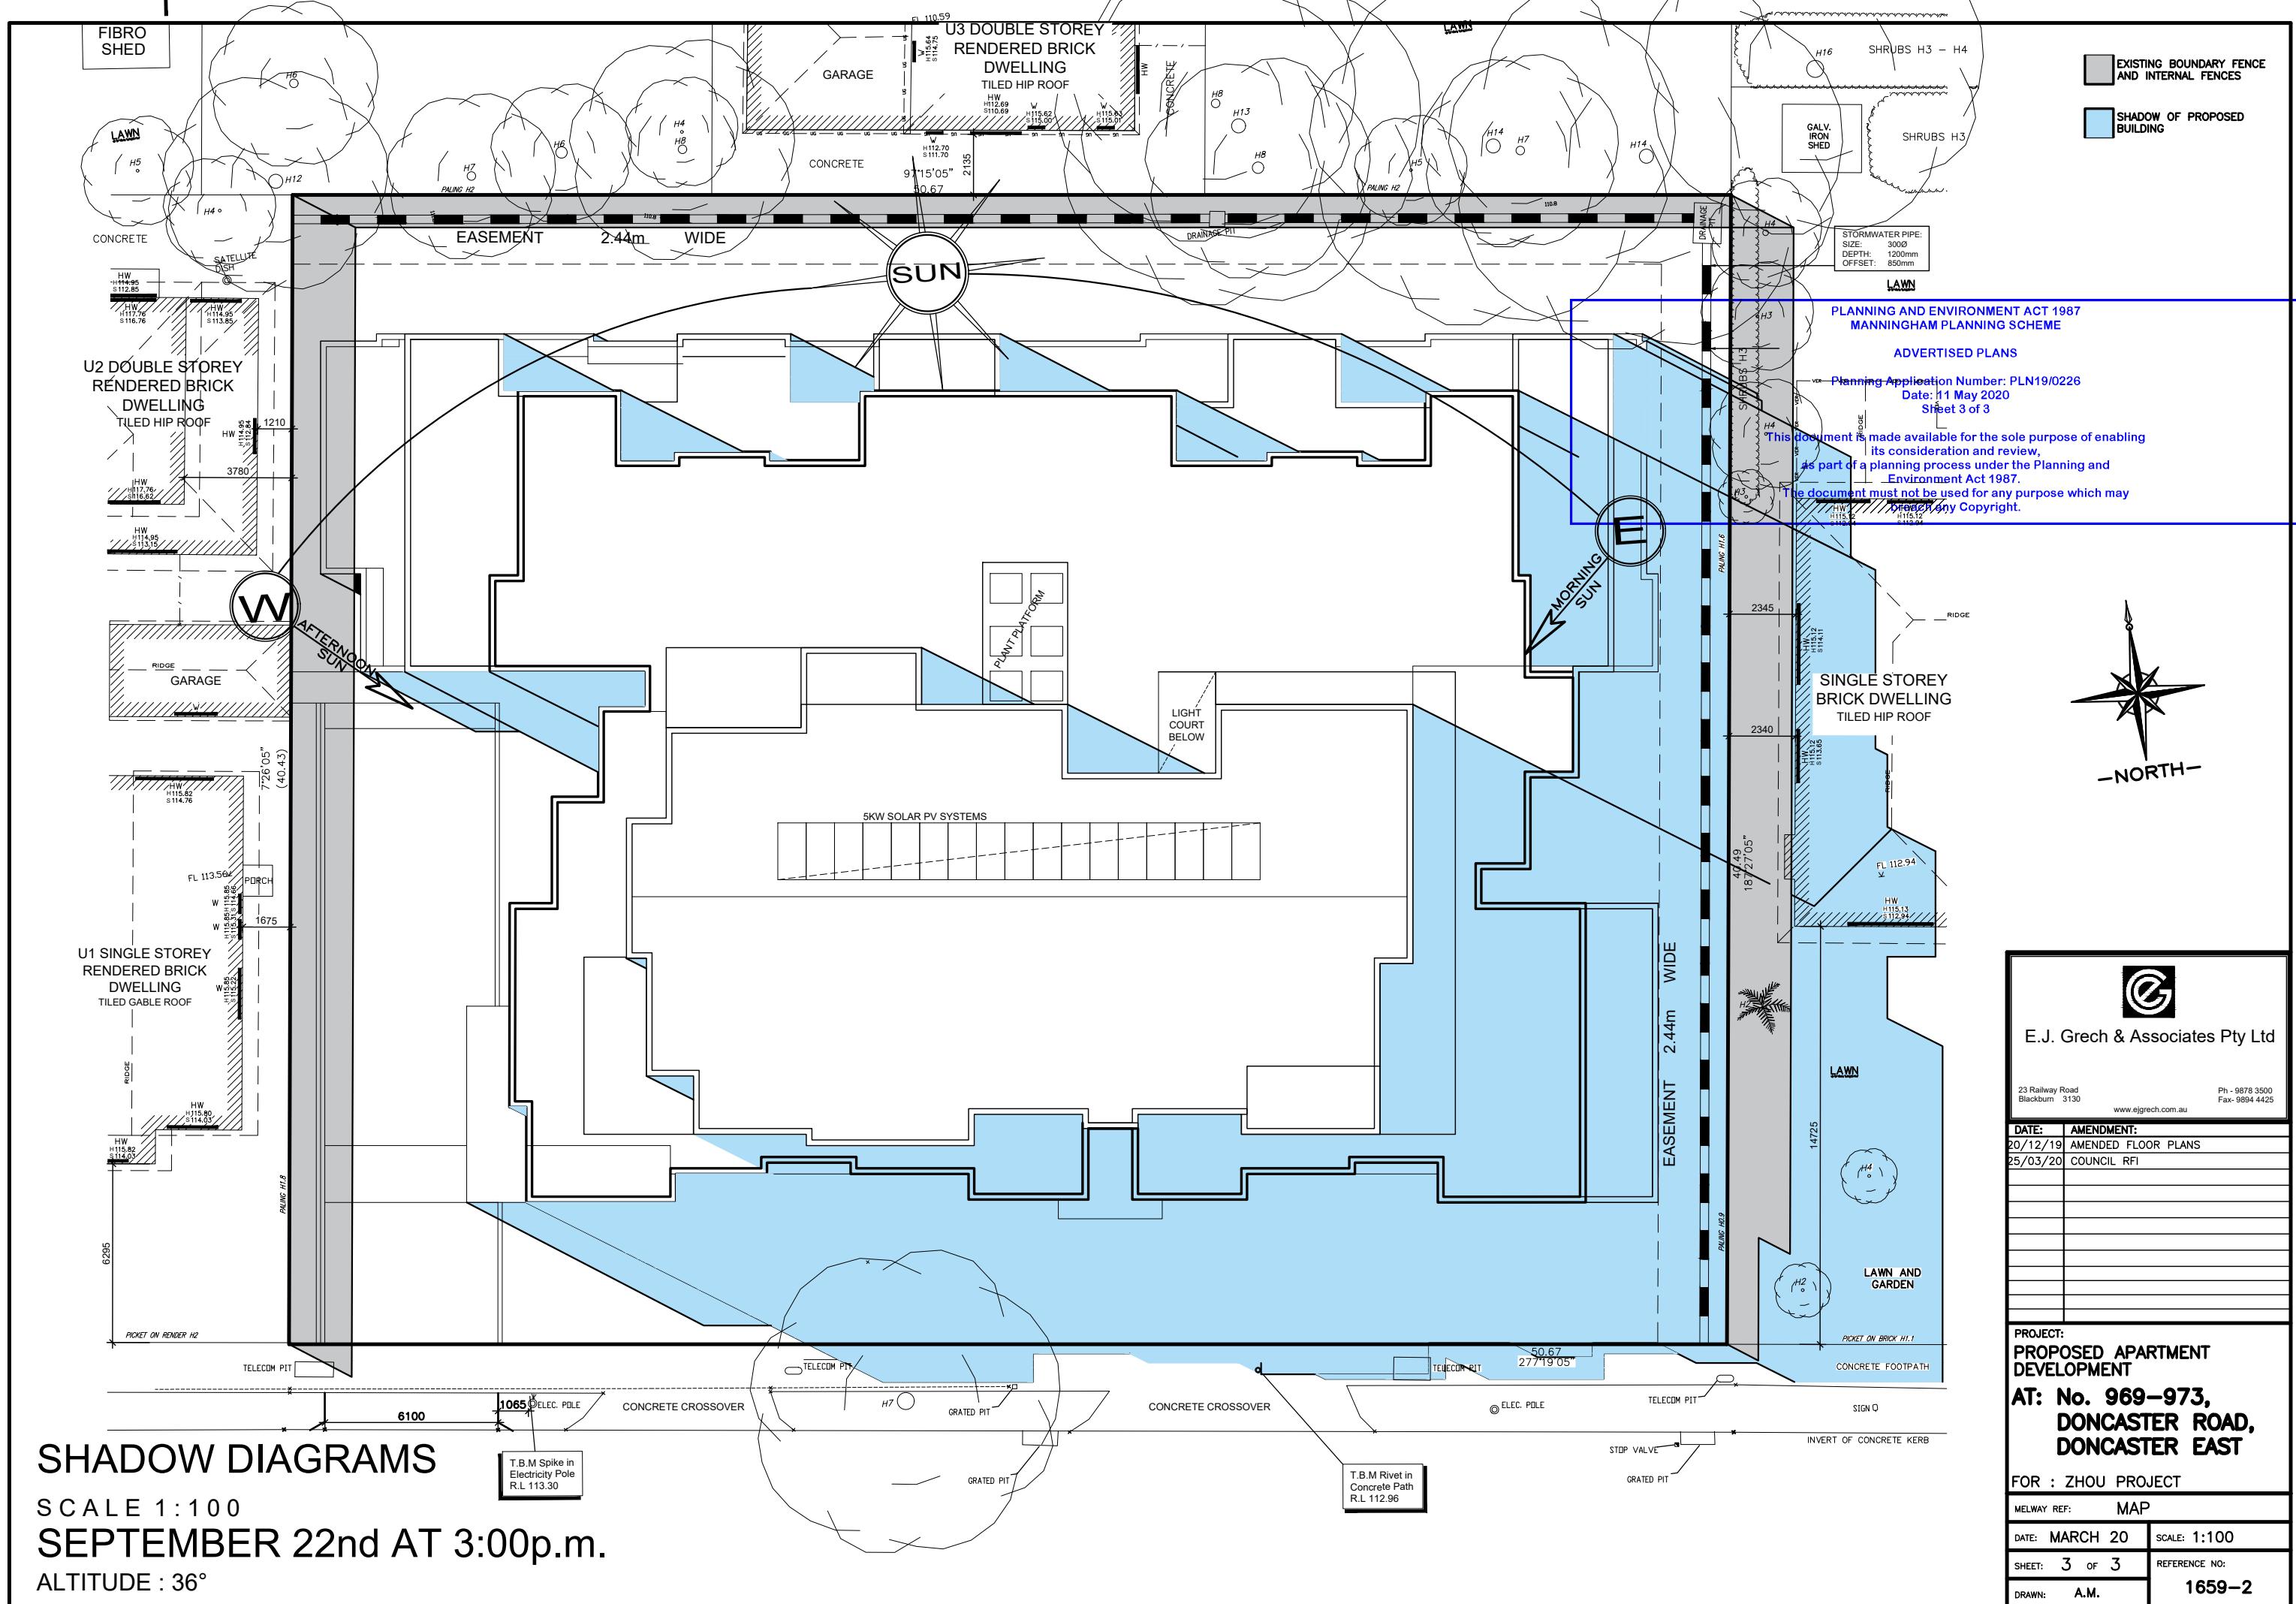

# Maps of Manningham

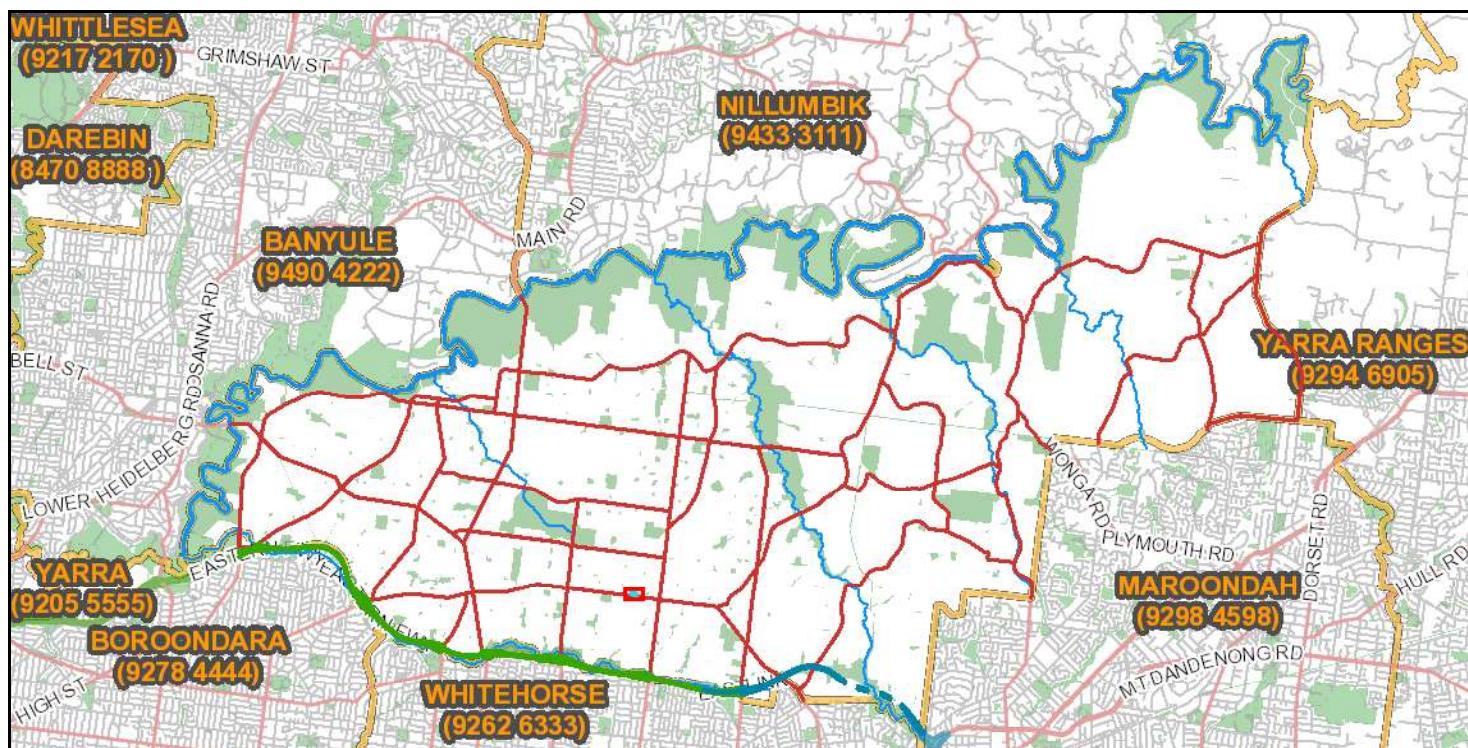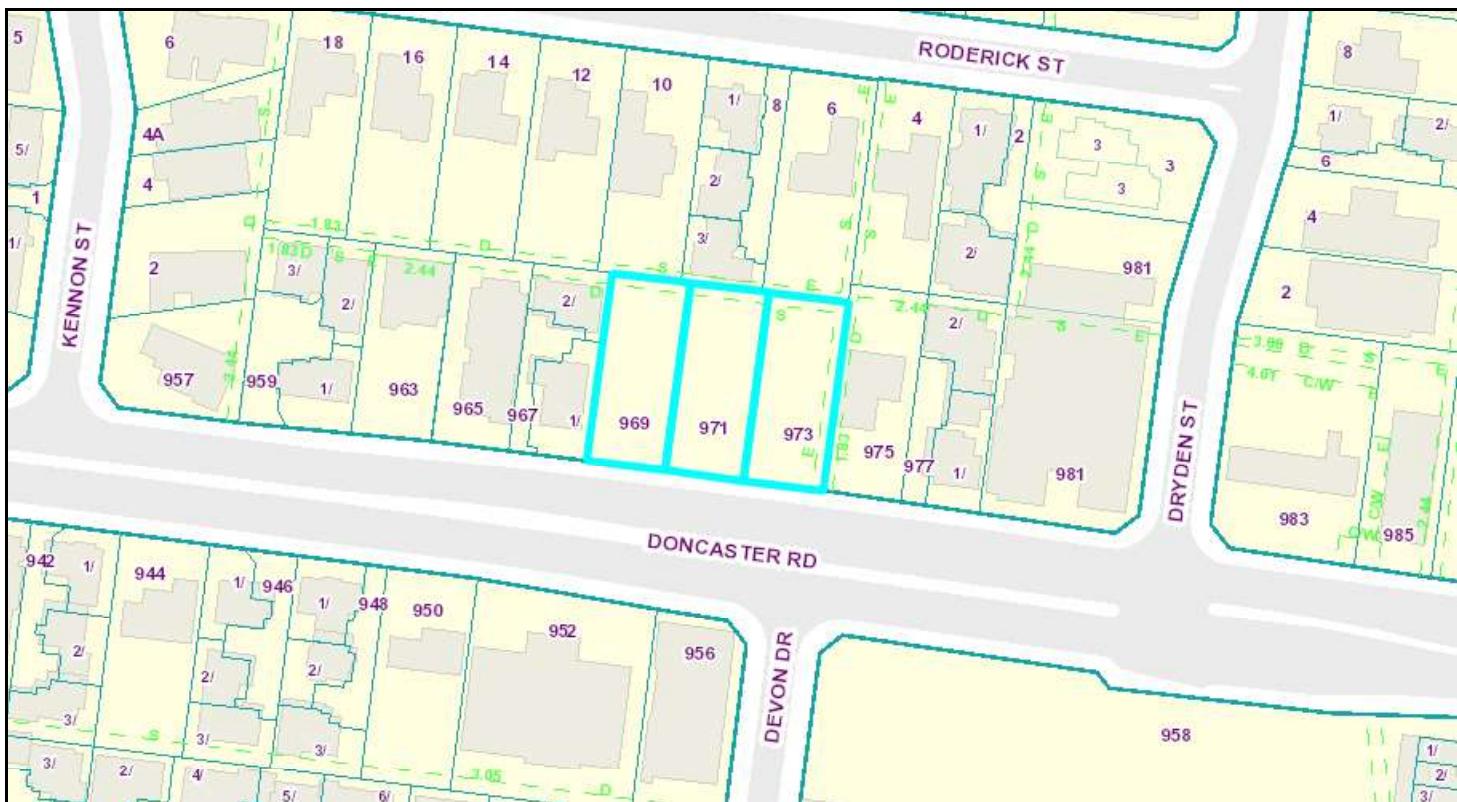

**Subject Land**

**Address:**

969 Doncaster Road, DONCASTER EAST 3109




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Metres 25 50 75

15/07/2020 10:09 am



## PLN19/0226 - 969-973 DONCASTER ROAD, DONCASTER EAST

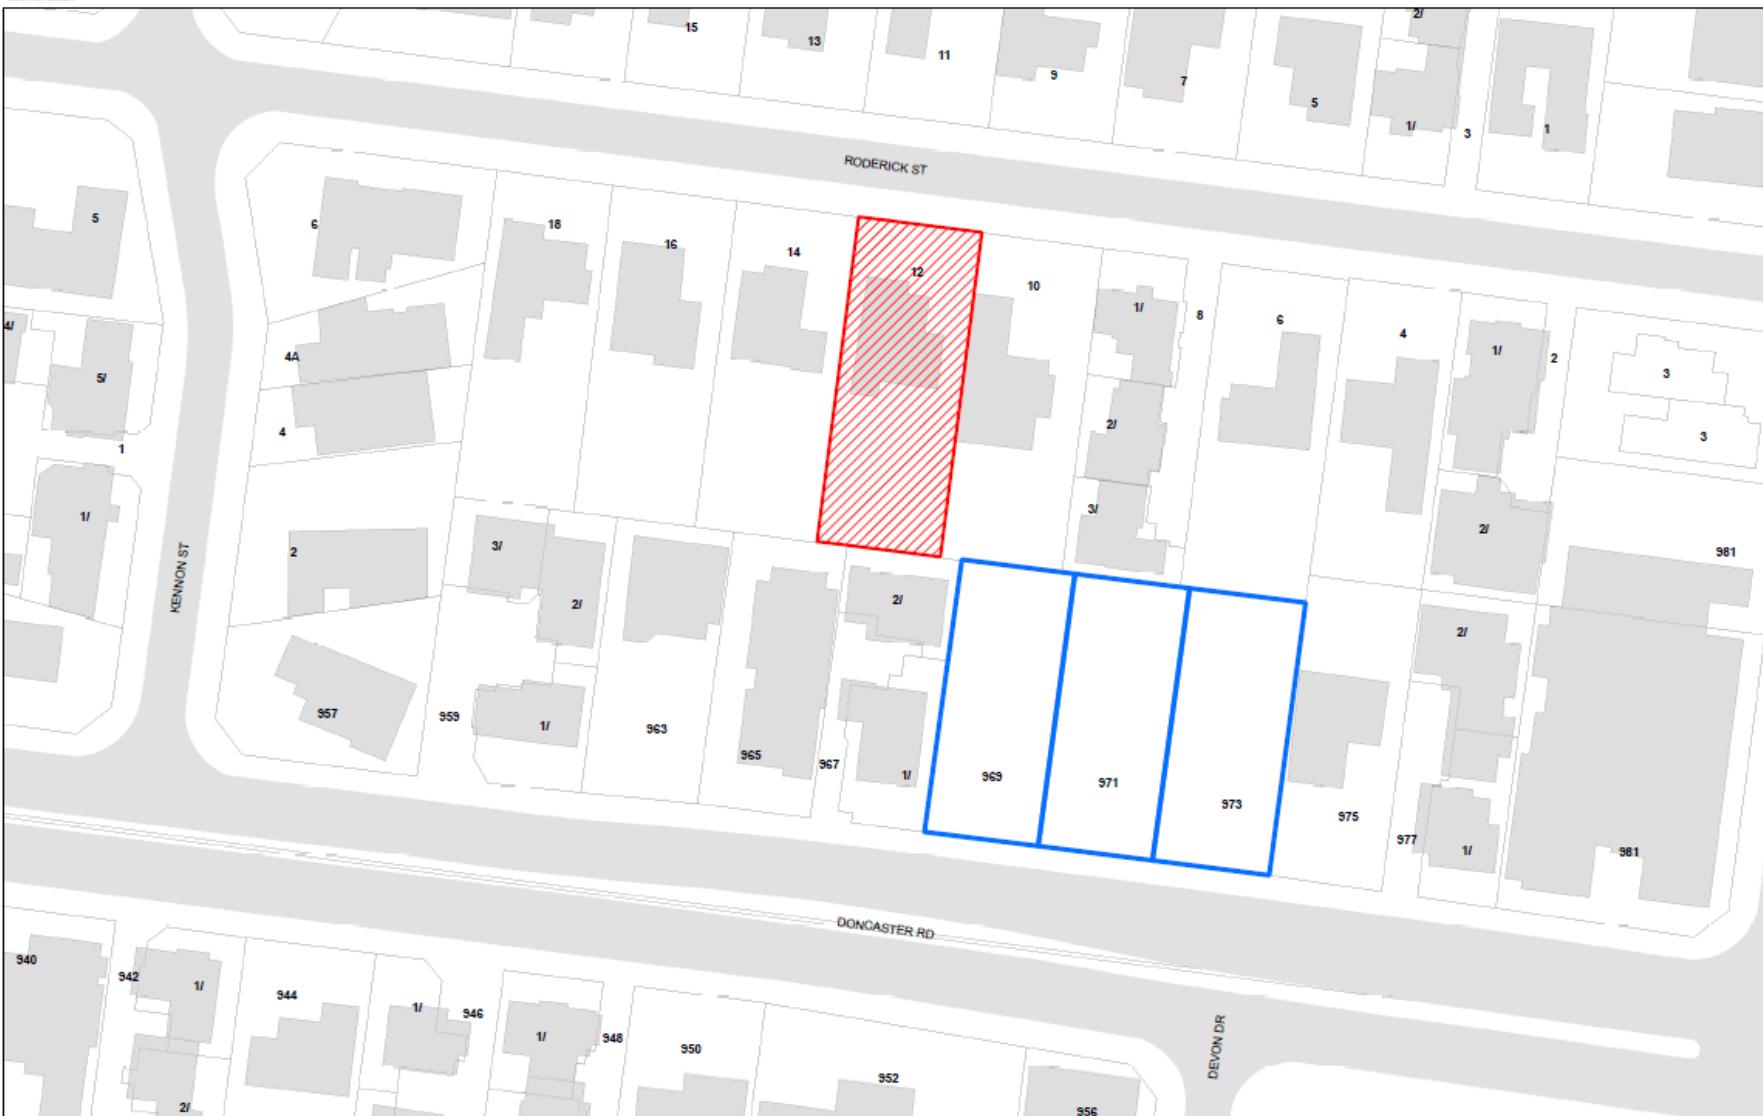

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969-973 Doncaster Road   Suburb Boundaries  
 Objector   Open Space