



Maps of Manningham

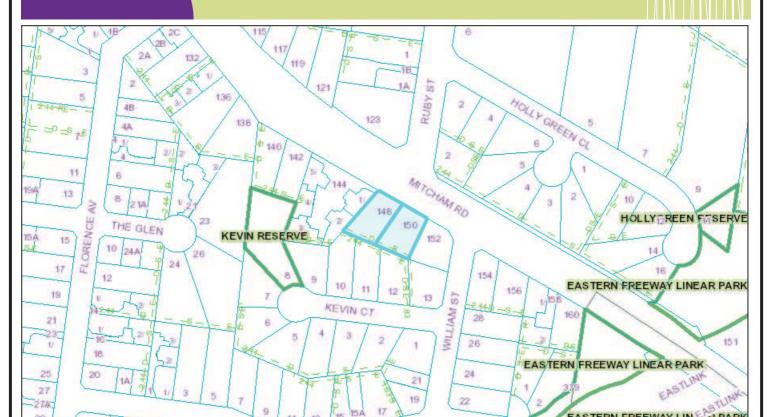

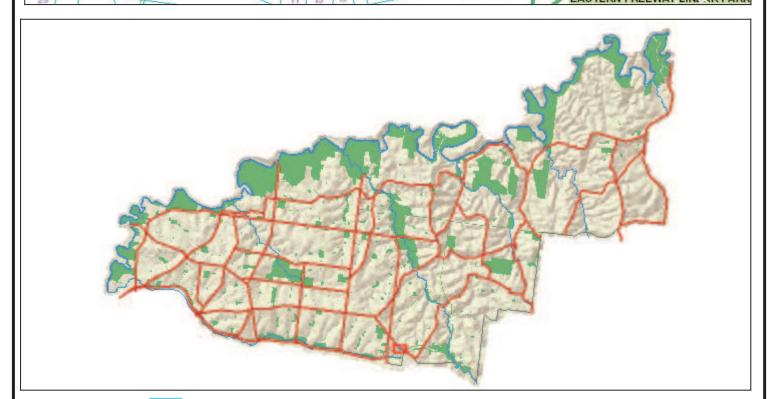


Subject Land

Address: 148 - 150 Mitcham Road DONVALE VIC, 3111

Whilst all care has been taken in the preparation of this cadastral base map, Manningham and the State of Victoria accepts no responsibility for the accuracy of any information shown. Users should rely on their own enquiries in order to validate information shown on this map. This information is for Demonstration only.



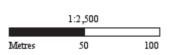

17/03/2016 11:58 AM



148 - 150 MITCHAM ROAD, DONVALE

TOWN PLANNING [REV F] - SEP 2015

DRAWING SET

TP01	Existing Site Plan
TP02	Basement Floor Plan
TP03	Ground Floor Plan
TP04	First Floor Plan
TP05	Second Floor Plan
TP06	Roof Plan
TP07	North & South Elevations
TP08	East & West Elevations
TP09	Sections
TP10	Shadow Diagram At 9am
TP11	Shadow Diagram At 12pm
TP12	Shadow Diagram At 3pm
TP13	Design Response Plan
TP14	Site Analysis & Locality Description Plan
TP15	Site Photographs & Existing Streetscape



Rev	Description	Date
Α	PRE-APPLICATION ISSUE	Nov 2014
В	29/01/2015	
С	13/04/2015	
D	AMENDMENT AS PER COUNCIL MEETING DATED 23/05/2015	25/05/2015
Е	AMENDED AS PER COUNCIL COMMENTS DATED 22/06/2015	20/07/2015
F	AMENDED AS PER COUNCIL COMMENTS DATED 16/09/2015	29/09/2015



PROJECT
RESIDENTIAL APARTMENT BUILDING
148-150 MITCHAM ROAD, DONVALE
CLIENT BEHZAD EGHRARI

ALL WORK SHALL CONFORM TO THE SPECIFICATION AND OTHER RELEVANT DRAWINGS FIGURED DIMENSIONS TAKE PREFERENCE OVER SCALE DIMENSIONS CHECK ALL STATEMENT OF THE STA

DRAWING TITLE

Cover Sheet

AND TAKE	DRAWN	CHECKED	DATE
ALL BE E THE	N.E.	S.R.	22 S
F THE ECTS ST BE	SCALE		PROJECT NUM
THIS		1 · 1	

EXISTING NEIGHBOURHOOD CHARACTERISTICS:

THESE AREAS ARE WITHIN CLOSE PROXIMITY TO ACTIVITY CENTRES (LOCAL SHOPPING CENTRES) AND COMMUNITY FACILITIES. THE EXTENT TO WHICH THE PRECINCT APPLIES AROUND ACTIVITY CENTRES VARIES FOR EACH CENTRE.

THE LOCATION OF THE PRECINCT BOUNDARIES IS INFLUENCED BY FACTORS INCLUDING: PROXIMITY TO FACILITIES AND SERVICES; THE ROLE OF THE CENTRE, FOR EXAMPLE, IF IT SERVES THE LOCAL NEIGHBOURHOOD, OR HAS A BROADER CATCHMENT; STREET PATTERN; PUBLIC TRANSPORT; SCHOOLS; TOPOGRAPHY, PARTICULARLY, IF IT IS WITHIN WALKING DISTANCE.. THIS PRECINCT GENERALLY IS GENERALLY LOCATED BETWEEN 150M – 400M OF AN ACTIVITY CENTRE.

THE MAIN ROADS IDENTIFIED IN THIS PRECINCT ARE DONCASTER, TRAM AND ELGAR ROADS, MANNINGHAM AND PART OF THOMPSONS, BLACKBURN AND MITCHAM ROADS. THESE AREAS ARE DEVELOPED WITH A RANGE OF COMMERCIAL AND RESIDENTIAL AREAS. WHILLIST LANDSCAPING EXISTS ALONG THE MAIN ROADS, THERE ARE OPPORTUNITIES TO INTRODUCE BETTER LANDSCAPING STANDARDS TO IMPROVE THE APPEARANCE OF THE MAIN ROADS IN THE MUNICIPALITY.

MANY OF THESE AREAS WERE DEVELOPED BETWEEN THE 1950'S AND 1960'S, WITH SOME DEVELOPMENT OCCURRING AROUND THE 1970'S. WHILST AREAS WITHIN THE PRECINCT REMAIN INTACT, WITH VERY LITTLE REDEVELOPMENT OCCURRING, OTHER AREAS HAVE EXPERIENCED A SIGNIFICANT LEVEL OF CHANGE, WHERE THE ORIGINAL HOUSE HAS BEEN DEMOLISHED AND REPLACED WITH A UNIT DEVELOPMENT.

A SUBSTANTIAL LEVEL OF CHANGE IS ANTICIPATED IN PRECINCT 2. THIS AREA WILL BE THE FOCUS FOR HIGHER DENSITY DEVELOPMENTS. THREE STOREY BUILDINGS, INCLUDING 'APARTMENT-STYLE' DEVELOPMENTS WILL BE ENCOURAGED ON LARGER LOTS.

SITE:

THE SUBJECT SITES ARE LOCATED ON MITCHAM ROAD, EACH SITE CONTAINS A SINGLE STOREY BRICK VENEER DWELLING WITH A TILED PITCH ROOF. THE COMBINED LAND AREA IS 1354sqm ALLOWING TO ACHIEVE A RESIDENTIAL DEVELOPMENT WHICH CONTRIBUTES TO A PREFERRED NEIGHBOURHOOD CHARACTER IN A RESIDENTIAL GROWTH ZONE AREA.


FACILITIES:

MANNINGHAM IS LOCATED 12 KILOMETRES EAST OF THE MELBOURNE CBD. THE SITE IS LOCATED WITHIN THE RESIDENTIAL GROWTH ZONE AND TAKES ADVANTAGE OF LOCAL TRANSPORT FACILITIES AND SHOPPING CENTRES. THERE IS BUS STATION, WITH FREEWAY IN CLOSE VICINITY THERE ARE VARIOUS SHOPPING CENTRES, SUPERMARKETS AND RESTAURANTS WITH IN A 5 KM RADIUS OF THE SITE, PLUS EXTENSIVE PARK LANDS AND PUBLIC OPEN SPACES. VARIOUS PRIMARY AND SECONDARY SCHOOLS ARE CLOSE BY, WHICH ALL SUPPORT THIS DEVELOPMENT AND MELBOURNE 2030 PLAN.

LOCAL AMENITY SCHEDULE

TITLE		NAME	DISTANCE (km)	
1	ACCESS TO PUBLIC TRANSPORT	ACCESS TO PUBLIC TRANSPORT Bus Routes 271,907		E
2	UNIVERSITY	Deakin University, Melbourne Burwood Campus	8.00	SW
3	3 MEDICAL FACILITIES North Mitcham Clinic		0.53	NW
4	PARK	Ronald E Gray Reserve	0.76	SW
5	SPORT PLACE	BTYC Gymnastics	0.46	W
6	SHOPPING CENTRE	Mitcham Shopping Centre	1.80	SE
7	PRIMARY SCHOOL	Heatherwood School	0.51	W
8	SECONDARY COLLEGE	Blackburn High School	3.10	W
9	PLACE OF WORSHIP	Donvale Presbyterian Church	0.62	NW
10	DISTANCE TO CBD	CBD	19.00	W



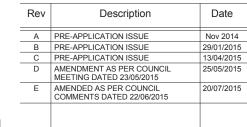

Plot Date: 27/07/2015 5:39:13 PM



PO BOX 59
IVANHOE VIC 3079 AUSTRALIA

info@canopus.net.au www.canopus.net.au

T: +61 3 9420 9720 M: +61 4 1345 4654 RESIDENTIAL APARTMENT BUILDING

148-150 MITCHAM ROAD, DONVALE

CLIENT BEHZAD EGHRARI

ALL WORK SHALL CONFORM TO THE SPECIFICATION AND OTHER RELEVANT DRAWINGS FIGURED DIMENSIONS TAKE PREFERENCE OVER SCALED DIMENSIONS OF INCK ALL SUBMITTED DOS TO GOVERN FOR SPRINGVAL SEFORE THE COMMENCEMENT OF ANY FABRICATION, COPYRIGHT OF THE COMMENCEMENT OF ANY FABRICATION, COPYRIGHT OF THE CONTENTS OF THIS DRAWING IS RETURNED BY ARCHITECTS (CANOPUS GROUP PTY LTD.) WRITTEN CONSENT MUST BE OBTAINED PRIOR TO ANY USE OR REPRODUCTION OF THIS DRAWING IN FULL OR IN PART. ©

DRAWING TITLE

Existing Site Plan


 DRAWN
 CHECKED
 DATE

 N.E.
 S.R.
 20 JUL 2015


 SCALE
 PROJECT NUMBER

 1:200
 140968



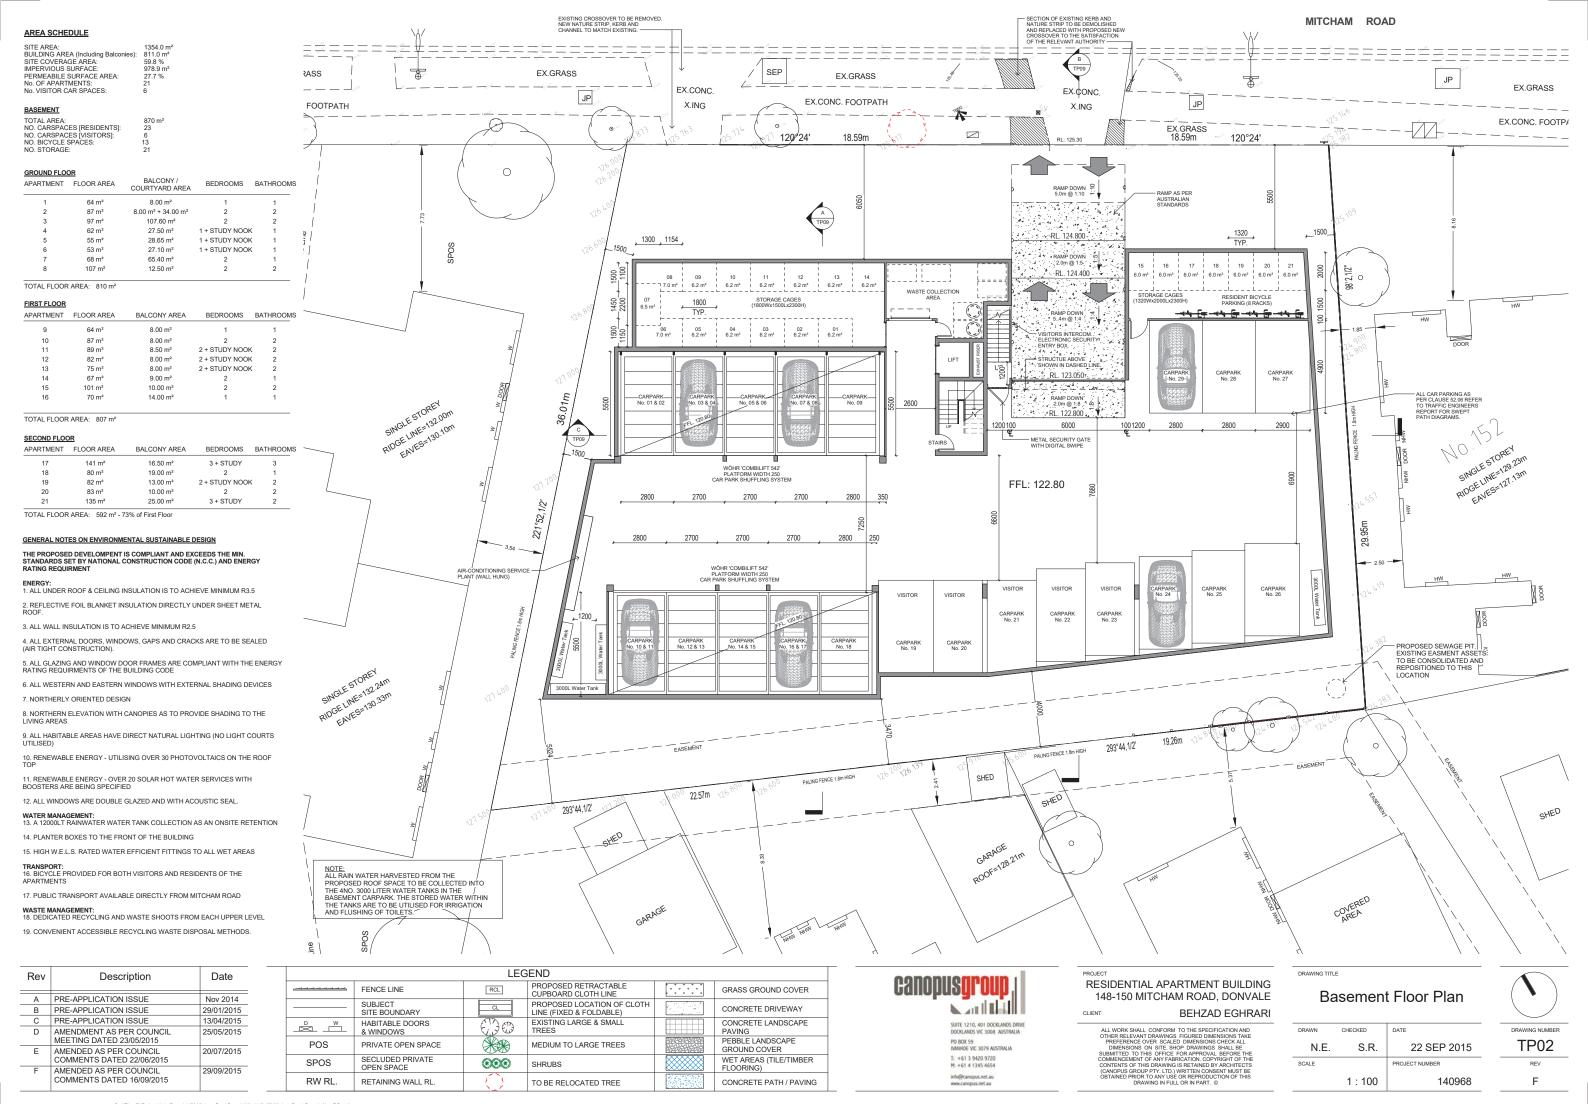

Date: 8/10/2015 11:04:31 AM Cad File: D:\Projects\Oobs\Donvale\150-Mitcham-Road-Donvale\Niaz\148-150 Mitcham Road, Donvale New F Permit.rvt

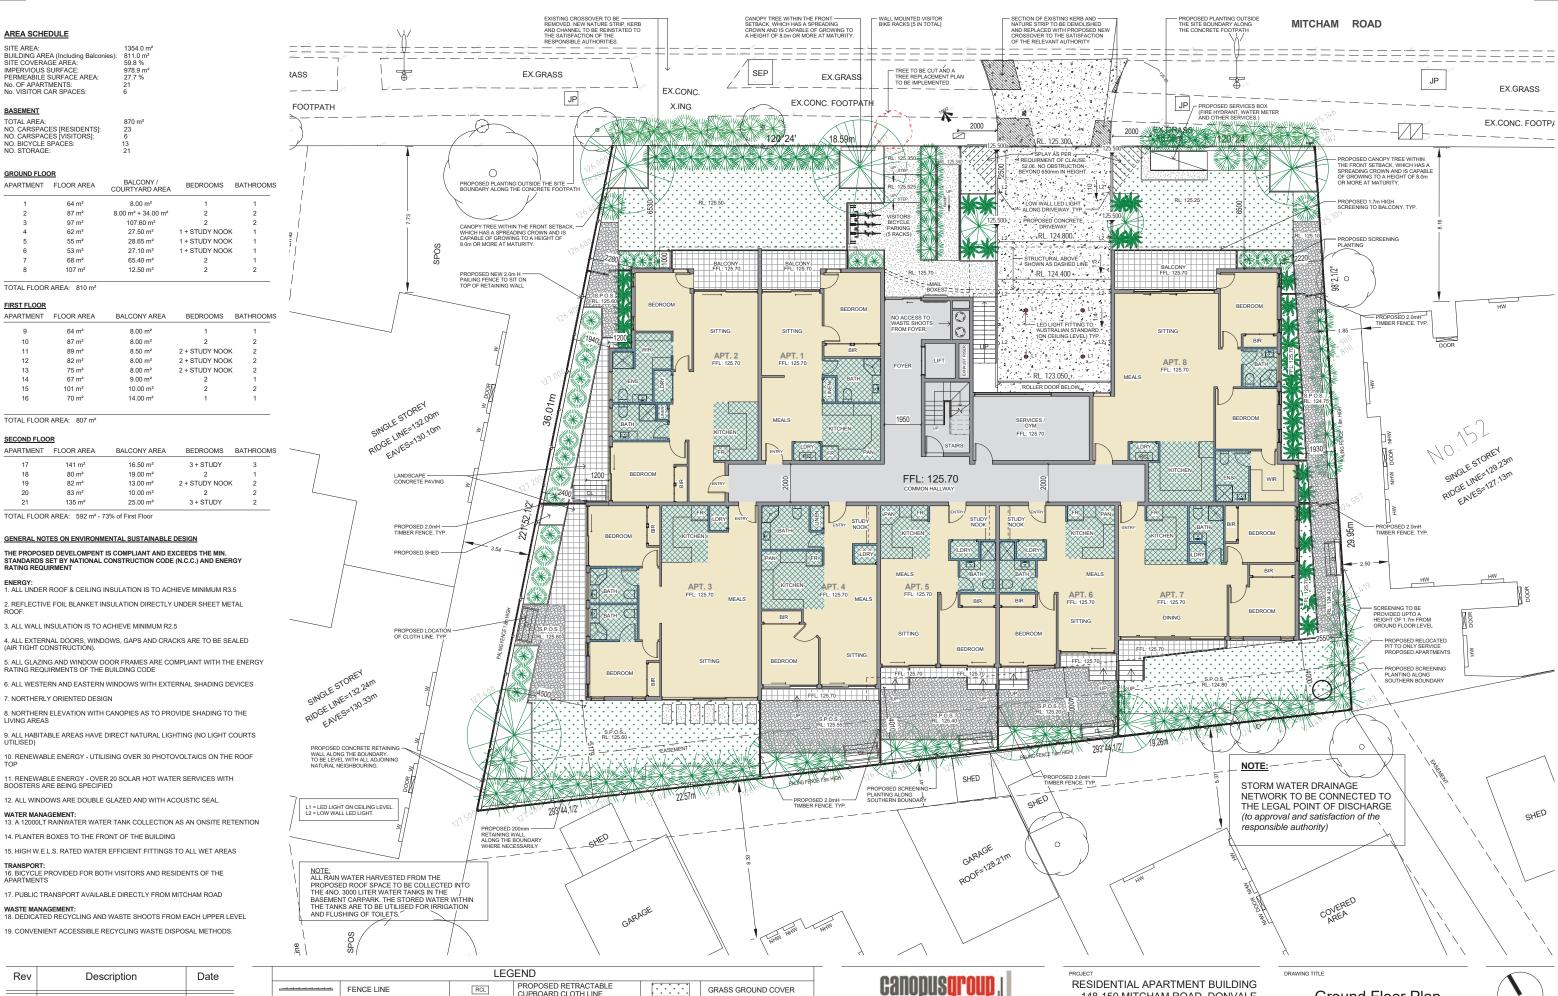

Rev	Rev Description				
Α	PRE-APPLICATION ISSUE	Nov 2014			
В	PRE-APPLICATION ISSUE	29/01/2015			
С	PRE-APPLICATION ISSUE	13/04/2015			
D	AMENDMENT AS PER COUNCIL MEETING DATED 23/05/2015	25/05/2015			
Е	AMENDED AS PER COUNCIL COMMENTS DATED 22/06/2015	20/07/2015			
F	AMENDED AS PER COUNCIL COMMENTS DATED 16/09/2015	29/09/2015			

	LEGEND					
	FENCE LINE SUBJECT SITE BOUNDARY HABITABLE DOORS & WINDOWS POS PRIVATE OPEN SPACE		RCL	PROPOSED RETRACTABLE CUPBOARD CLOTH LINE		GRASS GROUND COVER
			CL	PROPOSED LOCATION OF CLOTH LINE (FIXED & FOLDABLE)		CONCRETE DRIVEWAY
			(D)	EXISTING LARGE & SMALL TREES		CONCRETE LANDSCAPE PAVING
			***	MEDIUM TO LARGE TREES		PEBBLE LANDSCAPE GROUND COVER
	SPOS	SECLUDED PRIVATE OPEN SPACE	666	SHRUBS		WET AREAS (TILE/TIMBER FLOORING)
	RW RL.	RETAINING WALL RL.		TO BE RELOCATED TREE		CONCRETE PATH / PAVING



info@canopus.net.au www.canopus.net.au

148-150 MITCHAM ROAD, DONVALE BEHZAD EGHRARI

ALL WORK SHALL CONFORM TO THE SPECIFICATION AND OTHER RELEVANT DRAWINGS FIGURED DIMENSIONS TAKE PREFERENCE OVER SCALED DIMENSIONS CHECK ALL SHAPE OF THE STATE OF THE STATE OF THE STATE OF THE COMMENCEMENT OF ANY FABRICATION COPYRIGHT OF THE STATE OF T

Ground Floor Plan



N.E. S.R. 22 SEP 2015 SCALE 140968

TP03 1:100

REV



Rev	Description	Date
Α	PRE-APPLICATION ISSUE	Nov 2014
В	PRE-APPLICATION ISSUE	29/01/2015
С	PRE-APPLICATION ISSUE	13/04/2015
D	AMENDMENT AS PER COUNCIL MEETING DATED 23/05/2015	25/05/2015
E	AMENDED AS PER COUNCIL COMMENTS DATED 22/06/2015	20/07/2015
F	AMENDED AS PER COUNCIL COMMENTS DATED 16/09/2015	29/09/2015

	LEGEND					
	FENCE LINE		RCL	PROPOSED RETRACTABLE CUPBOARD CLOTH LINE		GRASS GROUND COVER
		SUBJECT SITE BOUNDARY	CL	PROPOSED LOCATION OF CLOTH LINE (FIXED & FOLDABLE)		CONCRETE DRIVEWAY
	D W	HABITABLE DOORS & WINDOWS	(D)	EXISTING LARGE & SMALL TREES		CONCRETE LANDSCAPE PAVING
	POS PRIVATE OPEN SPACE SPOS SECLUDED PRIVATE OPEN SPACE		***	MEDIUM TO LARGE TREES		PEBBLE LANDSCAPE GROUND COVER
			666	SHRUBS		WET AREAS (TILE/TIMBER FLOORING)
	RW RL.	RETAINING WALL RL.		TO BE RELOCATED TREE		CONCRETE PATH / PAVING



info@canopus.net.au www.canopus.net.au

BEHZAD EGHRARI CLIENT

ALL WORK SHALL CONFORM TO THE SPECIFICATION AND OTHER RELEVANT DRAWINGS FIGURED DIMENSIONS TAKE PREFERENCE OVER SCALED DIMENSIONS CHECK ALL SHAPE OF THE STATE OF THE STATE OF THE COMMENCEMENT OF ANY FABRICATION. COPYRIGHT OF THE CONTENTS OF THIS DRAWINGS IS RETAINED BY ARCHITECTS (CANOPUS GROUP PTY. LTD.) WRITTEN CONSENT MUST BE OBTAINED PRIOR TO ANY USE OR REPRODUCTION OF THIS DRAWING IN FULL OR IN PART. ©



TP04

REV

DRAWN	CHECKED	DATE
N.E.	S.R.	22 SEP 2015
SCALE		PROJECT NUMBER
	1:100	140968



87 m²

82 m²

75 m²

67 m²

101 m²

TOTAL FLOOR AREA: 807 m²

APARTMENT FLOOR AREA

SECOND FLOOR

NOTES:

70 m²

141 m²

82 m²

83 m² 135 m²

TOTAL FLOOR AREA: 592 m² - 73% of First Floor

VARIATION IN MATERIALS AND TEXTURES.

APPLICATION OF SCREEN DEVICES.

8 00 m²

8.50 m²

8 00 m²

8.00 m²

9 00 m²

10.00 m²

14.00 m²

BALCONY AREA

16.50 m²

19.00 m²

13.00 m²

10.00 m

25.00 m²

THE BUILDING HAS BEEN DESIGNED TO SIT WELL WITH THE SLOPE OF THE LAND.

THE PROPOSED APARTMENT BUILDING HAS BEEN DESIGNED AND SITED TO

1 + STUDY NOOK + STUDY NOOK

1 + STUDY NOOK

2 + STUDY NOOK

2 + STUDY NOOK

2 + STUDY NOOK

3 + STUDY

2 + STUDY NOOK

3 + STUDY

SEP RASS EX.GRASS EX.GRASS JP EX.GRASS EX.CONC. EX.CONC. JP EX.CONC. FOOTPATH FOOTPATH X.ING X.ING EX.CONC. FOOTP! EX.GRASS 18.59m 120 24' <18.59m 120°24' 0 BEDROOMS BATHROOMS 4034 шш BEDROOMS BATHROOMS LIVING _1600 MEALS APT. 21 SINVILE SIVILE 13200M USE LINE 132, 10m 1950 15/ SINGLESTOREY BEDROOMS BATHROOMS SHULL 3 UNE 29 23M FFL: 131.40 52,1 221 29. MEALS APT. 20 FFL: 131.40 OBSCURE GLAZING TO BE PROVIDED FOR THE BALUSTRADE TO A HEIGHT OF 1.7m AFL FOR THE ENTIRE LENGTH. OBSCURE GLAZING TO BE MANUFACTURED APT. 18 ALL WINDOWS FACING NEIGHBOURING PROPERTIES ARE HIGHLIGH WINDOWS WITH A MINIMUM SILL HEIGHT OF 1.8m AFL. VISUAL INTEREST HAS BEEN PROVIDED THROUGH ARTICULATION, GLAZING AND THERE ARE NO BUILDINGS ON BOUNDARIES THEREFORE CREATING SPACING RIDGE LIME 132 24m THE APARTMENT BUILDING IS STEPPED DOWN AT THE REAR OF THE SITE TO PROVIDE A TRANSITION TO THE SCALE OF THE ADJOINING RESIDENTIAL AREA. WERVESE130.33M THE UPPER LEVELS OF THE APARTMENT PROVIDES ADEQUATE ARTICULATION TO REDUCE THE APPEARANCE OF VISUAL BULK AND MINIMISE CONTINUOUS SHEER WALL PRESENTATION. 19.26m 293°44,1/2′ THE UPPER LEVEL OF THE THREE STOREY APARTMENT IS 77% OF THE LOWER LEVEL. THERE IS SUFFICIENT ARCHITECTURAL INTEREST TO REDUCE THE APPEARANCE OF VISUAL BULK AND MINIMISE CONTINUOUS SHEER WALL PRESENTATION. PALING FENCE 1.8m HIGH SHED THE PROPOSED VARANIMENT BOILDING HAS BEEN DESIGNED AND SHED TO ADDRESS SLOPE CONSTRAINTS, INCLUDING MINIMISING VIEWS OF BASEMENT PROJECTIONS AND/OR MINIMISING THE HEIGHT OF FINISHED FLOOR LEVELS AND PROVIDING APPROPRIATE RETAINING WALL PRESENTATION, FURTHERMORE, IT MINIMISES OVERLOOKING AND AVOIDS THE EXCESSIVE SHED 22.57m 293°44,1/2 SHED THE SETBACK OF THE BASEMENT CAR PARK IS CONSISTENT WITH THE FRONT BUILDING SETBACK AND IS SETBACK AN AVERAGE OF 4.0m FROM THE REAR BOUNDARY TO ENABLE EFFECTIVE LANDSCAPING TO BE ESTABLISHED. GARAGE ROOF=128.21m THE BUILDING WALLS, INCLUDING BASEMENTS, ARE SITED A SUFFICIENT DISTANCE FROM SITE BOUNDARIES TO ENABLE THE PLANTING OF EFFECTIVE SCREEN PLANTING. NOTE:
ALL RAIN WATER HARVESTED FROM THE
PROPOSED ROOF SPACE TO BE COLLECTED INTO
THE 4NO. 3000 LITER WATER TANKS IN THE
BASEMENT CARPARK. THE STORED WATER WITHIN
THE TANKS ARE TO BE UTILISED FOR IRRIGATION
AND FLUSHING OF TOILETS. ALL BUILDING SERVICES ARE INTEGRATED INTO THE BUILT FORM OR SCREENED TO MINIMISE THE AESTHETIC IMPACTS AND AVOIDS UNREASONABLE AMENITY IMPACTS ON SURROUNDING PROPERTIES AND OPEN SPACES. RESIDENTIAL APARTMENT BUILDING

Rev	Description	Date
Α	PRE-APPLICATION ISSUE	Nov 2014
В	PRE-APPLICATION ISSUE	29/01/2015
С	PRE-APPLICATION ISSUE	13/04/2015
D	AMENDMENT AS PER COUNCIL MEETING DATED 23/05/2015	25/05/2015
E	AMENDED AS PER COUNCIL COMMENTS DATED 22/06/2015	20/07/2015
F	AMENDED AS PER COUNCIL COMMENTS DATED 16/09/2015	29/09/2015

	LEGEND					
	SUBJECT		RCL	PROPOSED RETRACTABLE CUPBOARD CLOTH LINE		GRASS GROUND COVER
			CL	PROPOSED LOCATION OF CLOTH LINE (FIXED & FOLDABLE)		CONCRETE DRIVEWAY
	D W	HABITABLE DOORS & WINDOWS	(D)	EXISTING LARGE & SMALL TREES		CONCRETE LANDSCAPE PAVING
	POS PRIVATE OPEN SPACE SPOS SECLUDED PRIVATE OPEN SPACE		***	MEDIUM TO LARGE TREES		PEBBLE LANDSCAPE GROUND COVER
			666	SHRUBS		WET AREAS (TILE/TIMBER FLOORING)
	RW RL.	RETAINING WALL RL.		TO BE RELOCATED TREE		CONCRETE PATH / PAVING



info@canopus.net.au www.canopus.net.au

148-150 MITCHAM ROAD, DONVALE BEHZAD EGHRARI CLIENT

ALL WORK SHALL CONFORM TO THE SPECIFICATION AND OTHER RELEVANT DRAWINGS FIGURED DIMENSIONS TAKE PREFERENCE OVER SCALED DIMENSIONS CHECK ALL SHAPE OF THE STATE OF THE STATE OF THE COMMENCEMENT OF ANY FABRICATION COPYRIGHT OF THE STATE OF T

Second Floor Plan

MITCHAM ROAD





AREA SCHEDULE

SITE AREA:
BUILDING AREA (Including Balconies):
SITE COVERAGE AREA:
IMPERVIOUS SURFACE:
PERMEABILE SURFACE AREA:
No. OF APATIMENTS:
No. VISITOR CAR SPACES:

BASEMENT

TOTAL AREA:
NO. CARSPACES [RESIDENTS]:
NO. CARSPACES [VISITORS]: NO. BICYCLE SPACES: NO. STORAGE:

GROUND FLOOR

APARTMENT	FLOOR AREA	BALCONY / COURTYARD AREA	BEDROOMS	BATHROOMS
1	64 m²	8.00 m²	1	1
2	87 m²	8.00 m ² + 34.00 m ²	2	2
3	97 m²	107.60 m ²	2	2
4	62 m²	27.50 m ²	1 + STUDY NOOK	. 1
5	55 m²	28.65 m ²	1 + STUDY NOOK	. 1
6	53 m²	27.10 m ²	1 + STUDY NOOK	. 1
7	68 m²	65.40 m ²	2	1
8	107 m²	12.50 m ²	2	2

TOTAL FLOOR AREA: 810 m²

FIRST FLOOR

APARTMENT	FLOOR AREA	BALCONY AREA	BEDROOMS	BATHROOM
9	64 m²	8.00 m²	1	1
10	87 m²	8.00 m ²	2	2
11	89 m²	8.50 m²	2 + STUDY NOOK	2
12	82 m²	8.00 m ²	2 + STUDY NOOK	2
13	75 m²	8.00 m ²	2 + STUDY NOOK	2
14	67 m²	9.00 m ²	2	1
15	101 m ²	10.00 m ²	2	2
16	70 m²	14.00 m ²	1	1

TOTAL FLOOR AREA: 807 m²

SECOND FLOOR

APARTMENT	FLOOR AREA	BALCONY AREA	BEDROOMS	BATHROOM
17	141 m²	16.50 m²	3 + STUDY	3
18	80 m²	19.00 m ²	2	1
19	82 m²	13.00 m ²	2 + STUDY NOOK	2
20	83 m²	10.00 m ²	2	2
21	135 m²	25.00 m ²	3 + STUDY	2

TOTAL FLOOR AREA: 592 m² - 73% of First Floor

GENERAL NOTES ON ENVIRONMENTAL SUSTAINABLE DESIGN

THE PROPOSED DEVELOMPENT IS COMPLIANT AND EXCEEDS THE MIN. STANDARDS SET BY NATIONAL CONSTRUCTION CODE (N.C.C.) AND ENERGY RATING REQUIRMENT

ENERGY:1. ALL UNDER ROOF & CEILING INSULATION IS TO ACHIEVE MINIMUM R3.5

2. REFLECTIVE FOIL BLANKET INSULATION DIRECTLY UNDER SHEET METAL ROOF.

3. ALL WALL INSULATION IS TO ACHIEVE MINIMUM R2.5

4. ALL EXTERNAL DOORS, WINDOWS, GAPS AND CRACKS ARE TO BE SEALED (AIR TIGHT CONSTRUCTION).

5. ALL GLAZING AND WINDOW DOOR FRAMES ARE COMPLIANT WITH THE ENERGY RATING REQUIRMENTS OF THE BUILDING CODE

6. ALL WESTERN AND EASTERN WINDOWS WITH EXTERNAL SHADING DEVICES

7. NORTHERLY ORIENTED DESIGN

8. NORTHERN ELEVATION WITH CANOPIES AS TO PROVIDE SHADING TO THE

9. ALL HABITABLE AREAS HAVE DIRECT NATURAL LIGHTING (NO LIGHT COURTS UTILISED)

10. RENEWABLE ENERGY - UTILISING OVER 30 PHOTOVOLTAICS ON THE ROOF TOP 11. RENEWABLE ENERGY - OVER 20 SOLAR HOT WATER SERVICES WITH BOOSTERS ARE BEING SPECIFIED

12. ALL WINDOWS ARE DOUBLE GLAZED AND WITH ACOUSTIC SEAL.

WATER MANAGEMENT:
13. A 12000LT RAINWATER WATER TANK COLLECTION AS AN ONSITE RETENTION

14. PLANTER BOXES TO THE FRONT OF THE BUILDING

15. HIGH W.E.L.S. RATED WATER EFFICIENT FITTINGS TO ALL WET AREAS TRANSPORT:

16. BICYCLE PROVIDED FOR BOTH VISITORS AND RESIDENTS OF THE APARTMENTS 17. PUBLIC TRANSPORT AVAILABLE DIRECTLY FROM MITCHAM ROAD

WASTE MANAGEMENT:
18. DEDICATED RECYCLING AND WASTE SHOOTS FROM EACH UPPER LEVEL

19. CONVENIENT ACCESSIBLE RECYCLING WASTE DISPOSAL METHODS.

Description Date A PRE-APPLICATION ISSUE Nov 2014 PRE-APPLICATION ISSUE 29/01/2015 C PRE-APPLICATION ISSUE 13/04/2015 AMENDMENT AS PER COUNCIL 25/05/2015 AMENDED AS PER COUNCIL COMMENTS DATED 22/06/2015 20/07/2015 AMENDED AS PER COUNCIL 29/09/2015 COMMENTS DATED 16/09/2015





SUITE 1210, 401 DOCKLANDS DRIVE DOCKLANDS VIC 3008 AUSTRALIA PO BOX 59 IVANHOE VIC 3079 AUSTRALIA

T: +61 3 9420 9720 M: +61 4 1345 4654 info@canopus.net.au www.canopus.net.au

148-150 MITCHAM ROAD, DONVALE

BEHZAD EGHRARI

ALL WORK SHALL CONFORM TO THE SPECIFICATION AND OTHER RELEVANT DRAWINGS FIGURED DIMENSIONS TAKE PREFERENCE OVER SCALED DIMENSIONS CHECK ALL SHAPE OF THE STATE OF THE STATE OF THE COMMENCEMENT OF ANY FABRICATION COPYRIGHT OF THE STATE OF T

Roof Plan

CHECKED

Author Checker 22 SEP 2015 SCALE 1:100 140968 TP06 REV



MITCHAM ROAD STREETSCAPE - NORTH ELEVATION



SOUTH ELEVATION



SOUTH EASTERN PERSPECTIVE SHOWN ARTICULATION

Rev	Description	Date		LEGEND	
Α	PRE-APPLICATION ISSUE	Nov 2014	1st FFL	FIRST FLOOR FINISH LEVEL	OBSCURED WINDOW TO 1.7m HIGH
В	PRE-APPLICATION ISSUE	29/01/2015	4 4 501		
С	PRE-APPLICATION ISSUE	13/04/2015	1st FCL	FIRST FLOOR CEILING LEVEL	OBSCURED BALUSTRADE TO 1.7m HIGH
D	AMENDMENT AS PER COUNCIL MEETING DATED 23/05/2015	25/05/2015	0	OPERABLE WINDOW	 LINE OF PROPOSED CUT AREA
E	AMENDED AS PER COUNCIL	20/07/2015	F	FIXED WINDOW	 NATURAL GROUND LEVEL LINE
	COMMENTS DATED 22/06/2015		NGL	NATURAL GROUND LEVEL	
F	AMENDED AS PER COUNCIL	29/09/2015	1100	101101012 01100113 22722	
	COMMENTS DATED 16/09/2015		RW RL.	RETAINING WALL RL.	



NOTES:

ALL WINDOWS AND BALCONIES OVERLOOKING INTO THE ADJOINING NEIGHBORING PRIVATE OPEN SPACES AND HABITABLE WINDOWS, WILL BE OBSCURED (FROSTED GLASS) WITH A MAXIMUM 25% TRANSPARENCY AND 1.7 METER IN HIGH FROM THE FINISHED FLOOR LEVEL.

ARTICULATION OF THE WALLS AND USE OF VARYING MATERIALS TO THE FAÇADE, BALUSTRADES, WINDOWS, AND CLADDINGS PROVIDED VISUAL INTEREST, AND REDUCES SHEER WALLS.

TO REDUCE VISUAL BULK AND INCREASING LANDSCAPING OPPORTUNITIES NO WALLS ON BOUNDARIES HAVE BEEN PROPOSED FOR THIS DEVELOPMENT.

IN FURTHER REDUCING VISUAL BULK AND PROVIDING A REDUCED BUILDING SCALE TRANSITION, A TIER CAKE STEPPING DOWN EFFECT HAS BEEN ADOPTED TO THE REAR AND SIDES (SOUTHERN, EASTER, AND WESTERN ELEVATIONS) OF PROPOSED DEVELOPMENT.

THE PROPOSED DEVELOPMENT HAS BEEN SITED INTO THE LAND (BY WAY OF EXCAVATION OF THE LAND) AS SUCH, TO TAKE ADVANTAGE OF THE NATURAL LAND SLOPE OF SUBJECT SITES. THIS IS TO MINIMIZE OR ELIMINATE MATTERS OF OVERLOOKING, OVER SHADOWING, VISUAL SCALE OF THE BUILDING, AND HAVING A BASEMENT CAR PARK.

THE PROPOSED DESIGN HAS TAKEN INTO CONSIDERATION OF ELIMINATING VISUAL OBTRUSIVENESS OF CAR PARK FROM THE STREET FRONT, AND HAVE PROPOSED THE DESIGN TO HAVE A FULLY SUBMERGED BASEMENT CAR PARK, WHICH IS NOT VISIBLE FROM THE STREET FRONT.

NO OPEN CAR PARK OR SEMI-RECESSED CAR PARK HAS BEEN PROPOSED FOR THIS DEVELOPMENT. THE CAR PARK REQUIREMENTS HAS BEEN INTEGERATED INTO THE PROPOSED DESIGN, BY DESIGNING A FULLY SUBMERGED BASEMENT CAR PARK, HENCE ELIMINATING THE USE OF OPEN CAR PARK AND OR SEMI RECESSED BASEMENT CAR PARKING.

THE BASEMENT CAR PARK REAR (SOUTHERN) SET BACK IS AN AVERAGE OF 4.0 METERS. EFFECTIVELY ENABLING LANDSCAPING OPPORTUNITIES.

THE BUILDING WALLS, INCLUDING BASEMENTS, ARE SITED A SUFFICIENT DISTANCE FROM SITE BOUNDARIES TO ENABLE THE PLANTING OF EFFECTIVE SCREEN PLANTING, INCLUDING CANOPY TREES, IN LARGER SPACES.

THE INTEGRATION OF SERVICES, EQUIPMENT'S AND LIFT OVER RUNS WITHIN THE PROPOSED DESIGN, HAVE BEEN CONSIDERED AND SELECTED IN SUCH A WAY AS NOT TO BE VISIBLE FROM STREET FRONTAGE. THUS AVOIDING REQUIREMENTS OF SCREENING ON TOP OF THE ROOF AND AFFECTING THE STREETSCAPE AND AVOIDS UNREASONABLE AMENITY IMPACTS ON SURROUNDING PROPERTIES AND STREETSCAPES

COLOUR & MATERIAL SO MATERIAL	COLOUR COLOUR
ZINC CLADDING DARK CHARCOLE	1
CEDER TIMBER CLADDING	
FLUTED SCORNED CONCRETE	
SHEET METAL ROOFING	
SELECTED NUTRAL RENDER FINISH. (LIGHT & DARK COLOR)	
PRECAST CONCRETE PANEL (LIGHT GRAY COLOR)	
ALL EXTERIOR WINDOWS AND DOORS FRAMES TO BE IN BLACK ANODIASED ALUMINUM	
TIMBER FEATURE FINS	
GREEN FROSTED GLASS TO ALL BALUSTRADES (1.7m HIGH)	
CLEAR FROSTED OBSCURED GLASS TO ALL OVERLOOKING WINDOWS (1.7m HIGH)	
CLEAR GLASS TO ALL WINDOWS AND SLIDING DOORS (TYP.)	

RESIDENTIAL APARTMENT BUILDING 148-150 MITCHAM ROAD, DONVALE BEHZAD EGHRARI

ALL WORK SHALL CONFORM TO THE SPECIFICATION AND OTHER RELEVANT DRAWINGS FIGURED DIMENSIONS TAKE PREFERENCE OVER SCALED DIMENSIONS CHECK ALL DIMENSIONS ON SITE SHOP DRAWINGS SHALL BE SHADON OF THE FOR APPOINTED THE CONFORM OF THE CO

North & South Elevations

DRAWN	CHECKED	DATE	DRAWING NUMBER
N.E.	S.R.	22 SEP 2015	TP07
SCALE		PROJECT NUMBER	REV
As	indicated	140968	F





WEST ELEVATION



NORTH-EAST STREET PERSPECTIVE

NOTES:

ALL WINDOWS AND BALCONIES OVERLOOKING INTO THE ADJOINING NEIGHBORING PRIVATE OPEN SPACES AND HABITABLE WINDOWS, WILL BE OBSCURED (*PROSTED LASS*) WITH A MAXIMUM 25% TRANSPARENCY AND 1.7 METER IN HIGH FROM THE FINISHED FLOOR LEVEL.

ARTICULATION OF THE WALLS AND USE OF VARYING MATERIALS TO THE FAÇADE, BALUSTRADES, WINDOWS, AND CLADDINGS PROVIDED VISUAL INTEREST, AND REDUCES SHEER WALLS.

TO REDUCE VISUAL BULK AND INCREASING LANDSCAPING OPPORTUNITIES NO WALLS ON BOUNDARIES HAVE BEEN PROPOSED FOR THIS DEVELOPMENT.

IN FURTHER REDUCING VISUAL BULK AND PROVIDING A REDUCED BUILDING SCALE TRANSITION, A TIER CAKE STEPPING DOWN EFFECT HAS BEEN ADOPTED TO THE REAR AND SIDES (SOUTHERN, EASTER, AND WESTERN ELEVATIONS) OF PROPOSED DEVELOPMENT.

THE PROPOSED DEVELOPMENT HAS BEEN SITED INTO THE LAND (BY WAY OF EXCAVATION OF THE LAND) AS SUCH, TO TAKE ADVANTAGE OF THE NATURAL LAND SLOPE OF SUBJECT SITES. THIS IS TO MINIMIZE OR ELIMINATE MATTERS OF OVERLOOKING, OVER SHADOWING, VISUAL SCALE OF THE BUILDING, AND HAVING A BASEMENT CAR PARK.

THE PROPOSED DESIGN HAS TAKEN INTO CONSIDERATION OF ELIMINATING THE PROPOSED DESIGN THAS TAKEN INTO CONSIDERATION OF ELIMINATING VISUAL OBTRUSIVENESS OF CAR PARK FROM THE STREET FRONT, AND HAVE PROPOSED THE DESIGN TO HAVE A FULLY SUBMERGED BASEMENT CAR PARK, WHICH IS NOT VISIBLE FROM THE STREET FRONT.

NO OPEN CAR PARK OR SEMI-RECESSED CAR PARK HAS BEEN PROPOSED FOR THIS DEVELOPMENT. THE CAR PARK REQUIREMENTS HAS BEEN INTEGERATED INTO THE PROPOSED DESIGN, BY DESIGNING A FULLY SUBMERGED BASEMENT CAR PARK, HENCE ELIMINATING THE USE OF OPEN CAR PARK AND OR SEMI RECESSED BASEMENT CAR PARKING.

THE BUILDING WALLS, INCLUDING BASEMENTS, ARE SITED A SUFFICIENT DISTANCE FROM SITE BOUNDARIES TO ENABLE THE PLANTING OIL EFFECTIVE SCREEN PLANTING, INCLUDING CANOPY TREES, IN LARGER SPACES.

THE INTEGRATION OF SERVICES, EQUIPMENT'S AND LIFT OVER RUNS WITHIN THE PROPOSED DESIGN, HAVE BEEN CONSIDERED AND SELECTED IN SUCH A WAY AS NOT TO BE VISIBLE FROM STREET FRONTAGE. THUS AVOIDING REQUIREMENTS OF SCREENING ON TOP OF THE ROOF AND AFFECTING THE STREETSCAPE AND AVOIDS UNREASONABLE AMENITY IMPACTS ON SURROUNDING PROPERTIES AND STREETSCAPES

!	COLOUR & MATERIAL SC MATERIAL	HEDULE COLOUR
	ZINC CLADDING DARK CHARCOLE	
	CEDER TIMBER CLADDING	
	FLUTED SCORNED CONCRETE	
	SHEET METAL ROOFING	
	SELECTED NUTRAL RENDER FINISH. (LIGHT & DARK COLOR)	1
	PRECAST CONCRETE PANEL (LIGHT GRAY COLOR)	
	ALL EXTERIOR WINDOWS AND DOORS FRAMES TO BE IN BLACK ANODIASED ALUMINUM	
	TIMBER FEATURE FINS	
	GREEN FROSTED GLASS TO ALL BALUSTRADES (1.7m HIGH)	
	CLEAR FROSTED OBSCURED GLASS TO ALL OVERLOOKING WINDOWS (1.7m HIGH)	

CLEAR GLASS TO ALL WINDOWS AND SLIDING DOORS (TYP.)

F

Rev	Description	Date
Α	PRE-APPLICATION ISSUE	Nov 2014
В	PRE-APPLICATION ISSUE	29/01/2015
С	PRE-APPLICATION ISSUE	13/04/2015
D	AMENDMENT AS PER COUNCIL MEETING DATED 23/05/2015	25/05/2015
Е	AMENDED AS PER COUNCIL COMMENTS DATED 22/06/2015	20/07/2015
F	AMENDED AS PER COUNCIL COMMENTS DATED 16/09/2015	29/09/2015

LEGEND				
1st FFL	FIRST FLOOR FINISH LEVEL		OBSCURED WINDOW TO 1.7m HIGH	
1st FCL	FIRST FLOOR CEILING LEVEL		OBSCURED BALUSTRADE TO 1.7m HIGH	
0	OPERABLE WINDOW		LINE OF PROPOSED CUT AREA	
F	FIXED WINDOW		NATURAL GROUND LEVEL LINE	
NGL	NATURAL GROUND LEVEL			
RW RL.	RETAINING WALL RL.			



PO BOX 59 IVANHOE VIC 3079 AUSTRALIA


T: +61 3 9420 9720 M: +61 4 1345 4654 info@canopus.net.au www.canopus.net.au


RESIDENTIAL APARTMENT BUILDING 148-150 MITCHAM ROAD, DONVALE BEHZAD EGHRARI CLIENT

ALL WORK SHALL CONFORM TO THE SPI OTHER RELEVANT DRAWINGS FIGURED DE PREFERENCE OVER SCALED DIMENSIGN DIMENSIONS ON SITE. SHOP DRAWIN SOMMITTED TO THIS OFFICE FOR APPRO-CONTENTS OF THIS DRAWINGS IS RETAINE (CANOPUS GROUP PTV. LTD.) WRITTEN CO OBTAINED PRIOR TO ANY USE OR REPRO-DRAWING IN FULL OR IN PAR

East & West Elevations

ZAD EGHRARI				
SPECIFICATION AND DIMENSIONS TAKE	DRAWN	CHECKED	DATE	DRAWING NUMBER
SIONS CHECK ALL VINGS SHALL BE ROVAL BEFORE THE	N.E.	S.R.	22 SEP 2015	TP08
COPYRIGHT OF THE NED BY ARCHITECTS CONSENT MUST BE	SCALE		PROJECT NUMBER	REV
RODUCTION OF THIS ART. ©	As	indicated	140968	F

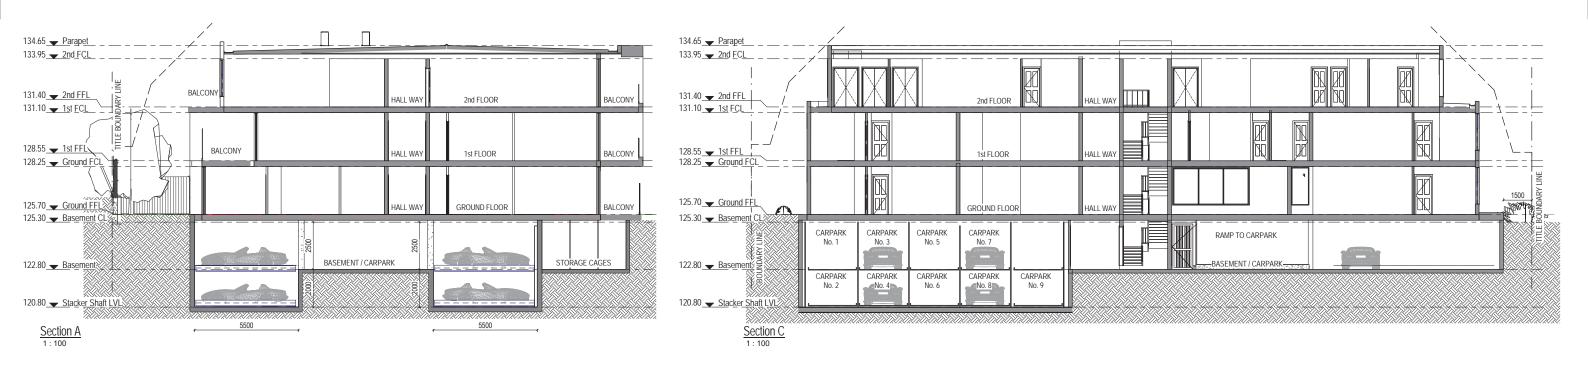

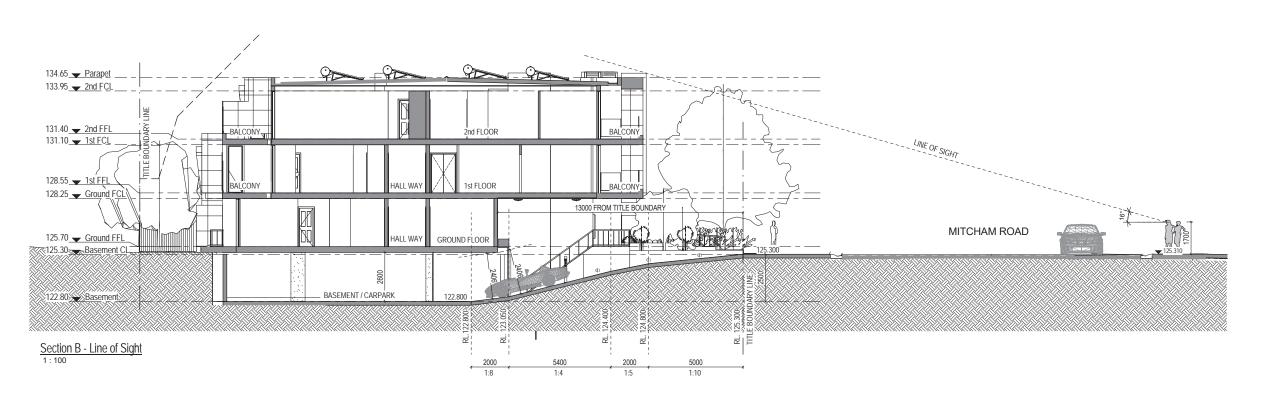

Rev	Description	Date
A	PRE-APPLICATION ISSUE	Nov 2014
В	PRE-APPLICATION ISSUE	29/01/2015
С	PRE-APPLICATION ISSUE	13/04/2015
D	AMENDMENT AS PER COUNCIL MEETING DATED 23/05/2015	25/05/2015
Е	AMENDED AS PER COUNCIL COMMENTS DATED 22/06/2015	20/07/2015
F	AMENDED AS PER COUNCIL COMMENTS DATED 16/09/2015	29/09/2015



PO BOX 59 IVANHOE VIC 3079 AUSTRALIA T: +61 3 9420 9720 M: +61 4 1345 4654

info@canopus.net.au www.canopus.net.au

RESIDENTIAL APARTMENT BUILDING 148-150 MITCHAM ROAD, DONVALE BEHZAD EGHRARI

Sections


TP09

REV

F

N.E. S.R. 22 SEP 2015 SCALE 1:100 140968

ALL WORK SHALL CONFORM TO THE SPECIFICATION AND OTHER RELEVANT DRAWINGS FIGURED DIMENSIONS TAKE PREFERENCE OVER SCALED DIMENSIONS CHECK ALL SUBMENSIONS ON SITE OF PRAWINGS. SECONET SCALES OF PRAWINGS SECONET SCALES OF THE COMMENCEMENT OF ANY FABRICATION. COPYRIGHT OF THE COMMENCEMENT OF ANY FABRICATION. COPYRIGHT OF THE COMMENCEMENT OF ANY FABRICATION. COPYRIGHT OF THE CONTENTS OF THIS DRAWINGS IS RETAINED BY ARCHITECTS (CANOPUS GROUP PTY. LTD.) WRITTEN CONSENT MUST BE OBTAINED PRIOR TO ANY USE OR REPRODUCTION OF THIS DRAWING IN FULL OR IN PART. ©

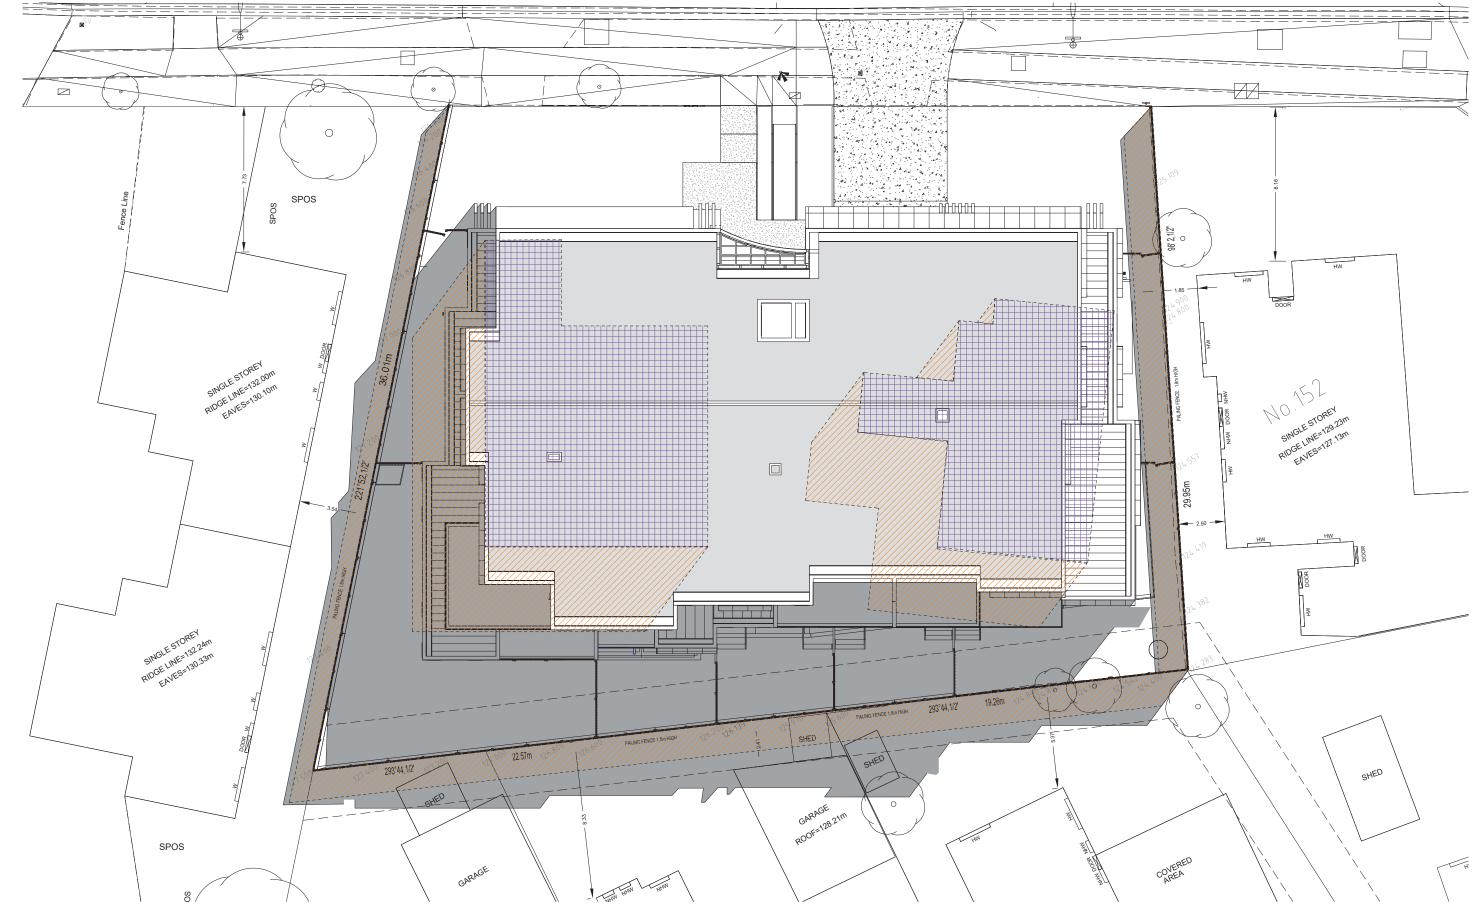

Shadow Diagram At 9 am

Description Date A PRE-APPLICATION ISSUE
B PRE-APPLICATION ISSUE Nov 2014 29/01/2015 C PRE-APPLICATION ISSUE 13/04/2015 D AMENDMENT AS PER COUNCIL MEETING DATED 23/05/2015 25/05/2015 AMENDED AS PER COUNCIL COMMENTS DATED 22/06/2015 20/07/2015 AMENDED AS PER COUNCIL 29/09/2015 COMMENTS DATED 16/09/2015

LEGEND				
	PROPOSED SHADOW			
	EXISTING SHADOW			
	EXISTING BUILDING			



SUITE 1210, 401 DOCKLANDS DRIVE DOCKLANDS VIC 3008 AUSTRALIA PO BOX 59 IVANHOE VIC 3079 AUSTRALIA

T: +61 3 9420 9720 M: +61 4 1345 4654 info@canopus.net.au www.canopus.net.au

RESIDENTIAL APARTMENT BUILDING

148-150 MITCHAM ROAD, DONVALE BEHZAD EGHRARI


ALL WORK SHALL CONFORM TO THE SPECIFICATION AND OTHER RELEVANT DRAWINGS FIGURED DIMENSIONS TAKE PREFERENCE OVER SCALED DIMENSIONS CHECK ALL DIMENSIONS ON SITE SHOP DRAWINGS SHALL BE DIMENSIONS ON SITE SHAPPING TO THE COMMENCEMENT OF ANY FABRICATION. COPYRIGHT OF THE COMMENCEMENT OF ANY FABRICATION. COPYRIGHT OF THE CONTENTS OF THIS DRAWINGS IS RETAINED BY ARCHITECTS (CANOPUS GROUP PTY. LTD.) WRITTEN CONSENT MUST BE OBTAINED PRIOR TO ANY USE OR REPRODUCTION OF THIS DRAWING IN FULL OR IN PART. ©

Shadow Diagram At 9am

DRAWN	CHECKED	DATE
N.E.	S.R.	22 SEP 2015
SCALE		PROJECT NUMBER
	1:100	140968



REV

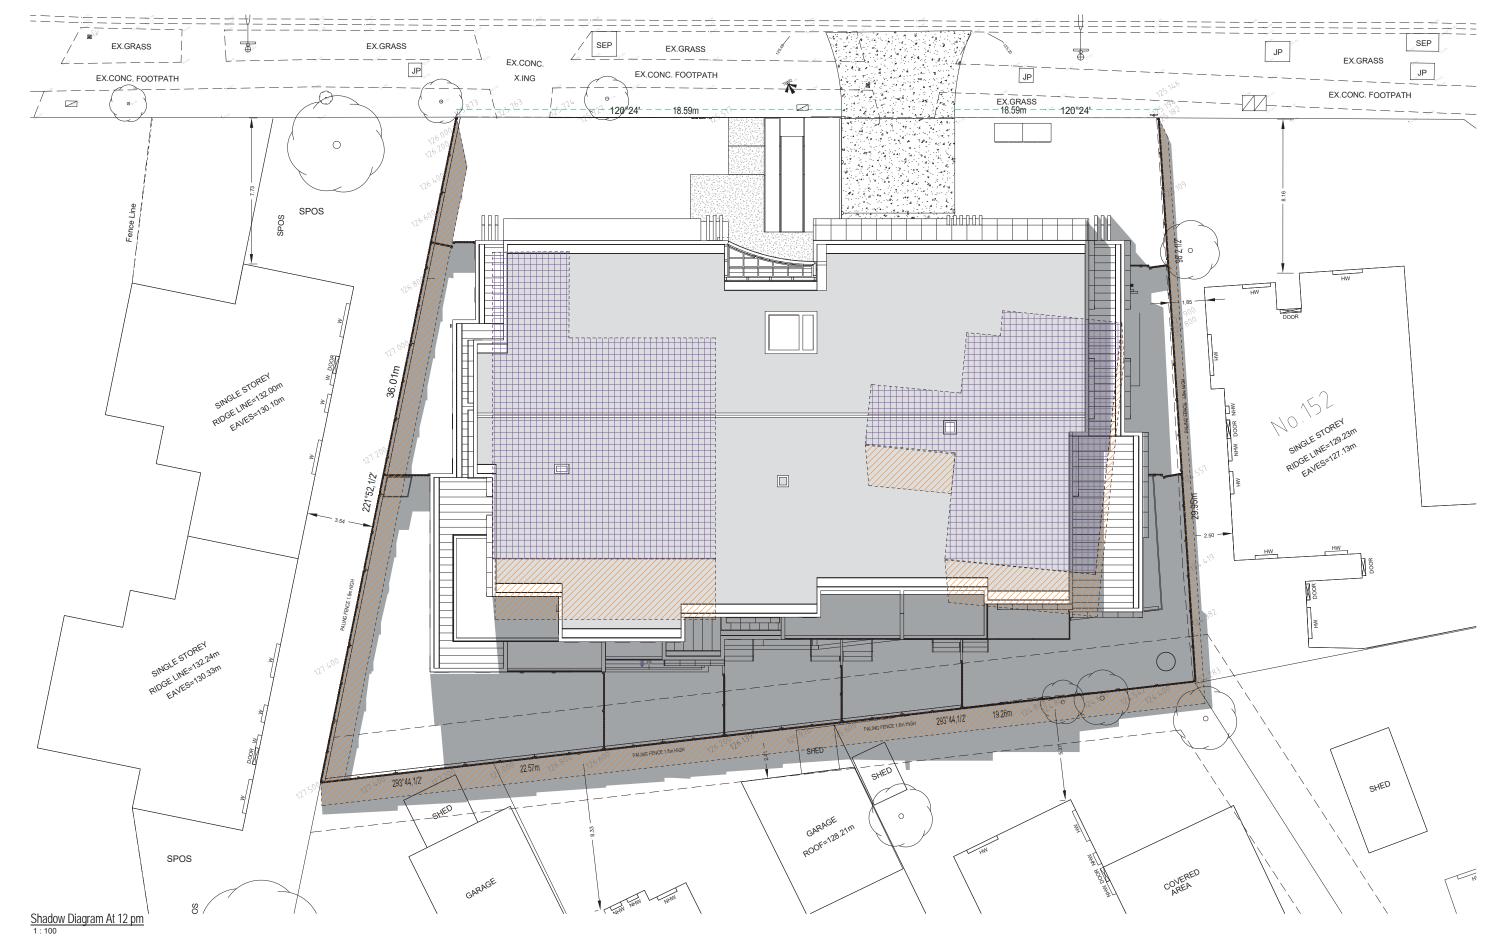

Rev	Description	Date
Α	PRE-APPLICATION ISSUE	Nov 2014
В	PRE-APPLICATION ISSUE	29/01/2015
С	PRE-APPLICATION ISSUE	13/04/2015
D	AMENDMENT AS PER COUNCIL MEETING DATED 23/05/2015	25/05/2015
Е	AMENDED AS PER COUNCIL COMMENTS DATED 22/06/2015	20/07/2015
F	AMENDED AS PER COUNCIL	29/09/2015

LEGEND			
	PROPOSED SHADOW		
	EXISTING SHADOW		
	EXISTING BUILDING		



RESIDENTIAL APARTMENT BUILDING 148-150 MITCHAM ROAD, DONVALE BEHZAD EGHRARI

ALL WORK SHALL CONFORM TO THE SPECIFICATION AND OTHER RELEVANT DRAWINGS FIGURED DIMENSIONS TAKE PREFERENCE OVER SCALED DIMENSIONS CHECK ALL SUBMENSIONS ON SITE OF PRAWINGS. SECONET SCALES OF PRAWINGS SECONET SCALES OF THE COMMENCEMENT OF ANY FABRICATION. COPYRIGHT OF THE COMMENCEMENT OF ANY FABRICATION. COPYRIGHT OF THE COMMENCEMENT OF ANY FABRICATION. COPYRIGHT OF THE CONTENTS OF THIS DRAWINGS IS RETAINED BY ARCHITECTS (CANOPUS GROUP PTY. LTD.) WRITTEN CONSENT MUST BE OBTAINED PRIOR TO ANY USE OR REPRODUCTION OF THIS DRAWING IN FULL OR IN PART. ©

Shadow Diagram At 12pm




140968

1:100



REV F

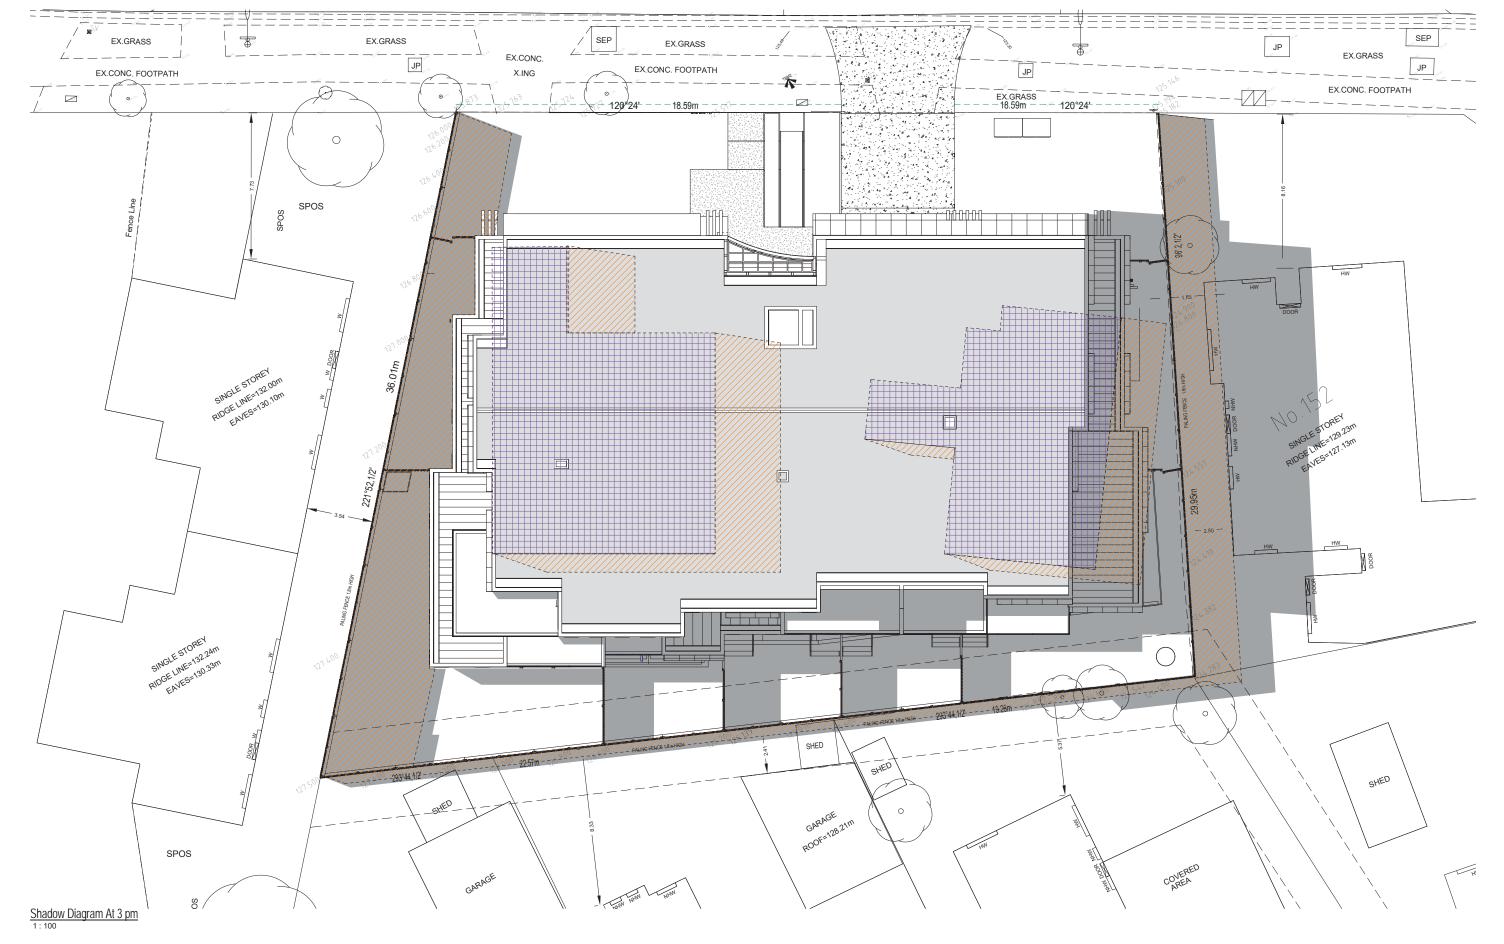

Rev	Description	Date
Α	PRE-APPLICATION ISSUE	Nov 2014
В	PRE-APPLICATION ISSUE	29/01/2015
С	PRE-APPLICATION ISSUE	13/04/2015
D	AMENDMENT AS PER COUNCIL MEETING DATED 23/05/2015	25/05/2015
Е	AMENDED AS PER COUNCIL COMMENTS DATED 22/06/2015	20/07/2015
F	AMENDED AS PER COUNCIL	29/09/2015

LEGEND			
	PROPOSED SHADOW		
	EXISTING SHADOW		
	EXISTING BUILDING		



SUITE 1210, 401 DOCKLANDS DOCKLANDS VIC 3008 AUSTRA PO BOX 59 IVANHOE VIC 3079 AUSTRALIA

T: +61 3 9420 9720 M: +61 4 1345 4654 info@canopus.net.au www.canopus.net.au PROJECT
RESIDENTIAL APARTMENT BUILDING
148-150 MITCHAM ROAD, DONVALE

CLIENT BEHZAD EGHRARI

ALL WORK SHALL CONFORM TO THE SPECIFICATION AND OTHER RELEVANT DRAWINGS FIGURED DIMENSIONS TAKE PREFERENCE OVER SCALED DIMENSIONS CHECK ALL DIMENSIONS ON SITE SHOP DRAWINGS SHEDE FIRE SUMMENSIONS OF SITE SHOP DRAWINGS SHEDE FIRE COMMENCEMENT OF ANY FABRICATION, COPYRIGHT OF THE COMMENCEMENT OF ANY FABRICATION, COPYRIGHT OF THE CONTENTS OF THIS DRAWING IS RETIMED BY ARCHITECTS (CANOPUS GROUP PTY, LTD.) WRITTEN CONSENT MUST BE OBTAINED PRIOR TO ANY USE OR REPRODUCTION OF THIS DRAWING IN FULL OR IN PART. ®

DRAWING TITLE

Shadow Diagram At 3pm

DRAWN	CHECKED	DATE
Author	Checker	22 SEP 2015
SCALE		PROJECT NUMBER
	1:100	140968



DESIGN OBJECTIVES:

TO INCREASE RESIDENTIAL DENSITIES AND PROVIDE A RANGE OF HOUSING TYPES AROUND ACTIVITY CENTRES AND ALONG MAIN ROADS.

TO ENCOURAGE DEVELOPMENT THAT IS CONTEMPORARY IN DESIGN THAT INCLUDES AN ARTICULATED BUILT FORM AND INCORPORATES A RANGE OF VISUALLY INTERESTING BUILDING MATERIALS AND FAÇADE TREATMENTS.

TO SUPPORT THREE STOREY, 'APARTMENT STYLE', DEVELOPMENTS WITHIN THE MAIN ROAD SUBPRECINCT AND IN SUB-PRECINCT A, WHERE THE MINIMUM LAND SIZE CAN BE ACHIEVED.

TO ENSURE NEW DEVELOPMENT IS WELL ARTICULATED AND UPPER STOREY ELEMENTS ARE NOT UNDULY BULKY OR VISUALLY INTRUSIVE, TAKING INTO ACCOUNT THE PREFERRED NEIGHBOURHOOD CHARACTER.

TO ENSURE THE DESIGN AND SITING OF DWELLINGS HAVE REGARD TO THE FUTURE DEVELOPMENT OPPORTUNITIES AND FUTURE AMENITY OF ADJOINING PROPERTIES.

TO ENSURE DEVELOPMENTS OF TWO OR MORE STOREYS ARE SUFFICIENTLY STEPPED DOWN AT THE PERIMETER OF THE MAIN ROAD SUB-PRECINCT TO PROVIDE AN APPROPRIATE AND ATTRACTIVE INTERFACE TO SUB-PRECINCT A OR B, OR OTHER ADJOINING

HIGHER DEVELOPMENTS ON THE PERIMETER OF SUB-PRECINCT A MUST BE DESIGNED SO THAT THE HEIGHT AND FORM ARE SUFFICIENTLY STEPPED DOWN, SO THAT THE SCALE AND FORM COMPLEMENT THE INTERFACE OF SUB-PRECINCT B OR OTHER DEVELOPMENT. ADJOINING ZONE.


TO ENSURE OVERLOOKING INTO ADJOINING PROPERTIES IS MINIMISED.


TO ENSURE THE DESIGN OF BASEMENT AND UNDERCROFT CAR PARKS COMPLEMENT THE DESIGN OF THE BUILDING, ELIMINATES UNSIGHTLY PROJECTIONS OF BASEMENT WALLS ABOVE NATURAL GROUND LEVEL AND ARE SITED TO ALLOW FOR EFFECTIVE SCREEN PLANTING.

TO ENCOURAGE LANDSCAPING AROUND BUILDINGS TO ENHANCE SEPARATION BETWEEN BUILDINGS AND SOFTEN BUILT FORM

DESIGN RESPONSE:

- 1. THE SITE AREA COVERED BY BUILDING IS APPROXIMATELY 58.7% WITH A PERMEABILITY AREA OF APPROXIMATELY ~28%.
- 2. VISUAL INTEREST HAS BEEN PROVIDED THROUGH ARTICULATION, GLAZING AND VARIATION IN MATERIALS AND TEXTURES.
- 3. THERE ARE NO BUILDINGS ON BOUNDARIES THEREFORE CREATING SPACING BETWEEN DEVELOPMENTS.
- 4. THE APARTMENT BUILDING IS STEPPED DOWN AT THE REAR OF THE SITE TO PROVIDE A TRANSITION TO THE SCALE OF THE ADJOINING RESIDENTIAL AREA.
- 5. THE BUILDING HAS BEEN INTEGRATED TO SIT WELL WITHIN THE SLOPE OF THE LAND BY WAY OF EXCAVATION APPROXIMATLY 2m TO THE SOUTH WESTERN CORNER OF THE SITE.
- 7. THE UPPER LEVELS OF THE APARTMENT PROVIDES ADEQUATE ARTICULATION TO REDUCE THE APPEARANCE OF VISUAL BULK AND MINIMISE CONTINUOUS SHEER WALL PRESENTATION.
- 8. THERE IS SUFFICIENT ARCHITECTURAL INTEREST TO THE UPPER LEVEL OF THE THREE STOREY APARTMENT TO REDUCE THE APPEARANCE OF VISUAL BULK AND MINIMISE CONTINUOUS SHEER WALL PRESENTATION.
- 9. DESIGN FEATURES SUCH AS THE ENTRANCE HAVE BEEN INTEGRATED WITH THE OVERALL DESIGN OF THE BUILDING AND ARE NOT IMPOSING. IN ADDITION THE FEATURE GLASS CURTAIN WALL ALLOWS FOR NATURAL LIGHT TO ENTER INTO THE HALLWAY AT ALL LEVELS.
- 10. THE PROPOSED APARTMENT BUILDING HAS BEEN DESIGNED AND SITED TO ADDRESS SLOPE CONSTRAINTS, INCLUDING MINIMISING VIEWS OF BASEMENT PROJECTIONS AND/OR MINIMISING THE HEIGHT OF FINISHED FLOOR LEVELS AND PROVIDIN APPROPRIATE RETAINING WALL PRESENTATION. FURTHERMORE, IT MINIMISES OVERLOOKING AND AVOIDS THE EXCESSIVE APPLICATION OF SCREEN DEVICES.
- 11. THE PROPOSED DESIGN HAS INTEGRATED ACCESSABLE DESIGN (ENTRY, RAMPS, HALLWAYS AND ACCESSING LEVELS) IN COMPLAINCE WITH NECESSERY AUSTRALIAN STANDARDS THROUGHOUT.
- 12. WHERE NECCESSERILY SUFFICIENT LANDSCAPING AND SCREENING HAS BEEN PROVIDED IN ACCORDANCE TO DD08 LANDSCAPING GUIDELINES AS TO PROVIDE OPPORTUNITIES FOR PLANTING ALONG SIDE BOUNDARIES TO ASSIST IN BREAKING, AND SOFTEN UP THE LENGHT OF CONTINOUS BUILT FORM.
- 13. THE BASEMENT CAR PARKS ARE NOT VISUALLY OBTRUSIVE WHEN VIEWED FROM THE FRONT OF THE SITE AS IT IS FULLY SUBMERGED AS A BASEMENT CAR PARK.
- 14. CAR PARKING REQUIREMENTS HAS BEEN INTEGERATED INTO THE DESIGN OF THE APARTMENT BY ENCOURAGING THE USE OF BASEMENT PARKING HENCE ELIMINATING THE USE OF OPEN CAR PARK AND HALF BASEMENT PARKING.
- 15. THE BASEMENT CAR PARK SETBACK IS ON AVERAGE OF 4.0m FROM THE REAR BOUNDARY TO ENABLE EFFECTIVE LANDSCAPING TO BE ESTABLISHED.
- 16. THE BUILDING WALLS, INCLUDING BASEMENTS, ARE SITED A SUFFICIENT DISTANCE FROM SITE BOUNDARIES TO ENABLE THE PLANTING OF EFFECTIVE SCREEN PLANTING, INCLUDING CANOPY TREES, IN LARGER SPACES.
- 17 ALL SERVICE FOLIPMENT BUILDING SERVICES LIFT OVER-RUNS AND ROOF-MOUNTED FOLIPMENT INCLUDING SCREENING DEVICES IS INTEGRATED INTO THE BUILT FORM OR SCREENED TO MINIMISE THE AESTHETIC IMPACTS ON THE STREETSCAPE AND AVOIDS UNREASONABLE AMENITY IMPACTS ON SURROUNDING PROPERTIES AND OPEN SPACES.
- 18. ONLY ONE DOUBLE VEHICULAR CROSSOVER IS PROVIDED TO MINIMISE DISRUPTION TO STREET PLANTATION AND PEDESTRIAN MOVEMENT. THE DRIVEWAY DOES NOT INTERFERE WITH ANY STREET TREES.
- 19. EASTERN EXISTING CROSSOVER IS RETAINED AND EXTENDED TO THE SATISFACTION OF THE RELEVANT AUTHORITY. WESTERN EXISTING DRIVEWAY WILL BE REMOVED AND REPLACED WITH NEW KERB, CHANNEL AND NATURE STRIP TO MATCH EXISTING.
- 20. PROVIDE SAFE PASSAGE FOR VEHICLES AND PEDESTRIANS THE BASEMENT CAR PARK AND RAMP HAS BEEN DESIGN TO THE REQUIREMENTS OF CLAUSE 52.34 AND AUSTRALIAN STANDARD REQUIRMENTS.
- 21. AT LEAST 3 CANOPY TREES ARE PROPOSED WITHIN THE FRONT SETBACK, WHICH HAVE A SPREADING CROWN AND ARE CAPABLE OF GROWING TO A HEIGHT OF 8.0m OR MORE AT MATURITY.

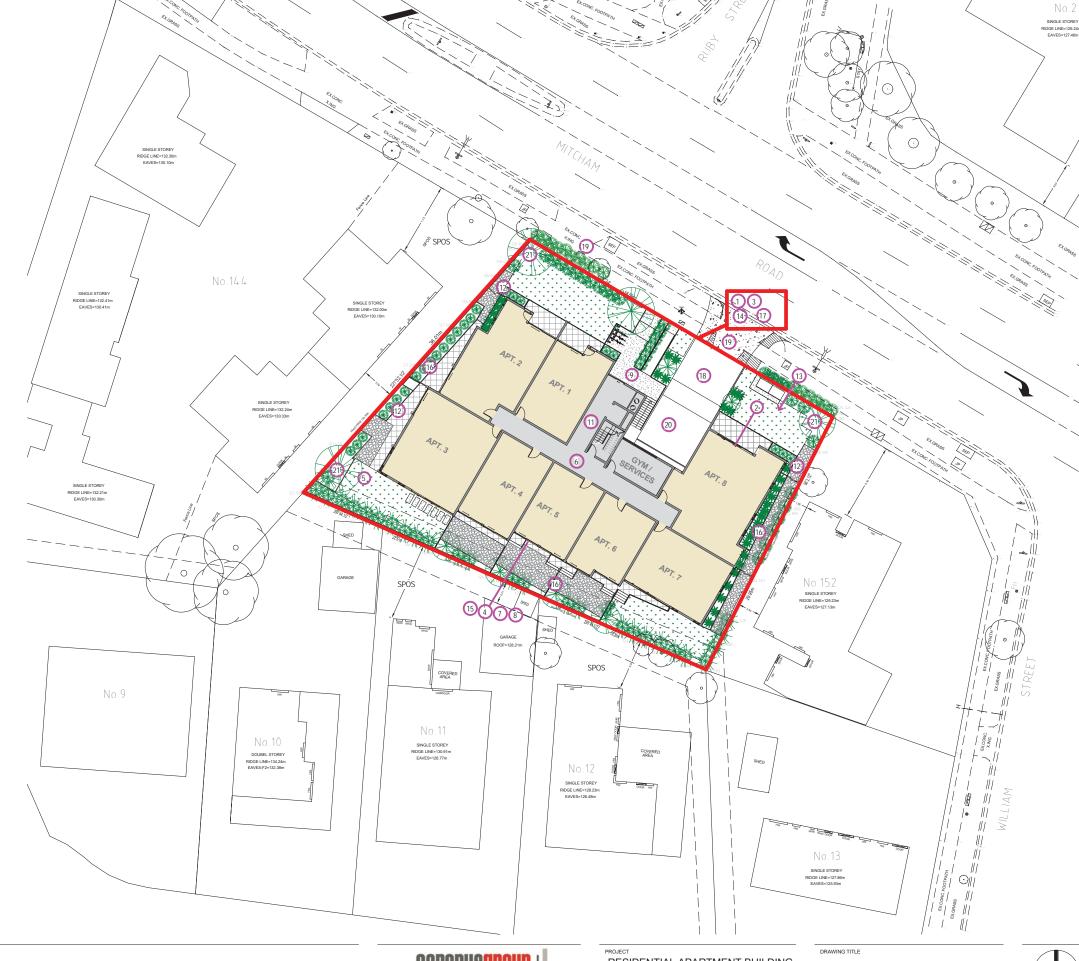

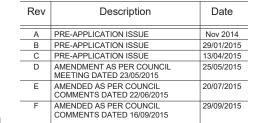



PO BOX 59 IVANHOE VIC 3079 AUSTRALIA T: +61 3 9420 9720 M: +61 4 1345 4654

info@canopus.net.au www.canopus.net.au

RESIDENTIAL APARTMENT BUILDING 148-150 MITCHAM ROAD, DONVALE BEHZAD EGHRARI

ALL WORK SHALL CONFORM TO THE SPECIFICATION AND OTHER RELEVANT DRAWINGS FIGURED DIMENSIONS TAKE PREFERENCE OVER SCALED DIMENSIONS CHECK ALL STATES OF THE ST

Design Response Plan

N.E. S.R. 22 SEP 2015 SCALE 1:200 140968



REV



- List of Public Primary School nearby
 - 1. Donvale Primary School
 - 2. Mitcham Primary School
 - 3. Whitehorse Primary School
 - 4. Donbum Primary School
 - 5. Blackburn Primary School
 - 6. Old Orchard Primary School
 - 7. Beverley Hills Primary School
 - 8. Doncaster Gardens Primary School
 - 9. Antonio Park Primary School
- List of Catholic Primary School nearby
 - 1. St Philip's Catholic Primary School
 - 2. St John's Catholic Primary School
 - 3. St Ss Peter & Paul's Catholic Primary School
- List of Public Secondary Schoolnearby
 - 1. Croydon Community School (Donvale Primary Campus)
 - Mullauna Secondary College (Mullauna
 - Secondary College Campus)
 - East Doncaster Secondary College
 Blackburn High School
- 0 Public Transport
 - 1 Mitcham Train Station
 - Nunawading Train Station 3. Blackburn Train Station
 - Bus Route 271 Box Hill <> Ringwood via Park Orchards
 Bus Route 907 City <> Mitcham via Doncaster Road
 - 6. Bus Route 309 City <> Donvale via Reynolds Road

Shopping Centers

- 1. Tunstall Square
- 2. Devon Plaza 3. Mitcham Shops
- 4. Nunawading Shops
- 5. Bunnings Warehouse
- 6. North Blackburn Square
- 7. Donvale Local Shops


Hospitals


- 1. Mitcham Hospital
- 2 Mitcham Private Hospital
- 3. Donvale Rehabilitation Hospital



Parks, Ovals & Recreation Reserves

- 1. Koonung Park
- 2. Donvale Reserve
- 3. Donvale Sports Complex 4. Donvale aranga Reserve
- 5. Larne Reserve
- 6. Koonung Creek park 7. St. Clems Reserve
- 8. Slater Reserve
- 9. Halliday Park
- 10. Walker Park
- 11. Tunstall Park
- 12. Boronia Grove Reserve
- 13. Gray Reserve
- 14. Nicol Park
- 15. Mullum Park 16. Brunswick Park

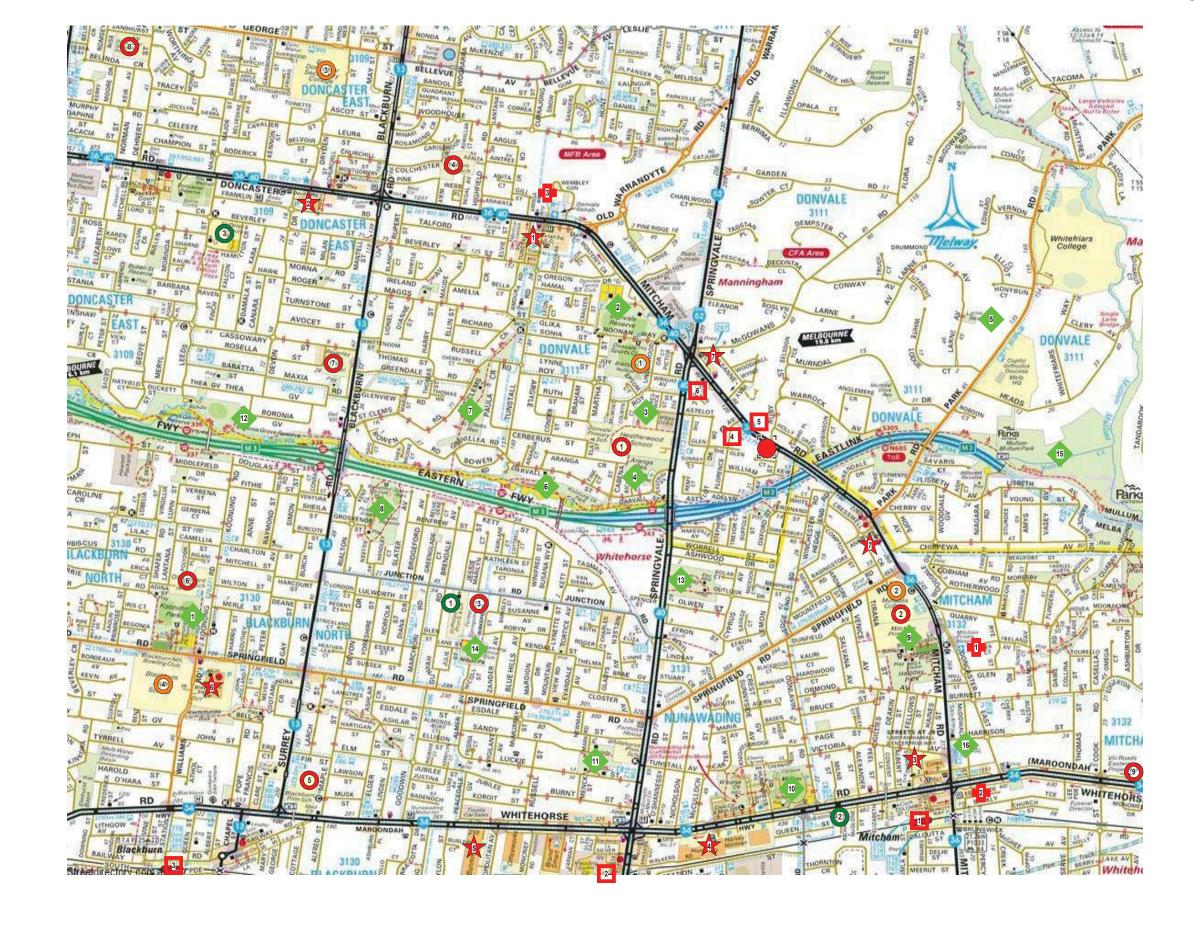

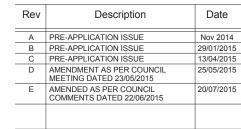



info@canopus.net.au www.canopus.net.au

RESIDENTIAL APARTMENT BUILDING 148-150 MITCHAM ROAD, DONVALE BEHZAD EGHRARI

ALL WORK SHALL CONFORM TO THE SPECIFICATION AND OTHER RELEVANT DRAWINGS FIGURED DIMENSIONS TAKE PREFERENCE OVER SCALED DIMENSIONS CHECK ALL SHAPE OF THE STATE OF THE STATE OF THE STATE OF THE STATE OF THE COMMENCEMENT OF ANY FABRICATION COPYRIGHT OF THE STATE O

Site Analysis & Locality **Description Plan**

Author Checker 20 JUL 2015 As indicated 140968





1. Unit 1/144 Mitcham Road. (View from existing driveway)



2. Unit 5/144 Mitcham Road. (View from existing driveway)



3. 144 Mitcham Road. (View from existing crossover)



4. 148-150 Mitcham Road. (View from Mitcham Road)



5. 123 Mitcham Road. (View from Mitcham Road)







7. 152 Mitcham Road. (View from Mitcham Road)




7. 150 Mitcham Road. (View from Mitcham Road)



7. 148 Mitcham Road. (View from Mitcham Road)



7. 144-146 Mitcham Road. (View from Mitcham Road)

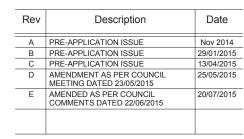



PO BOX 59 IVANHOE VIC 3079 AUSTRALIA

T: +61 3 9420 9720 M: +61 4 1345 4654

RESIDENTIAL APARTMENT BUILDING
148-150 MITCHAM ROAD, DONVALE

CONTENTS OF THIS DRAWING IS NEUTRING.
CONTENTS OF THIS DRAWING IS NEUTRING.
CANOPUS GROUP PTV, LTD, WRITTEN CONSENT MUST BE
OBTAINED PRIOR OF AM USE OR REPRODUCTION OF THIS
DRAWING IN FULL OR IN PART. @

Site Photographs & **Existing Streetscape**

BERZAD EGRRARI			
LL CONFORM TO THE SPECIFICATION AND NT DRAWINGS FIGURED DIMENSIONS TAKE	DRAWN	CHECKED	DATE
FOVER SCALED DIMENSIONS CHECK ALL S ON SITE. SHOP DRAWINGS SHALL BE THIS OFFICE FOR APPROVAL BEFORE THE	Author	Checker	20 JUL 2015
IT OF ANY FABRICATION. COPYRIGHT OF THE THIS DRAWING IS RETAINED BY ARCHITECTS JUP PTY. LTD.) WRITTEN CONSENT MUST BE	SCALE		PROJECT NUMBER
OR TO ANY USE OR REPRODUCTION OF THIS RAWING IN FULL OR IN PART. ©	As	indicated	140968

