## 722-724 DONCASTER ROAD

**5 STOREY APARTMENT DEVELOPMENT** 

#### CONSULTANTS DOCUMENTATION:

ARCHITECTURAL PLANS ARE TO BE READ IN CONJUNCTION WITH REPORT PREPARED BY CONSULTANTS BELOW:

- · TRAFFIC ENGINEERING ASSESSMENT & WASTE MANAGEMENT REPORT BY TRAFFIX GROUP
- · SMP REPORT BY GREEN RATE
- ARBORICULTURAL REPORT AND LANDSCAPE DRAWINGS BY JOHN PATRICK LANDSCAPE ARCHITECTS PTY LTD

#### DRAWINGS LIST:

Sheet Number	Sheet Name	Current Revision
TP00	COVER	(B)
TP01	3D VIEWS - SHEET 1	\B <b>→</b>
TP02	3D VIEWS - SHEET 2	B ?
TP03	SITE PLAN (CONTEXT)	(B (
TP04	EXISTING & DEMOLITION PLAN	₫B Ś
TP05	EXISTING AND DEMOLITION ELEVATION	(B)
TP06	PROPOSED SITE PLAN	(B)
TP07	BASEMENT PLAN	B
TP08	GROUND FLOOR PLAN	}B ₹
TP09	LEVEL 1 PLAN	B
TP10	LEVEL 2 PLAN	₫B §
TP11	LEVEL 3 PLAN	(B)
TP12	ROOF PLAN	B 2
TP13	NORTH & EAST ELEVATIONS	}B ₹
TP14	SOUTH & WEST ELEVATIONS	<b>}</b> B <b>₹</b>
TP15	HERITAGE & INTERNAL ELEVATIONS	<b>₿</b>
TP16	HERITAGE & INTERNAL ELEVATIONS	(B)
TP17	SECTIONS	(B)
TP18	SHADOW DIAGRAMS - SHEET 1	B ?
TP19	SHADOW DIAGRAMS - SHEET 2	}B ₹
TP20	STORAGE AREA CALCULATION	<b>₿</b> \$
TP21	3D VIEWS	(B)
TP22	ADDITIONAL OVERLOOKING STUDIES	В

# This has been made available for the sole purpose of the planning process as set out in the *Planning and Environment Act* 1987. It must not be used for any other purpose or breach any copyright. Any dissemination, distribution or copying of this document is strictly prohibited.

#### DEVELOPMENT SUMMARY

TOTAL SITE AREA	1,979.5 m <sup>2</sup>		
SITE COVERAGE	1,195.0 m <sup>2</sup> (60%)	MAX. 60%	
GRZ AREA	139.5 m²		
PERMEABILITY: 635n	r² (32.1%)		
Na	ime	Area	

Name	Area
BASEMENT (INTERNALLY)	1,006.0 m <sup>2</sup>
GROUND LEVEL (EXTERNAL)	556.5 m²
GROUND LEVEL CARPARK (INTERNAL)	443.0 m²
LEVEL 1 (EXTERNAL)	974.0 m²
LEVEL 2 (EXTERNAL)	864.0 m²
LEVEL 3 (EXTERNAL)	563.0 m²
COMMUNAL OPEN SPACE	143.0 m²
	4 549 0 m <sup>2</sup>

#### PERCENTAGE OF UPPER FLOOR AREA OVER LOWER FLOOR AREA

LEVEL 3 OVER LEVEL 2 - 65.2% LEVEL 2 OVER LEVEL 1 - 88.7% LEVEL 1 OVER GROUND LEVEL - 97.2% GROUND LEVEL OVER BASEMENT - 99.5%

CANOPY COVER AREA: 436.9112 (22.1%) TOTAL DEEP PLANTING AREA (551.511) (28.0%)

G01	$\top$	3BR	98.0 m <sup>2</sup>	POS G01	127.5 m
G02		2BR	65.5 m²	POS G02	54.0 m²
G03		2BR	65.0 m <sup>2</sup>	POS G03	104.5 m
G04 (A)	A	1BR	58.5 m²	POS G04	39.0 m²
G05 (A)	В	1BR	63.5 m²	POS G05	30.5 m²
G06		1BR	53.0 m²	POS G06	21.0 m*
G07	$\top$	2BR	70.0 m <sup>2</sup>	POS G07	21.0 m <sup>2</sup>
101	$\top$	2BR	80.0 m <sup>2</sup>	POS 101	21.5 m <sup>2</sup>
102 (A)	A	STUDIO	52.0 m <sup>2</sup>	BALCONY 102	8.0 m <sup>2</sup>
	100	1		BALCONY 103	9.0 m <sup>2</sup>
103 (A)	В	2BR	88.5 m <sup>2</sup>	BALCONY 103	3.0 m <sup>2</sup>
104		2BR	77.5 m²	BALCONY 104	12.0 m²
105	$\top$	1BR	48.0 m <sup>2</sup>	BALCONY 105	8.5 m <sup>2</sup>
106		2BR	68.0 m <sup>2</sup>	BALCONY 106	9.0 m <sup>2</sup>
107		1BR	52.0 m <sup>2</sup>	BALCONY 107	8.0 m <sup>2</sup>
108 (A)	A	1BR	54.5 m <sup>2</sup>	BALCONY 108	8.5 m <sup>2</sup>
109 (A)	(A)	2BR	93.5 m²	BALCONY 109	10.5 m <sup>2</sup>
	-			POS 109	14,5 m <sup>2</sup>
110 (A)	В	2BR	94.0 m <sup>2</sup>	BALCONY 110	7.0 m <sup>2</sup>
				POS 110	33.0 m²
111 (A)	Α	2BR	85.0 m <sup>2</sup>	POS 111	45,5 m²
201	Т	2BR	84.0 m <sup>2</sup>	BALCONY 111	21.5 m <sup>2</sup>
				BALCONY 201	10.0 m <sup>2</sup>
202 (A)	В	1BR	65.5 m <sup>2</sup>	BALCONY 202	10.0 m²
203	Т	1BR	68.5 m²	BALCONY 203	11.0 m²
204 (A)	В	2BR	93.5 m²	BALCONY 204	19.5 m²
205 (A)	Α	1BR	51.5 m <sup>2</sup>	BALCONY 205	8.5 m <sup>2</sup>
206	Т	3BR	91.5 m <sup>2</sup>	BALCONY 206	20.5 m <sup>2</sup>
207	Т	1BR	51.0 m <sup>2</sup>	BALCONY 207	8.0 m <sup>2</sup>
208	Т	2BR	76.0 m <sup>2</sup>	BALCONY 208	15.0 m <sup>2</sup>
209 (A)	Α	2BR	86.0 m²	BALCONY 209	9.0 m²
210	1	2BR	85.5 m <sup>2</sup>	BALCONY 210	16.0 m <sup>2</sup>
301		2BR	75.5 m <sup>2</sup>	BALCONY 301	15.0 m <sup>2</sup>
302 (A)	Α	2BR	82.5 m²	BALCONY 302	13.5 m²
303 (A)	A	2BR	89.5 m <sup>2</sup>	BALCONY 303	27.5 m²
304 (A)	Α	3BR	101.0 m²	BALCONY 304	18.0 m <sup>2</sup>
305 (A)	В	2BR	78.0 m²	BALCONY 305	9.0 m <sup>2</sup>
306 (A)	В	2BR	77.5 m²	BALCONY 305	6.0 m <sup>2</sup>
				BALCONY 306	8.5 m²
(A) ACCE	SSIBL	E UNIT		BALCONY 306	3.0 m <sup>2</sup>

TOTAL NO. OF UNITS: 34 (INCLUDING EXISTING HOUSE) TOTAL ACCESSIBLE UNITS: 17 (50%)

## E3-12\* - ACCESSIBILITY FOR APARTMENT DEVELOPMENTS OBJECTIVE (BATHROOM DESIGN OPTION)

STUDIO: I	EXTERNAL STORA
1 BEDROOM APT: 10	4.9m <sup>2</sup> : 2
2 BEDROOM APT: 20	5.7m <sup>2</sup> : 3
3 BEDROOM APT: 3	6.0m²: 20

TOTAL NO. OF STORAGE: 25

#### BASEMENT PARKING

CAR PARK: 27 BIKE PARK: 12

GROUND FLOOR PARKING

CAR PARK: 13

#### TOTAL NO. OF CAR PARK: 40

#### VENTILATION CALCULATION:

NO. OF APARTMENT WITH EFFECTIVE CROSS VENTILATION: 15 (44%)

NO. OF APT REQUIRES FAN: 19

## **TOWN PLANNING**



DO NOT SCALE DRAWING - REFER ONLY TO WRITTEN Rev Date Chied DIMENSIONS
Contractor must verify all dimensions and levels on site prior to the commencement of any works, ordering & or manufacture of any materials. Notify MT Architects of any discorpancies. Drawings to be read in conjunction with current specification. Drawings 2 2/225 Martyn Tribe Architects

**ADVERTISED: PLN24/0477** 

ADVERTISE 29 August 2025

31 Whyte St, Brighton VIC 3186 e. mtribe@martyntribearchitects.com.au m. 0407544808 A.B.N. 83 083 170 549

RESPONSE TO RFI RESPONSE TO RFI 2

				•
APARTMENT DEVELOPMENT	COVER	TP00	2342	
Project	Drawing	Drawing No.	Project No.	
722-724 DONCASTER ROAD, DONCASTER		JL Drawn by	12.12.2024 Issued Date	
Tugeut Auduress		Scale @ A1	B Status/Revision	



NORTH VIEW



**EAST VIEW** 



FRONT STREET VIEW - NORTH EAST



SOUTH EAST VIEW



DO NOT SCALE DRAWING - REFER ONLY TO WRITTEN DIMENSIONS Contractor must verify all dimensions and levels on site prior to the commencement of any works, ordering 8 or manufacture of any materials. Notify MT Architects of any discrepancies. Drawings to be reset in conjunction with current specification. Drawings 20 2025 Martyn Tribe Architects

31 Whyte St, Brighton VIC 3186 e. mtribe@martyntribearchitects.com.au m. 0407544808 A.B.N. 83 083 170 549

APARTMENT DEVELOPMENT	3D VIEWS - SHEET 1	TP01	2342
Project	Drawing	Drawing No.	Project No.
722-724 DONCASTER ROAD, DONCASTER	JL	12.12.2024	
Project Address		Drawn by	Issued Date
		0	B





SOUTH VIEW



FRONT VIEW TO HERITAGE HOUSE



FRONT STREET VIEW - NORTH WEST



FRONT STREET VIEW - ACROSS DONCASTER ROAD



FRONT STREET VIEW - ACROSS DONCASTER ROAD



31 Whyte St, Brighton VIC 3186 e. mtribe@martyntribearchitects.com.au m. 0407544808 A.B.N. 83 083 170 549

APARTMENT DEVELOPMENT	3D VIEWS - SHEET 2	TP02	2342
Project	Drawing	Drawing No.	Project No.
722-724 DONCASTER ROAD, DONCAST	JL Drawn by	12.12.2024 Issued Date	
		Scale @ A1	B Status/Penision





DO NOT SCALE DRAWING - REFER ONLY TO WRITTEN
DIMENSIONS


Contractor must verify all dimensions and levels on site prior to
the commencement of any works, ordering & or manufacture
of any materials (MONG) HT Architected of any discrepancies of any discrepancies.
Drawings to be read in conjunction with current specification.

31 Whyte St, Brighton VIC 3186
e. mtribe@martyntribearchitects.com.au m. 0407544808
A.B.N. 83 083 170 549

RESPONSE TO RFI RESPONSE TO RFI 2


APARTMENT DEVELOPMENT	SITE PLAN (CONTEXT)	TP03	2342	
Project	Drawing	Drawing No.	Project No.	
722-724 DONCASTER ROAD, DONCASTER Polect Address			12.12.2024 Issued Date	
		1 : 500 Scale @ A1	B Status/Revision	



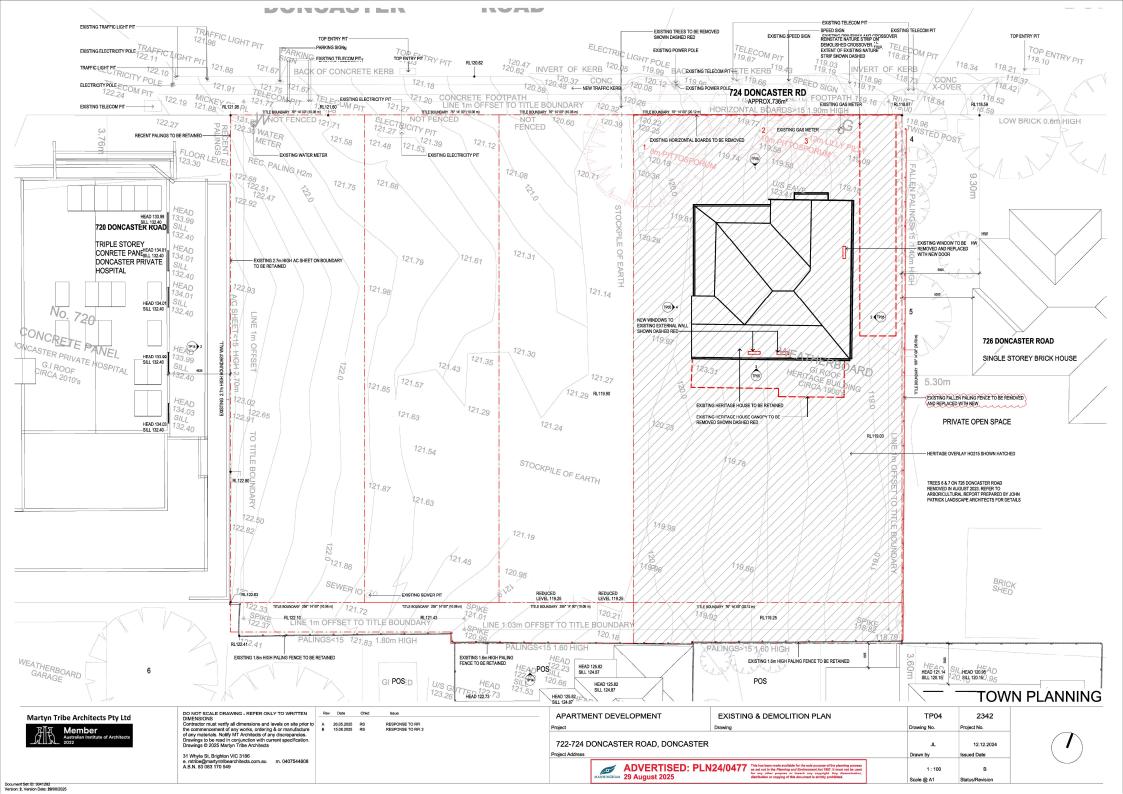





1 HERITAGE HOUSE - NORTH ELEVATION

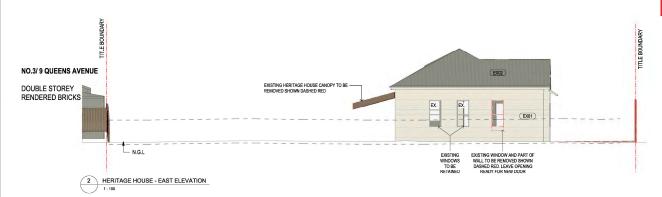




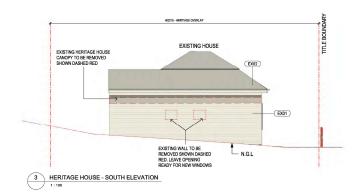


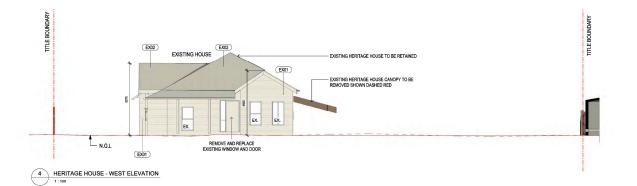



## **TOWN PLANNING**


					. •
Martyn Tribe Architects Pty Ltd  Member  Autralian Institute of Architects 2022	DO NOT SCALE DRAWING - REFER ONLY TO WRITTEN DIMENSIONS  MENSIONS  In dimensions and levels on site prior to the common and levels on site prior to the common center of any words. Ordering & or manufacture of any materials. Notify MT Architects of any adsrepancies. Drawings to be read in conjunction uncurrent specification. Drawings 2025 Martyn Tife Architects  31 Whyles St. (Enjohn VIC 3186 e. mitrise@martyntifibeanchitects.com.au m. 0.407544808 A.B.N. 83 083 170 549	TO A 26.65.2025 RS RESPONSE TO RFI B 15.68.2025 RS RESPONSE TO RFI 2	APARTMENT DEVELOPMENT Project 722-724 DONCASTER ROAD, DONCASTER Project Address	TP05 Drawing No.  JL Drawn by  1:100 Scale @ A1	Project No.  14.05.2025 Issued Date  B Status/Revision
Version: 2, Version Date: 28/08/2025					

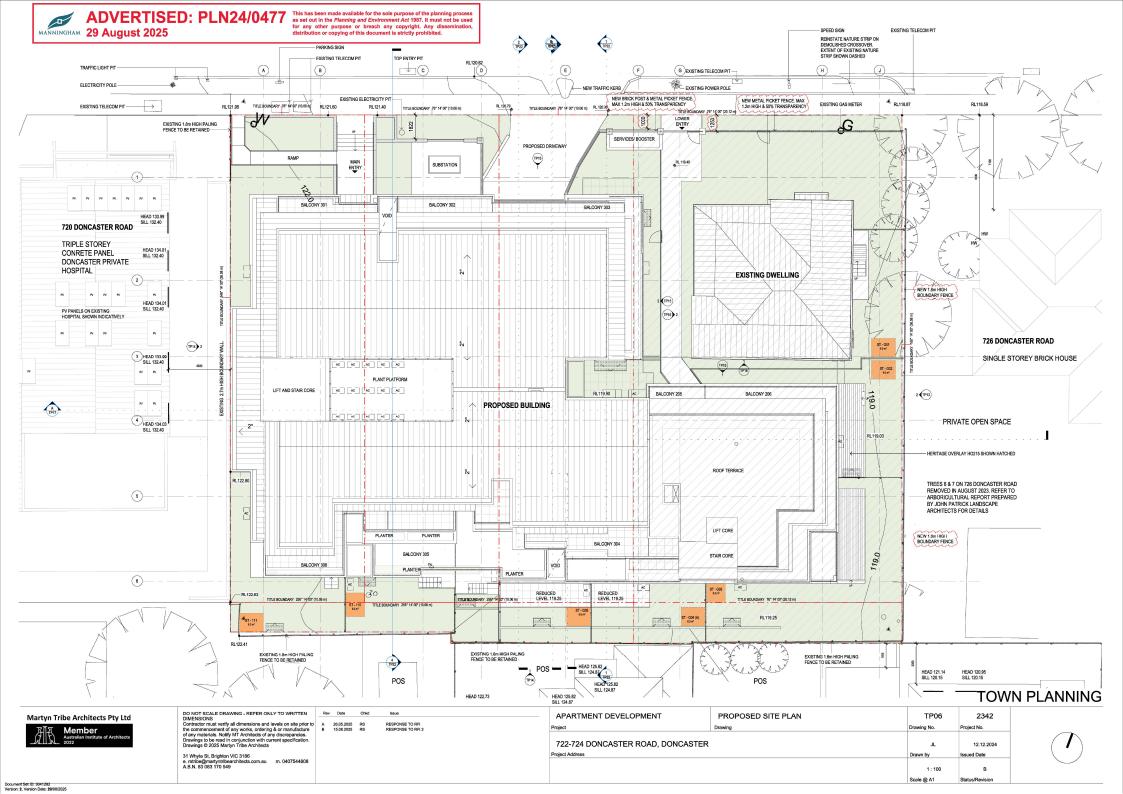


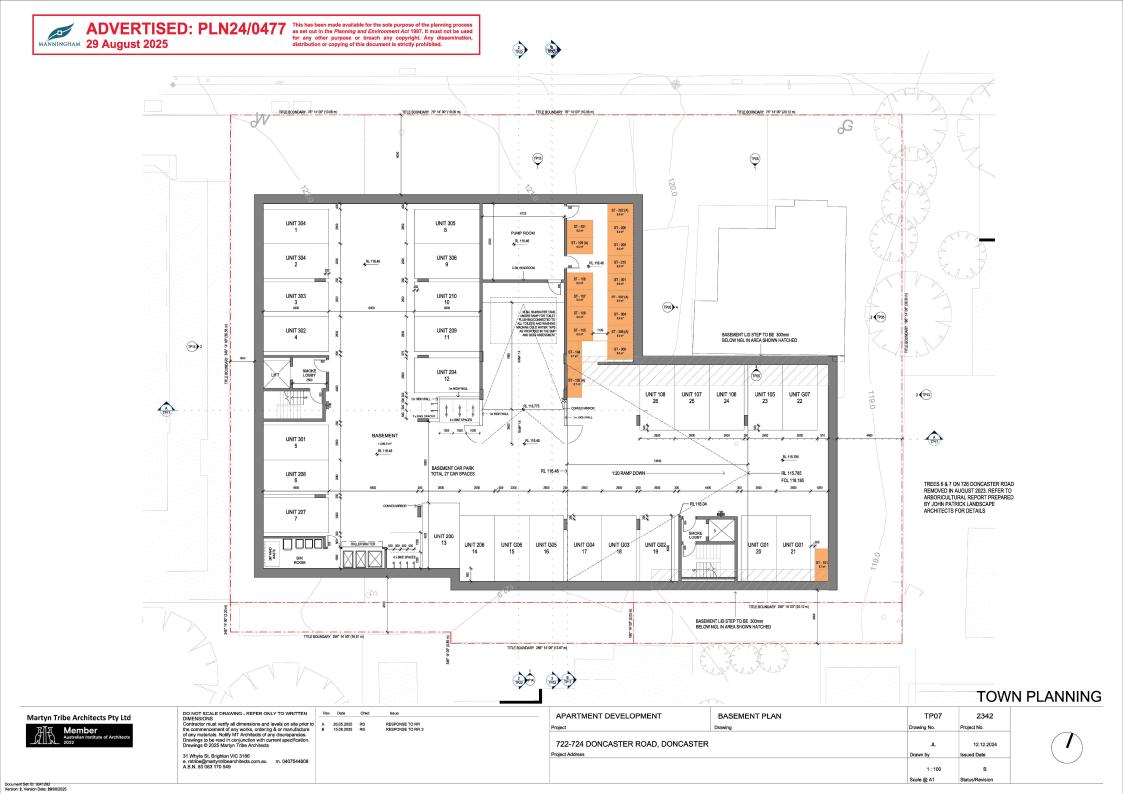


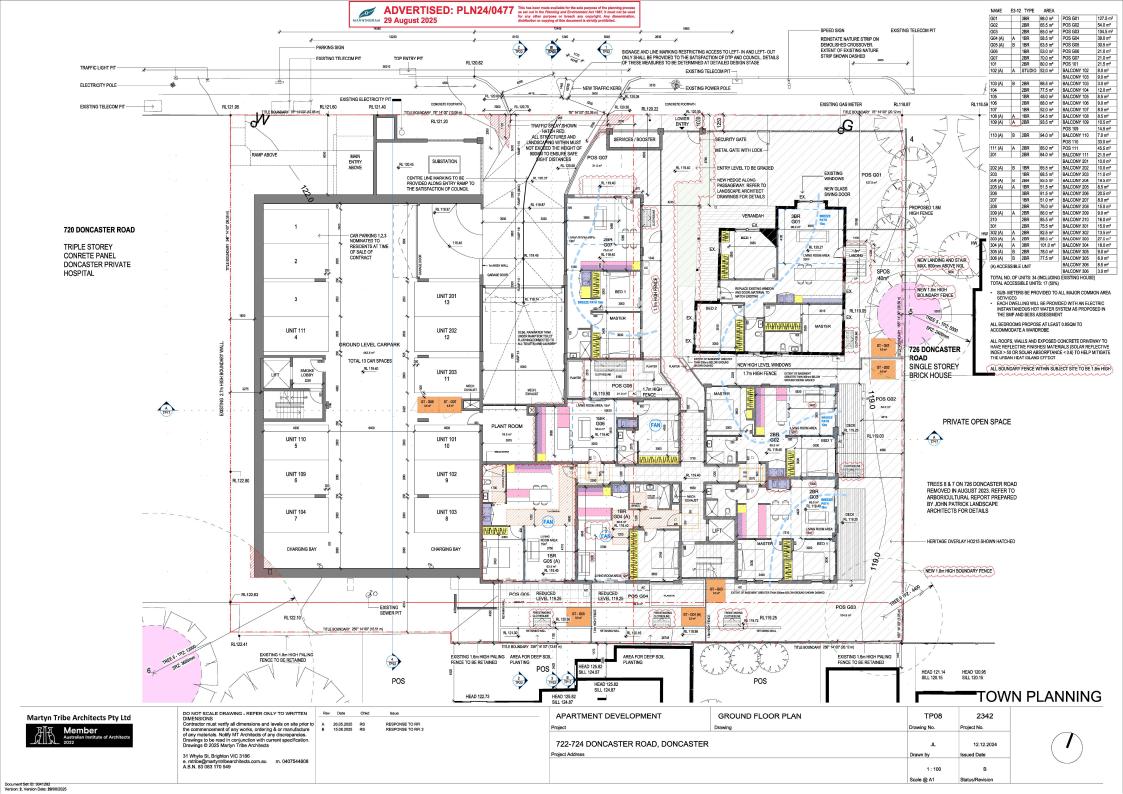

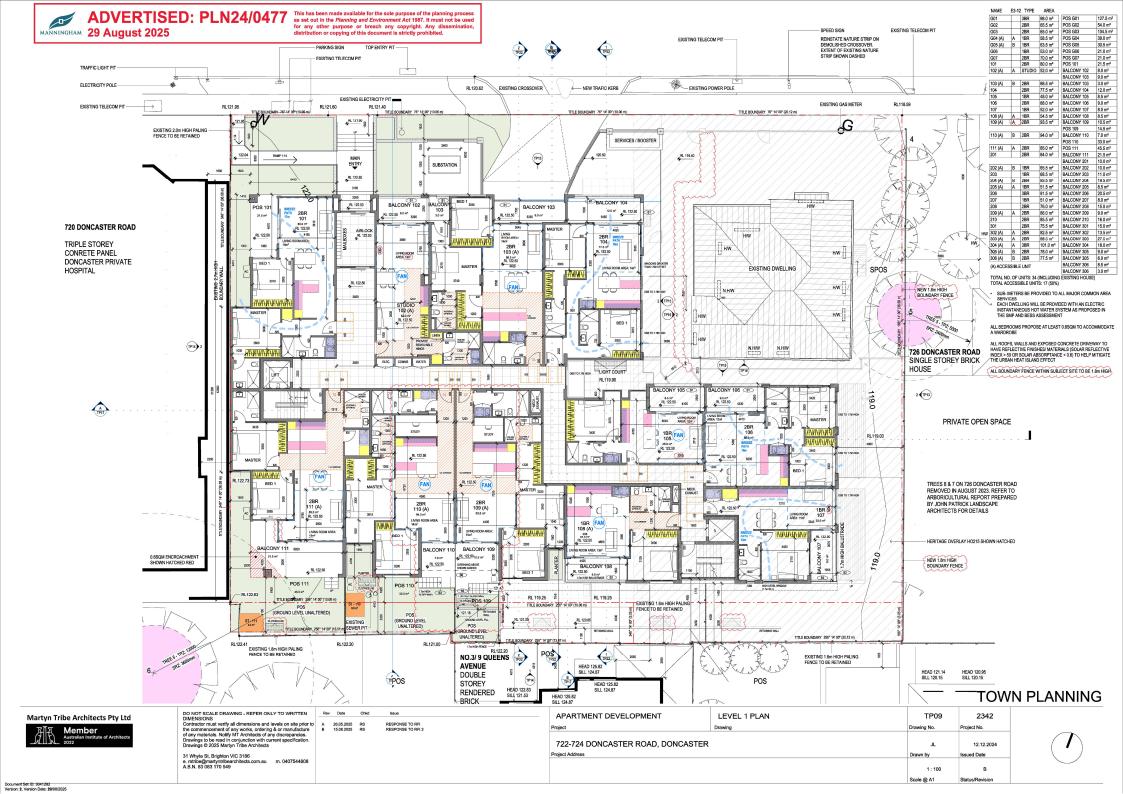

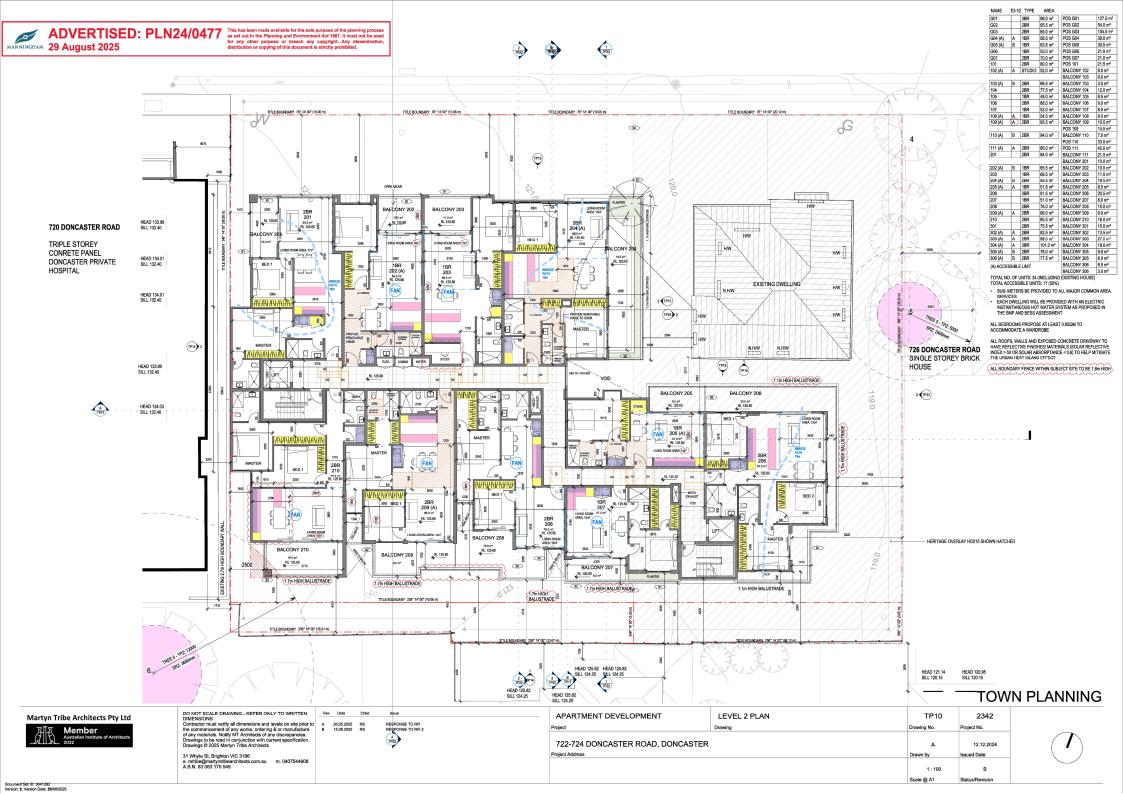

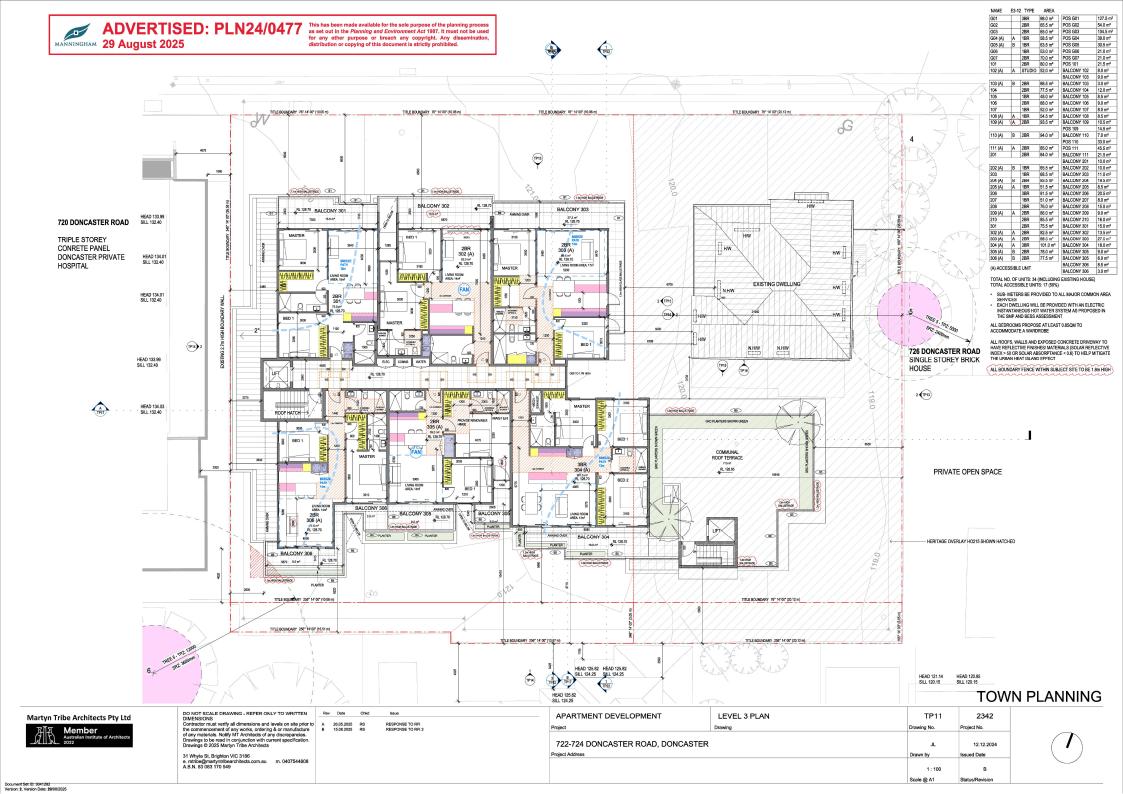


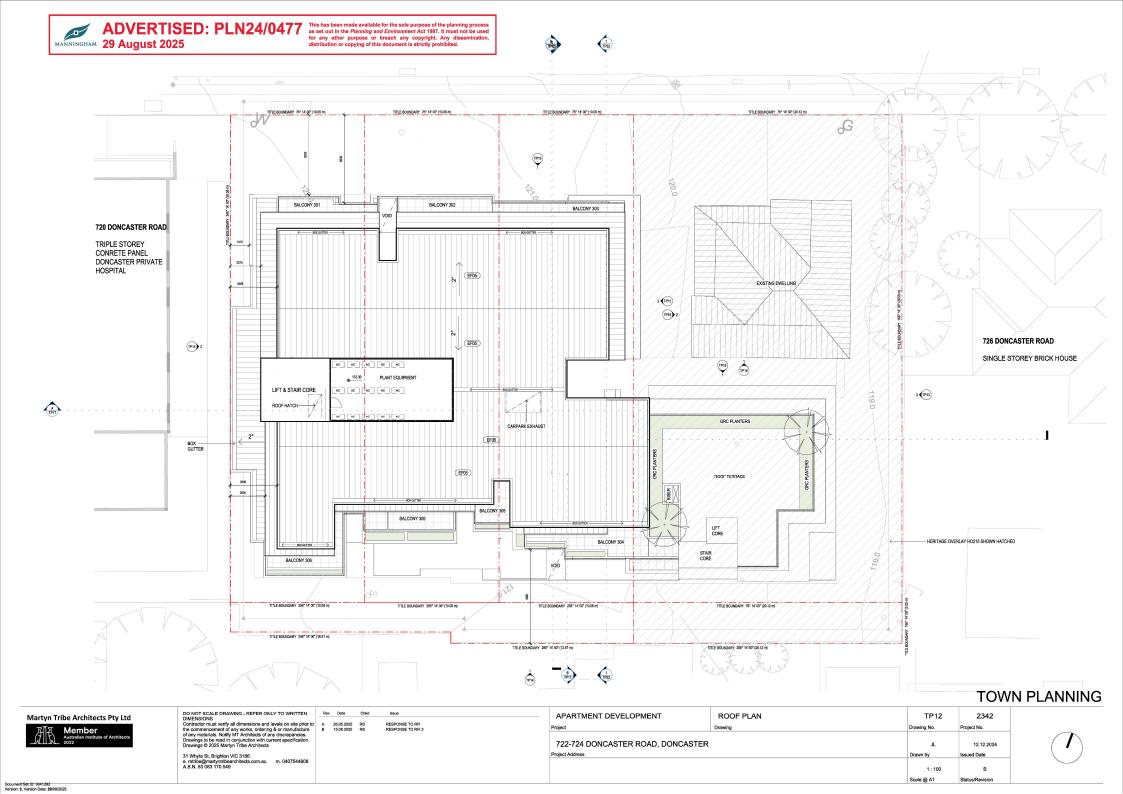







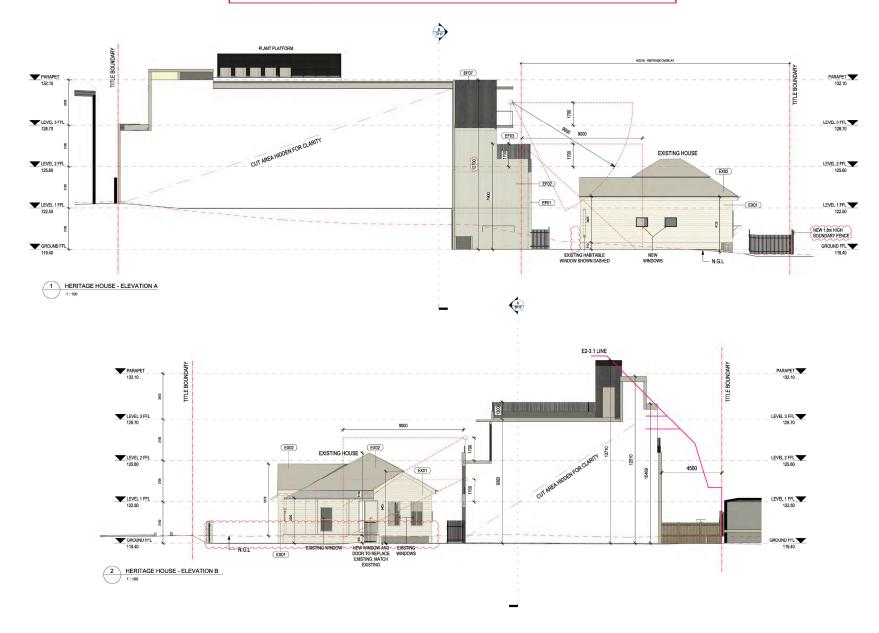






DO NOT SCALE DRAWING - REFER ONI DIMENSIONS	Y TO WRITTEN
Contractor must verify all dimensions and in the commencement of any works, ordering of any materials. Notify MT Architects of an Drawings to be read in conjunction with our Drawings © 2025 Martyn Tribe Architects	& or manufacture ny discrepancies.
31 Whyte St, Brighton VIC 3186 e. mtribe@martyntribearchitects.com.au A.B.N. 83 083 170 549	m. 0407544808


Rov	Date	Chkd	Issue
A B	26.05.2025 15.08.2025	RS RS	RESPONSE TO RFI RESPONSE TO RFI 2


APARTMENT DEVELOPMENT	HERITAGE & INTERNAL ELEVATIONS	TP16	2342
Project	Drawing	Drawing No.	Project No.
722-724 DONCASTER ROAD, DONCASTER Project Address		JL Drawn by	12.12.2024 Issued Date
		1:100 Scale @ 41	B Status/Davision

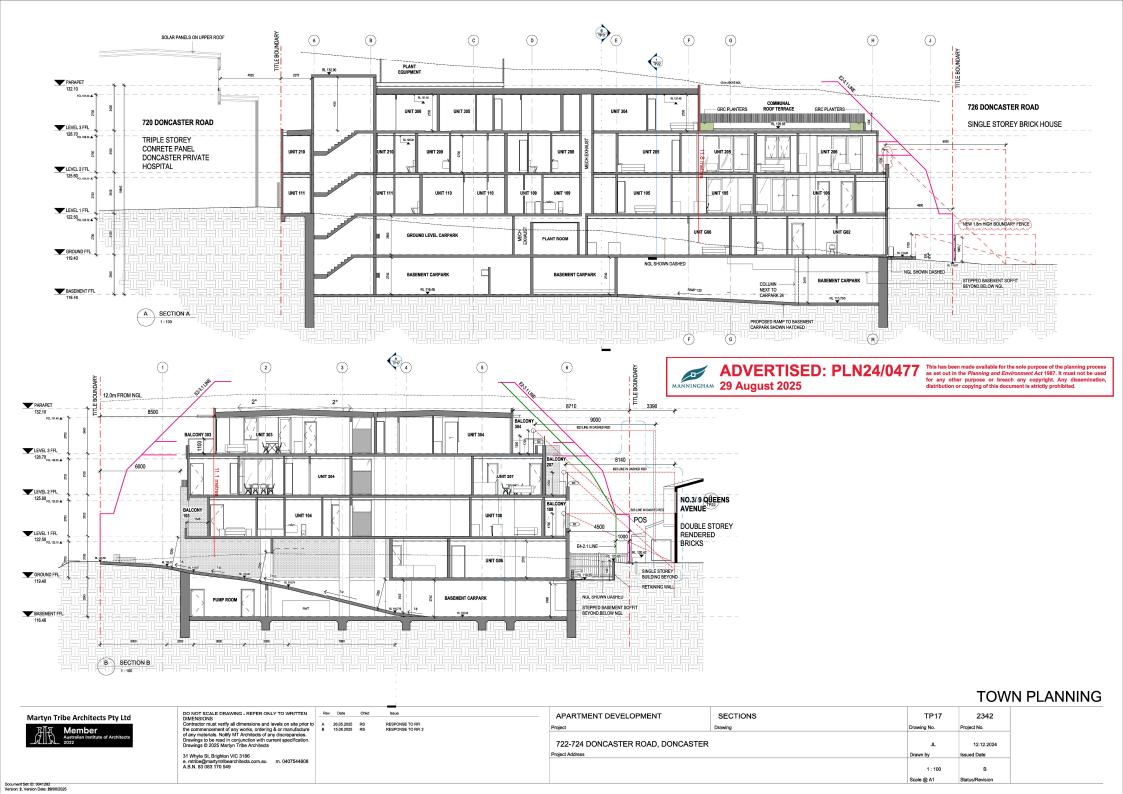

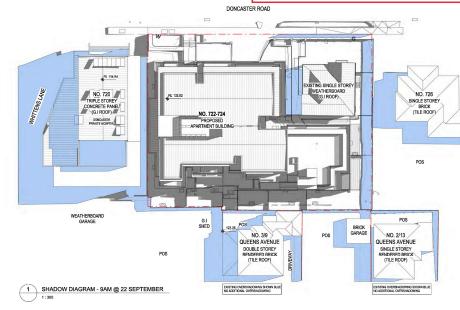

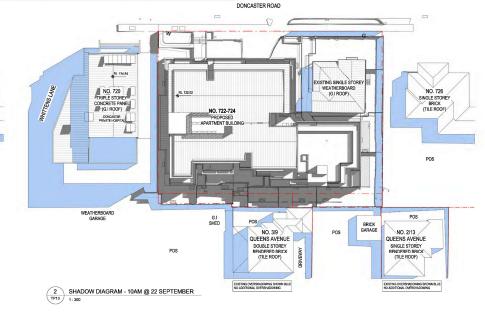

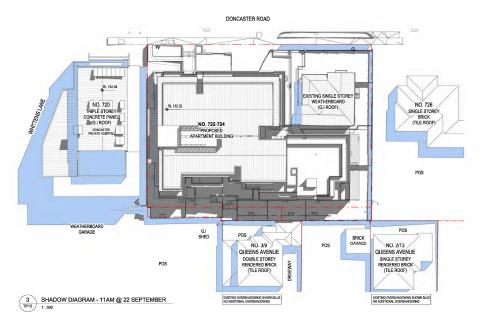

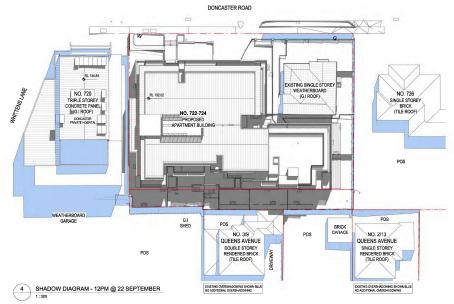



DO NOT SCALE DRAWING - REFER ONLY TO WRITTEN DIMENSIONS Contractor must verify all dimensions and levels on site prior to the commencement of any works, ordering & or manufacture of any materials. Notify MT Architects of any discrepancies. Drawings to be read in conjunction with current specification. Drawings (2025 Marryin Tinbe Architects)


31 Whyte St, Brighton VIC 3186 e. mtribe@martyntribearchitects.com.au m. 0407544808 A.B.N. 83 083 170 549 
 Rev
 Date
 Chkd
 Issue


 A
 26.05.2025
 RS
 RESPONSE TO RFI


 B
 15.08.2025
 RS
 RESPONSE TO RFI

APARTMENT DEVELOPMENT	SHADOW DIAGRAMS - SHEET 1	TP18	2342	
Project	Drawing	Drawing No.	Project No.	
722-724 DONCASTER ROAD, DONCASTER Project Address		JL Drawn by	12.12.2024 Issued Date	
		1:300 Scale @ A1	B Status/Revision	



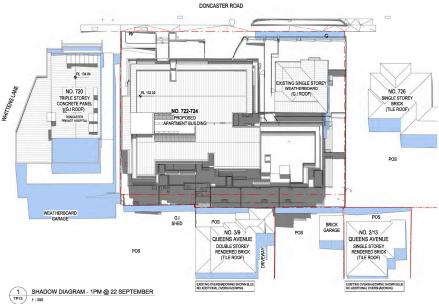

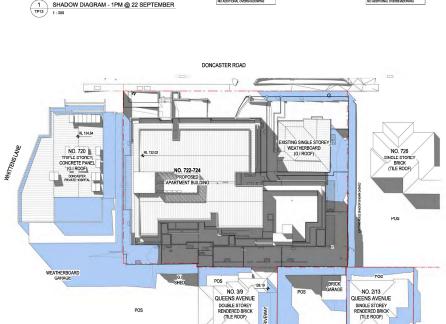

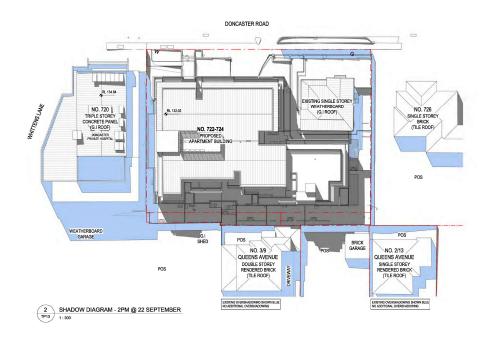



This has been made available for the sole purpose of the planning process as set out in the *Planning and Environment* Act 1987. It must not be used for any other purpose or breach any copyright. Any dissemination, distribution or copying of this document is strictly prohibited.

## **TOWN PLANNING**



DO NOT SCALE DRAWING - REFER ONLY TO WRITTEN DIMENSIONS

3 SHADOW DIAGRAM - 3PM @ 22 SEPTEMBER

DIMENSIONS
Contractor must verify all dimensions and levels on site prior to the commencement of any works, ordering & or manufacture of any materials. Notify MT Architects of any discrepancies. Drawings to be read in conjunction with current specification. Drawings & Ozzo Martyn Tribe Architects

31 Whyte St, Brighton VIC 3186
e. mtribe@martyntribearchitects.com.au m. 0407544808
A.B.N. 83 083 170 549

Rev Date A 26.05.2025 B 15.08.2025 RESPONSE TO RFI RESPONSE TO RFI 2

EXISTING OVERSHADOWING SHOWN BLUE NO ADDITIONAL OVERSHADOWING

				•
APARTMENT DEVELOPMENT	SHADOW DIAGRAMS - SHEET 2	TP19	2342	
Project	Drawing	Drawing No.	Project No.	
722-724 DONCASTER ROAD, DONCASTER		JL Drawn by	12.12.2024 Issued Date	
		1 : 300 Scale @ A1	B Status/Revision	



#### **GROUND LEVEL**

G01 - 3BR		
STORAGE TYPE	VOLUME	
EXTERNAL	6.05 m <sup>3</sup>	
FULL HEIGHT	10.80 m³	
OVERHEAD	1.28 m³	
UNDERBENCH	2.73 m <sup>3</sup>	
TOTAL	20.85 m <sup>3</sup>	
WITHIN DWELLING STORAGE	14.30 m <sup>3</sup>	

G02 - 2BR		
STORAGE TYPE	VOLUME	
EXTERNAL	6.05 m <sup>3</sup>	
FULL HEIGHT	6.76 m <sup>3</sup>	
OVERHEAD	1.33 m <sup>3</sup>	
UNDERBENCH	2.47 m <sup>3</sup>	
TOTAL	16.61 m <sup>3</sup>	
WITHIN DWELLING STORAGE	10.56 m <sup>3</sup>	

G03 - 2BR			
STORAGE TYPE	VOLUME		
EXTERNAL	6.05 m <sup>3</sup>		
FULL HEIGHT	5.10 m <sup>3</sup>		
OVERHEAD	1.25 m³		
UNDERBENCH	2.49 m <sup>3</sup>		
TOTAL	14.89 m³		
WITHIN DWELLING STORAGE	8.84 m <sup>3</sup>		

G04 - 1BR		
STORAGE TYPE	VOLUME	
EXTERNAL	6.05 m³	
FULL HEIGHT	6.33 m <sup>3</sup>	
OVERHEAD	1.01 m <sup>3</sup>	
UNDERBENCH	2.44 m <sup>3</sup>	
TOTAL	15.82 m³	
WITHIN DWELLING STORAGE	9.77 m <sup>3</sup>	


G05 - 1BR		
STORAGE TYPE	VOLUME	
EXTERNAL	6.05 m <sup>3</sup>	
FULL HEIGHT	3.55 m³	
OVERHEAD	1.39 m³ 🕺	
UNDERBENCH	2.38 m³	
TOTAL	13.37 m³	
WITHIN DWELLING STORAGE	7.32 m <sup>3</sup>	

G06 - 1BR		
STORAGE TYPE	VOLUME	
EXTERNAL	4.56 m <sup>3</sup>	
FULL HEIGHT	5.26 m³	
OVERHEAD	1.52 m³ 🕏	
UNDERBENCH	2.05 m³ 👌	
TOTAL	13.38 m³	
WITHIN DWELLING STORAGE	8.82 m <sup>3</sup>	

G07 - 2BR		
STORAGE TYPE	VOLUME	
EXTERNAL	4.90 m³	
FULL HEIGHT	8.06 m <sup>3</sup>	
OVERHEAD	1.53 m <sup>3</sup>	
UNDERBENCH	2.25 m <sup>3</sup>	
TOTAL	16.74 m³	
WITHIN DWELLING STORAGE	11.84 m <sup>3</sup>	

#### LEGEND:

EXTERNAL STORAGE US - LOW STORAGE (900mm HIGH) OH - OVERHEAD STORAGE (700mm HIGH)

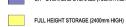

#### LEVEL 1

101 - 2BR		
STORAGE TYPE	VOLUME	
EXTERNAL	5.73 m³	
FULL HEIGHT	10.41 m <sup>3</sup>	
OVERHEAD	1.28 m³	
UNDERBENCH	1.88 m <sup>3</sup>	
TOTAL	19.30 m <sup>3</sup>	
WITHIN DWELLING STORAGE	13.58 m <sup>3</sup>	

102 (A) - STUDIO	
STORAGE TYPE	VOLUME
EXTERNAL	5.72 m³
FULL HEIGHT	5.38 m <sup>3</sup>
OVERHEAD	0.92 m <sup>3</sup>
UNDERBENCH	0.84 m <sup>3</sup>
TOTAL	12.86 m³
WITHIN DWELLING STORAGE	7.14 m <sup>3</sup>

103 (A) - 2BR		
STORAGE TYPE	VOLUME	
FULL HEIGHT	11.24 m³	
OVERHEAD	0.86 m <sup>3</sup>	
UNDERBENCH	2.62 m <sup>3</sup>	
TOTAL	14.73 m <sup>3</sup>	
	MIN. 9m <sup>3</sup>	

104 - 2BR		
STORAGE TYPE	VOLUME	
EXTERNAL	5.72 m³	
FULL HEIGHT	8.66 m <sup>3</sup>	
OVERHEAD	1.20 m <sup>3</sup>	
UNDERBENCH	2.27 m <sup>3</sup>	
TOTAL	17.86 m³	
WITHIN DWELLING STORAGE	12.14 m <sup>3</sup>	

105 - 1BR	
STORAGE TYPE	VOLUME
EXTERNAL	5.99 m³
FULL HEIGHT	5.28 m <sup>3</sup>
OVERHEAD	1.19 m <sup>3</sup>
UNDERBENCH	1.95 m <sup>3</sup>
TOTAL	14.42 m³
WITHIN DWELLING STORAGE	8.43 m <sup>3</sup>

106 (A) - 2BR	
STORAGE TYPE	VOLUME
EXTERNAL	5.99 m³
FULL HEIGHT	7.05 m <sup>3</sup>
OVERHEAD	1.09 m <sup>3</sup>
UNDERBENCH	2.09 m <sup>3</sup>
TOTAL	16.22 m³
WITHIN DWELLING STORAGE	10.23 m <sup>3</sup>

107 - 1BR	
STORAGE TYPE	VOLUME
EXTERNAL	5.99 m³
FULL HEIGHT	5.49 m <sup>3</sup>
OVERHEAD	1.50 m <sup>3</sup>
UNDERBENCH	1.98 m <sup>3</sup>
TOTAL	14.96 m <sup>3</sup>
WITHIN DWELLING STORAGE	8.97 m <sup>3</sup>

108 (A) - 1BR	
STORAGE TYPE	VOLUME
EXTERNAL	5.99 m³
FULL HEIGHT	4.18 m <sup>3</sup>
OVERHEAD	1.26 m <sup>3</sup>
UNDERBENCH	2.65 m <sup>3</sup>
TOTAL	14.08 m³ 🖇
WITHIN DWELLING STORAGE	8.09 m <sup>3</sup>

109 (A) - 2BR	
STORAGE TYPE	VOLUME
EXTERNAL	5.99 m <sup>3</sup>
FULL HEIGHT	8.25 m <sup>3</sup>
OVERHEAD	1.24 m <sup>3</sup>
UNDERBENCH	2.21 m³
TOTAL	17.69 m³
WITHIN DWELLING STORAGE	11.70 m <sup>3</sup>

110 (A) - 2BR	
STORAGE TYPE	VOLUME
EXTERNAL	6.05 m <sup>3</sup>
FULL HEIGHT	7.99 m³
OVERHEAD	1.12 m <sup>3</sup>
UNDERBENCH	2.17 m <sup>3</sup>
TOTAL	17.33 m <sup>3</sup>
WITHIN DWELLING STORAGE	11.28 m <sup>3</sup>

111 - 2BR	
STORAGE TYPE	VOLUME
EXTERNAL	6.05 m <sup>3</sup>
FULL HEIGHT	8.32 m³
OVERHEAD	1.18 m³
UNDERBENCH	2.72 m³
TOTAL	18.27 m <sup>3</sup>
WITHIN DWELLING STORAGE	12.66 m <sup>3</sup>

#### LEVEL 2

201 - 2BR	
STORAGE TYPE	VOLUME
EXTERNAL	5.99 m <sup>3</sup>
FULL HEIGHT	11.02 m³
OVERHEAD	0.97 m <sup>3</sup>
UNDERBENCH	2.19 m <sup>3</sup>
TOTAL	20.17 m <sup>3</sup>
WITHIN DWELLING STORAGE	14.18 m <sup>3</sup>

STORAGE	
210 - 2B	R
STORAGE TYPE	VOLUME
EXTERNAL	6.01 m <sup>3</sup>
FULL HEIGHT	9.23 m <sup>3</sup>
OVERHEAD	1.37 m <sup>3</sup>
UNDERBENCH	2.53 m <sup>3</sup>
	19.13 m <sup>3</sup>

	§19.13 m
WITHIN DWELLING	13.25 m

202 (A) - 1BR	
STORAGE TYPE	VOLUME
EXTERNAL	6.01 m <sup>3</sup>
FULL HEIGHT	4.69 m³
OVERHEAD	0.92 m <sup>3</sup>
UNDERBENCH	2.19 m <sup>3</sup>
TOTAL	13.80 m³
WITHIN DWELLING	$7.79 \text{ m}^3$

STORAGE

203 (A) - 1BR	
STORAGE TYPE	VOLUME
FULL HEIGHT	6.03 m <sup>3</sup>
OVERHEAD	1.14 m <sup>3</sup>
UNDERBENCH	2.59 m <sup>3</sup>
TOTAL	9.76 m <sup>3</sup>
N	VIN. 6m <sup>3</sup>

204 (A) - 2BR	
STORAGE TYPE	VOLUME
FULL HEIGHT	12.29 m³
OVERHEAD	1.16 m³
UNDERBENCH	2.71 m <sup>3</sup>
TOTAL	16.17 m <sup>3</sup>
	MIN. 9m <sup>3</sup>

205 (A) - 1BR	
STORAGE TYPE	VOLUME
FULL HEIGHT	7.66 m <sup>3</sup>
OVERHEAD	1.26 m³
UNDERBENCH	1.68 m <sup>3</sup>
TOTAL	10.61 m <sup>3</sup>
	MIN. 6m <sup>3</sup>

206 - 3BR	
STORAGE TYPE	VOLUME
EXTERNAL	6.01 m <sup>3</sup>
FULL HEIGHT	10.91 m³
OVERHEAD	1.21 m³
UNDERBENCH	2.99 m <sup>3</sup>
TOTAL	21.11 m <sup>3</sup>
WITHIN DWELLING STORAGE	15.10 m <sup>3</sup>

207 - 1BR	
STORAGE TYPE	VOLUME
FULL HEIGHT	7.95 m³
OVERHEAD	0.90 m <sup>s</sup>
UNDERBENCH	1.44 m³
TOTAL	10.28 m <sup>3</sup>
	MIN. 6m <sup>3</sup>

208 (A) - 2BR	
STORAGE TYPE	VOLUME
FULL HEIGHT	11.67 m <sup>3</sup>
OVERHEAD	1.17 m³
UNDERBENCH	1.47 m <sup>3</sup>
TOTAL	14.30 m <sup>3</sup>
	MIN. 9m <sup>3</sup>

209 (A) - 2BR	
STORAGE TYPE	VOLUME
EXTERNAL	6.01 m <sup>3</sup>
FULL HEIGHT	10.02 m³
OVERHEAD	1.35 m <sup>3</sup>
UNDERBENCH	2.65 m <sup>3</sup>
TOTAL	20.02 m <sup>3</sup>
WITHIN DWELLING	14 07 m <sup>3</sup>

STORAGE

## ADVERTISED: PLN24/0477 ADVERTISED: PLN24/0477 This has been made available for the sole purpose of the planning process as set out in the Planning and Environment Act 1987. It must not be used for any other any copyright. Any dissemination, distribution or copyling of this document is strictly prohibited.

#### STORAGE LEVEL 3

301 - 2BR	
STORAGE TYPE	VOLUME
EXTERNAL	6.01 m <sup>3</sup>
FULL HEIGHT	9.22 m <sup>3</sup>
OVERHEAD	1.08 m <sup>3</sup>
UNDERBENCH	1.55 m <sup>3</sup>
TOTAL	17.87 m³
WITHIN DWELLING	11.86 m <sup>3</sup>

302 (A) - 2BR	
STORAGE TYPE	VOLUME
EXTERNAL	6.01 m <sup>3</sup>
FULL HEIGHT	7.00 m <sup>3</sup>
OVERHEAD	1.28 m³
UNDERBENCH	2.36 m <sup>3</sup>
TOTAL	16.65 m <sup>3</sup>
WITHIN DWELLING	10.64 m <sup>3</sup>

STORAGE

303 (A) - 2BR	
STORAGE TYPE	VOLUME
FULL HEIGHT	11.20 m <sup>3</sup>
OVERHEAD	1.18 m³
UNDERBENCH	3.16 m <sup>3</sup>
	15.54 m³
	MIN. 9m3

304 - 3BR				
STORAGE TYPE	VOLUME			
EXTERNAL	6.01 m <sup>3</sup>			
FULL HEIGHT	10.63 m <sup>3</sup>			
OVERHEAD	1.04 m <sup>3</sup>			
UNDERBENCH	2.67 m <sup>3</sup>			
TOTAL	20.34 m <sup>3</sup>			
WITHIN DWELLING STORAGE	14.31 m <sup>3</sup>			

305 (A) - 2BR				
STORAGE TYPE	VOLUME			
EXTERNAL	6.01 m <sup>3</sup>			
FULL HEIGHT	8.40 m <sup>3</sup>			
OVERHEAD	1.38 m <sup>3</sup>			
UNDERBENCH	1.82 m³			
TOTAL	17.61 m³			
WITHIN DWELLING STORAGE	11.52 m <sup>3</sup>			

306 - 2BR			
STORAGE TYPE	VOLUME		
EXTERNAL	6.01 m <sup>3</sup>		
FULL HEIGHT	8.75 m <sup>3</sup>		
OVERHEAD	1.02 m <sup>3</sup>		
UNDERBENCH	1.61 m <sup>3</sup>		
TOTAL	17.39 m³		
WITHIN DWELLING STORAGE	11.76 m <sup>3</sup>		

## **TOWN PLANNING**



DO NOT SCALE DRAWING - REFER ONLY TO WRITTEN
DIMENSIONS

Contractor must verify all dimensions and levels on site prior to
the commencement of any works, ordering & or manufacture
of any materials a Model MT Architects of any discrepancies of any discrepancies.

Drawings to be read in conjunction with current specification.

Drawings to be read to conjunction with current specification.

31 Whyte St, Brighton VIC 3186
e. mtribe@martyntribearchitects.com.au m. 0407544808
A.B.N. 83 083 170 549

RESPONSE TO RFI RESPONSE TO RFI 2

APARTMENT DEVELOPMENT STORAGE AREA CALCULATION TP20 2342 722-724 DONCASTER ROAD, DONCASTER 12.12.2024 Drawn by 1:100 В Scale @ A1



STORAGE













3D VIEW - FOOTPATH ACROSS DONCASTER RD



DO NOT SCALE DRAWING - REFER ONLY TO WRITTEN DIMENSIONS Contractor must verify all dimensions and levels on site prior to the commencement of any works, ordering & or manufacture of any materials. Notify fM Tachitects of any discepancies. Drawings to be read in conjunction with current specification. Drawings 2025 Martyn Tribe Architects


31 Whyte St, Brighton VIC 3186 e. mtibe@martyntribearchitects.com.au m. 0407544808 A.B.N. 83 083 170 549

APARTMENT DEVELOPMENT 3D VIEWS TP21 2342
Project Drawing Drawing No. Project No.

722-724 DONCASTER ROAD, DONCASTER

JL 12.12.2024
Draw by Issued Date

B
Scale @ A1 Status/Revision

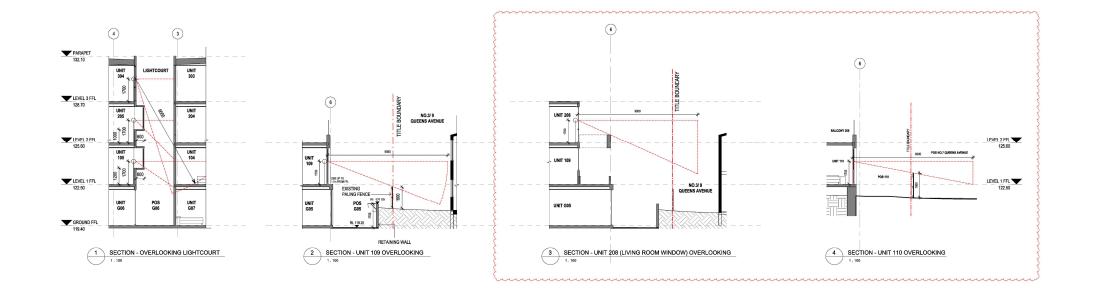



TP22

1:100 Scale @ A1


Drawn by


2342


13.08.2025


В




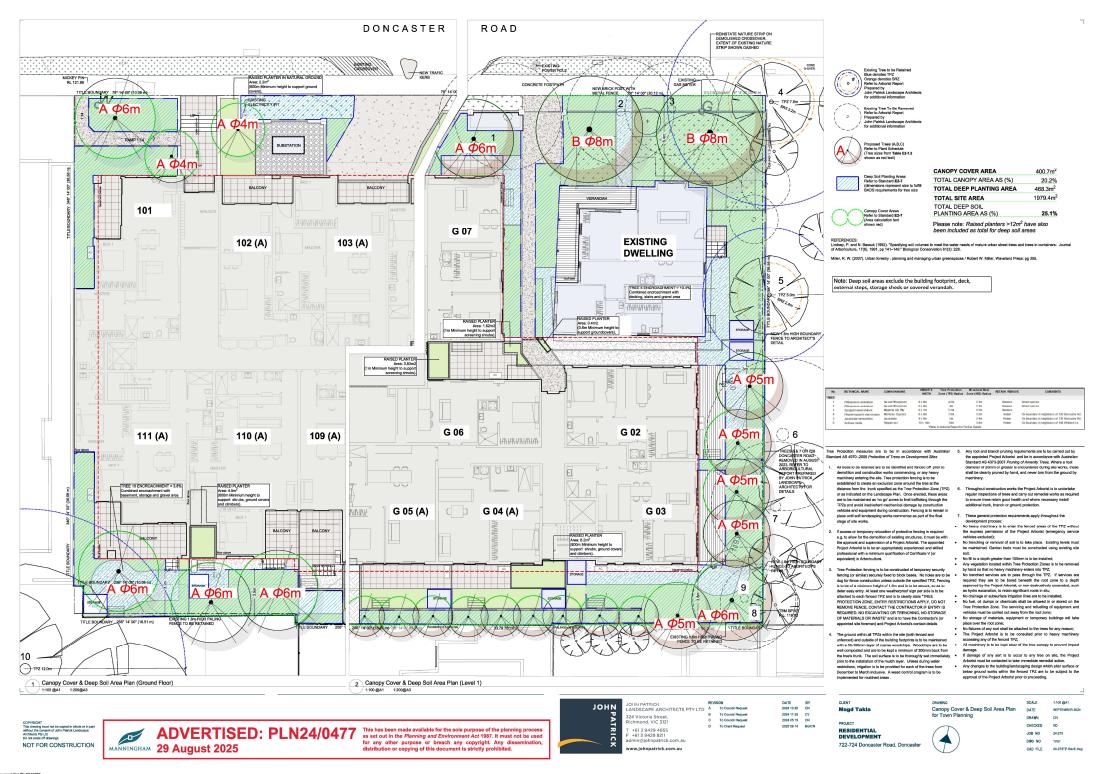


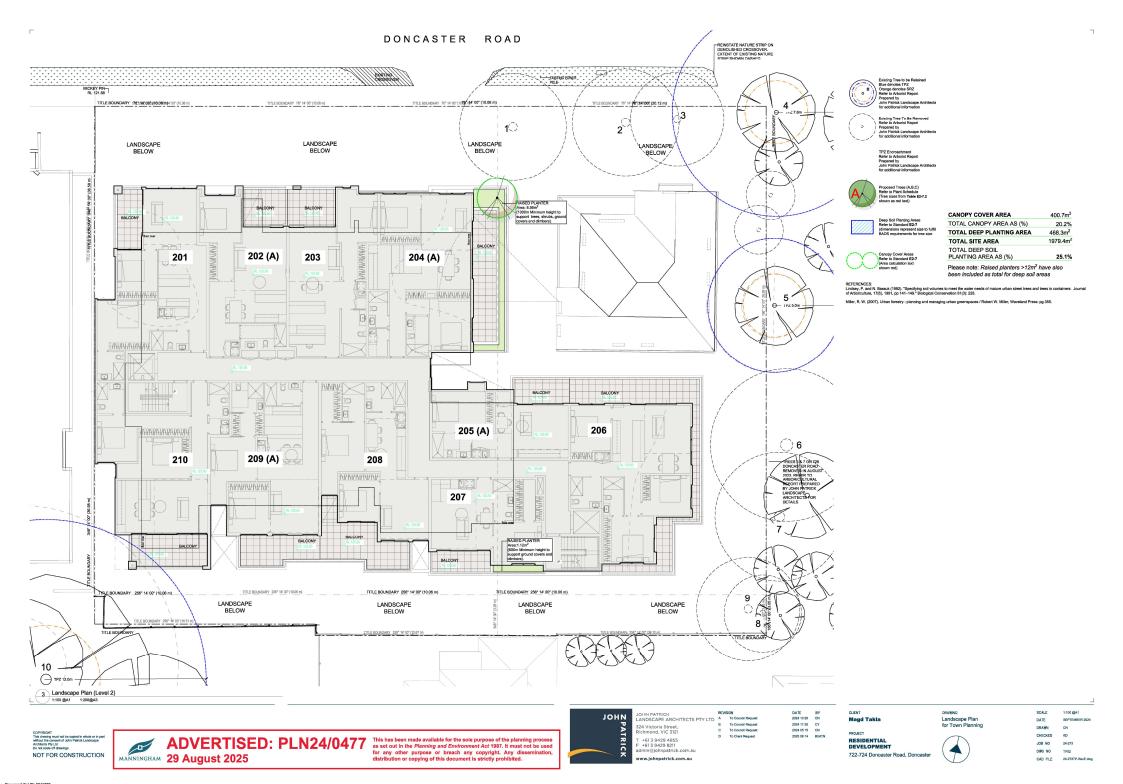


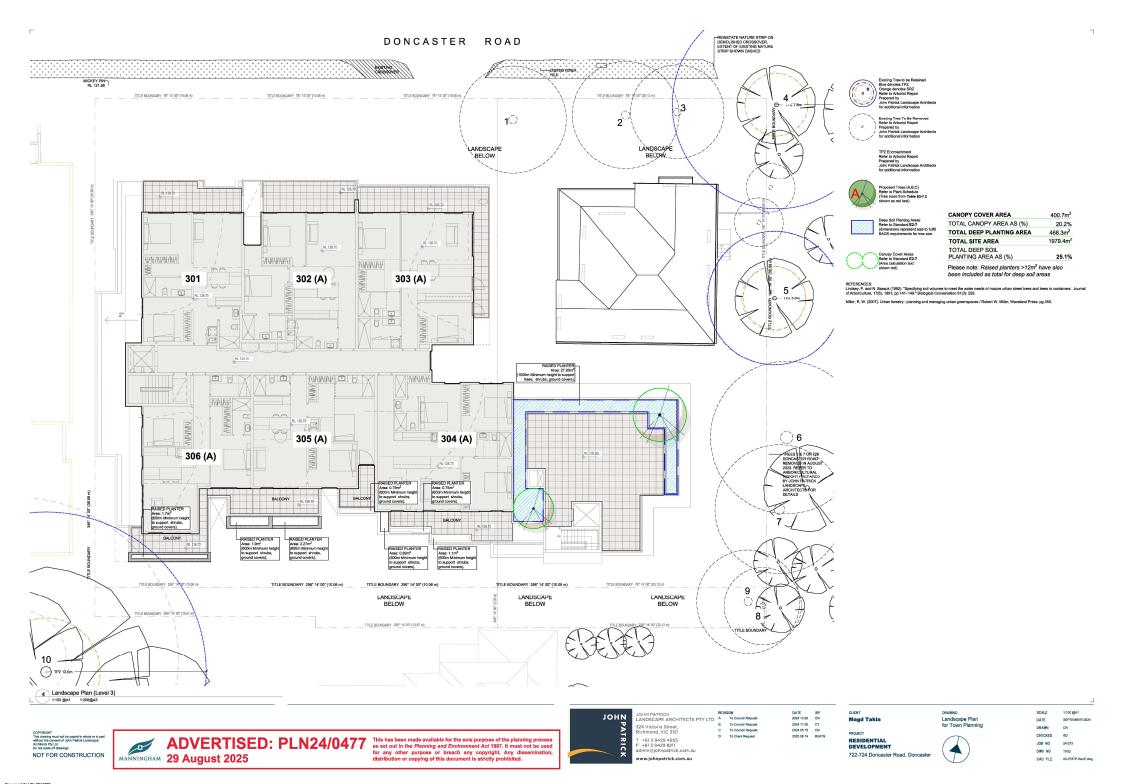

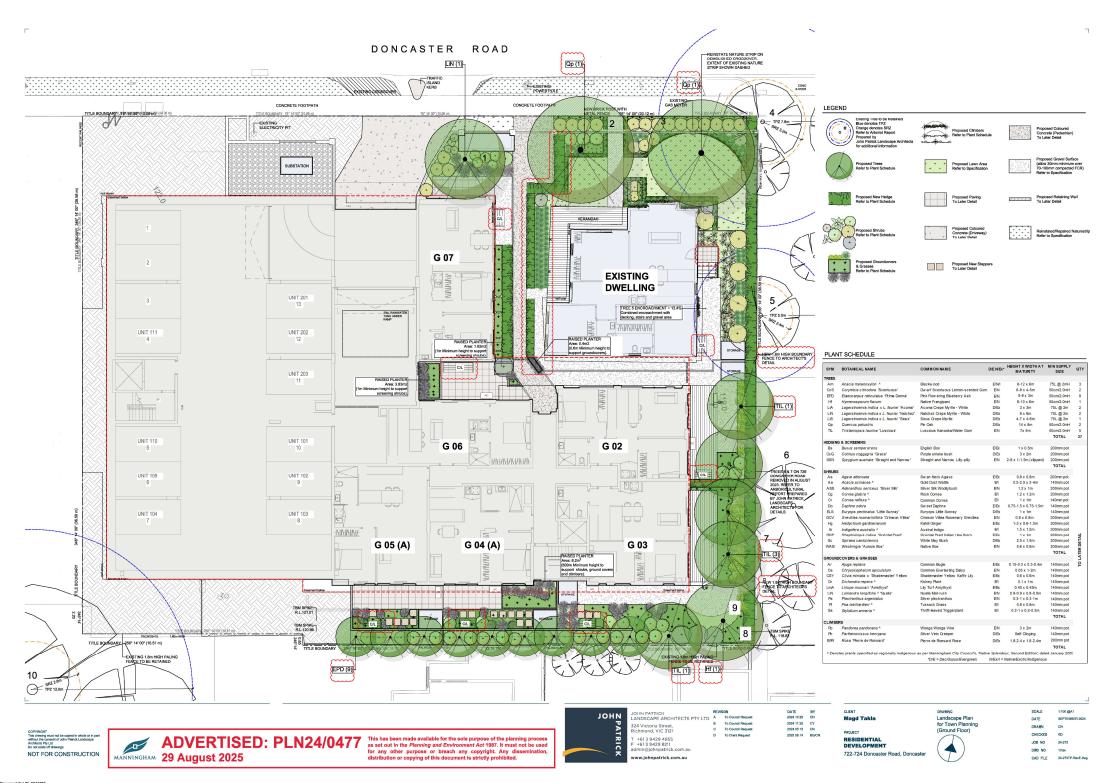

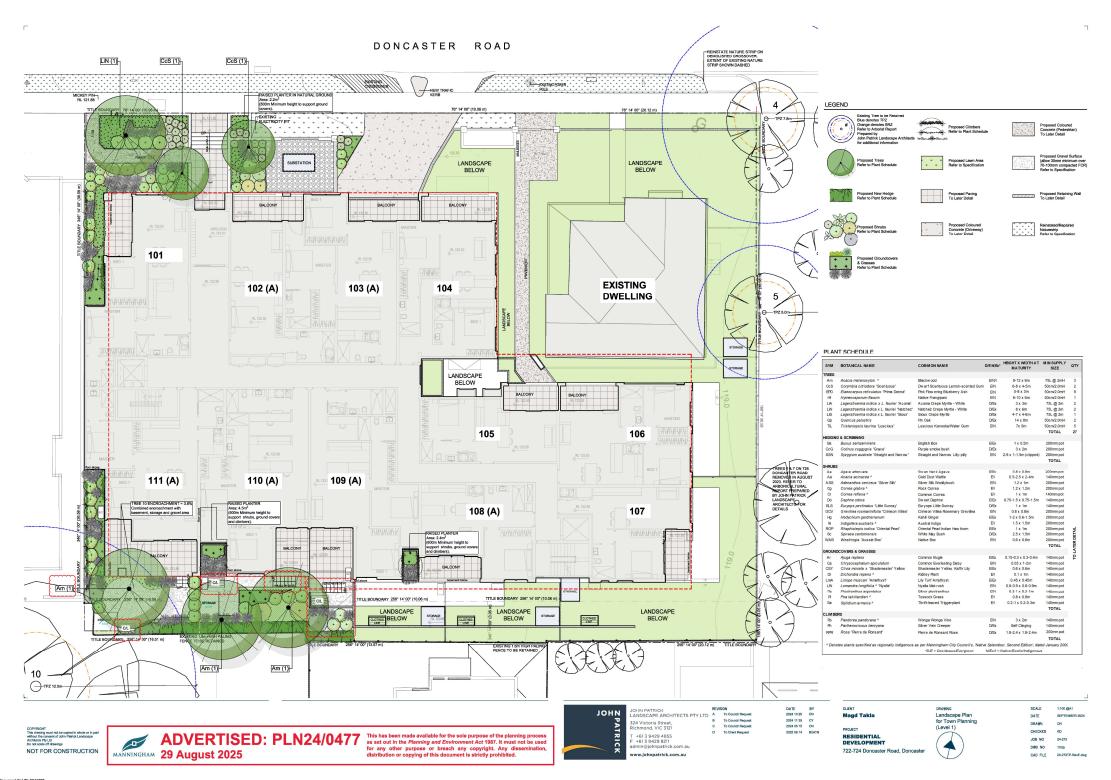

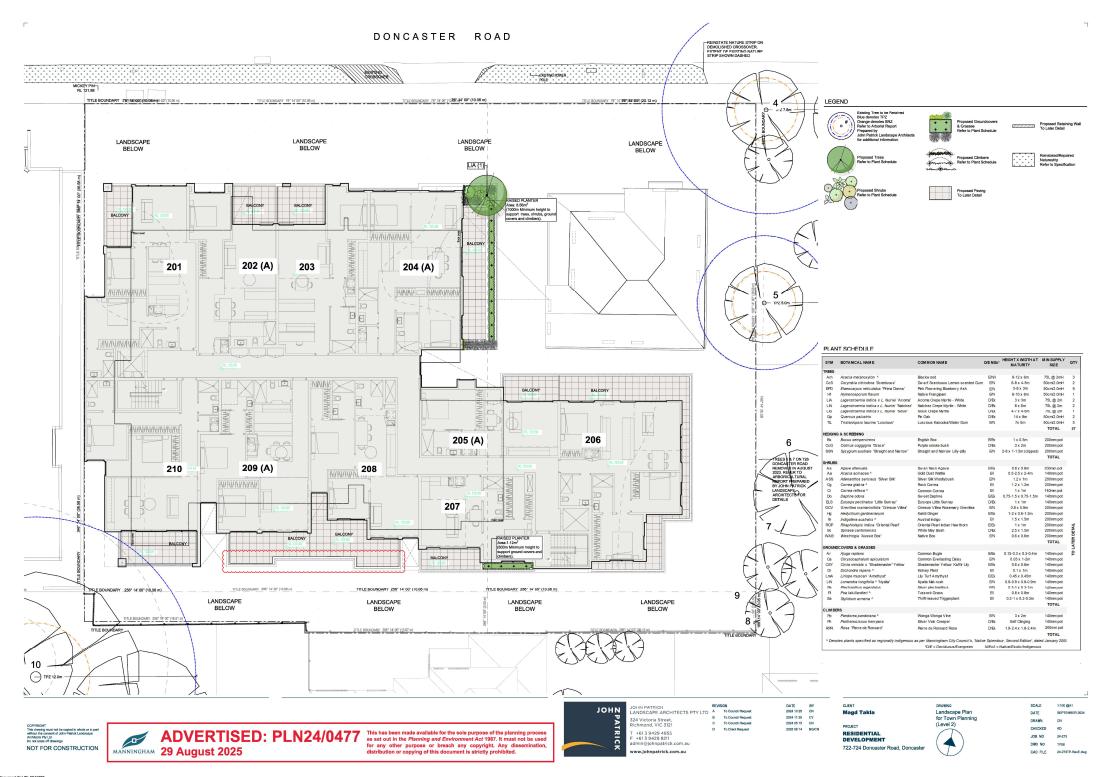

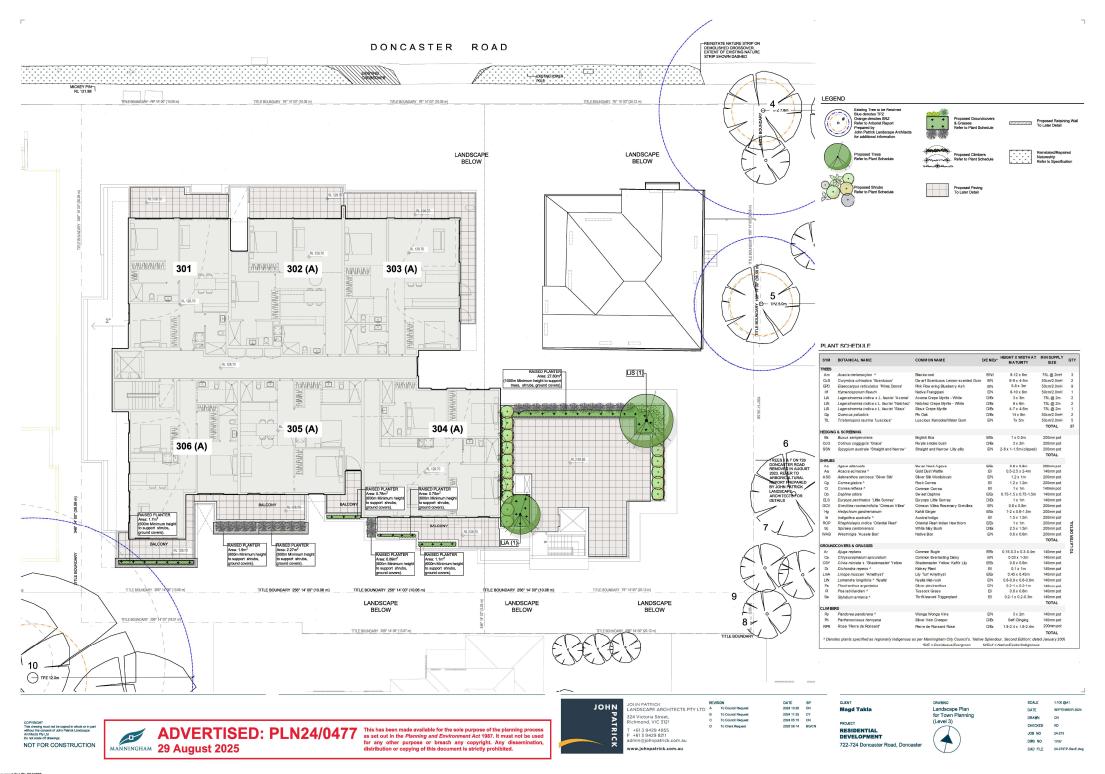

## ADVERTISED: PLN24/0477 This has been made available for the sole purpose of the planning process as set out in the *Planning and Environment Act* 1987. It must not be used for any other purpose or breach any copyright. Any dissemilation, MANNINGHAM 29 August 2025

<u></u>

distribution or copying of this document is strictly prohibited.

## TYPICAL PLANTING DETAILS NOTE: Width of planting hole is: 3 times not ball diameter in highly compacted soil. 2 times not ball diameter minimum in all others. \* Where available planting space is available. All trees to be healthy well grown specimens free of pests and diseases with acceptable root:shoot ratios Trees to be well watered prior to planting Ensure trees are placed so as to match crown of root ball with surrounding surface level. Carefully prune off any girding roots from root ball. Form soil ring berm beyond the circumference of the root ball to provide a watering saucer around the immediate covers of feet. Stake all trees with 2 No. 50x50x1800mm, chisel pointed hardwood stakes driven min. 600mm into ground outside root ball. Tie trees immediately after planting with flexible canvas or rubber ties in a figures. Secure ties to stakes by wrapping around stake and nailing with galvanised nails. NOTE: For slopes greater than 1:8 and if root ball is raised above grade form raised ring of soil & mulch to direct water into root ball. Backfill hole with existing site soil hroken up to a friable texture. Pack ROOT BALL 200 HID SUB-SOK 1 TYPICAL TREE PLANTING DETAIL 50mm-75mm depth approved mulch Inspection pipe with cap as required (to Engineer's detail)

#### SPECIFICATION NOTES

Self Preparation.

Coulted root, concrete spillage and any other material restrictive to part of the properties of the p

were personal and a large and a constraint of the supplies and large and and

Planting
Planting shall be carried out using accepted horticultural practices with all plants conforming to the species, size and quantities indicated on the Landscape Plant and Plant Schedule. Plants shall be thoroughly sosted through previously in water plant in planting and if the purising suicil way dry then the planting hold in water plant in planting said in the purising said in way dry then the planting hold in a size to to be filled with water and allowed to drain completely.

we awroted in morte 8/1988.

No imported top only is to be used within the most zones of tesse to be producted, have presented of existing soil of piluting within these tasks to be some producted. Any presented of existing soil of piluting within these tasks in the second control of the second control of the second of the second control of the second

dry then the planting hole is also to be filled with water and allowed to drain completely.

All plants shall be appropriately interfenced off in the numery. Use plants with the following connectiveness. Large healthy one objective as shown. Turif is to be applied by a specialist grown and is not to be with the following connectiveness. Large healthy one objective as shown. Turif is to be applied by a specialist grown and is not to be with the following connectiveness. Large health possible as shown. Turif is to be applied by a specialist grown and is not to be with the following large and the filled by the plant of the p

Drainage cells are to be provided at the base of the planter and are to be covered with a layer of filter fabric. A drainage cutlet is to be installed in the base of the planter with the floor of the planter sloped towards it. Provide a root another if trees are to be planted in a windy location.

Supply and spread evenly a special lightweight planter mix. (to be advised) Compact evenly in 100mm layers. Avoid differential subsidence and excess compaction and produce a finished surface that is graded evenly and ready for planting. Allow for 50mm layer of specified mutch to top of beds and a finished level 25-50mm layer of specified mutch to top of beds and a finished beneath the mutch right.

community to taken to examine that all selety procedures — exercised occupations health and selety procedures.

Community to taken to execute that all teses to be extended occupations. This elicit is necessary to take the process of the exercised selection of the

Typical drainage connection to storm water (to Engineer's detail)

FLOOR/BASEMENT BELOW

2 TYPICAL LIGHTWEIGHT PLANTER BOX DETAIL
2 Scale 1:20

(to Engineer's detail) Appropriate lightweight soil mix (to further detail) 100mm depth screenings (no fines) to approval Filter fabric (to Engineer's detail) Drainage Cells (to Engineer's detail)

> O I IN PATRICK
> ANDSCAPE ARCHITECTS PTY LTD A To Council Request 324 Victoria Street, Richmond, VIC 3121 +613 9429 4855 +61 3 9429 8211 admin@iohnpatrick.com.au

www.iohnpatrick.com.au

B To Council Request
C To Council Request

DATE BY 2024 10 25 CN 2024 11 25 CY 2024 05 15 CN 2025 08 14 BG/CN

RESIDENTIAL DEVELOPMENT 722-724 Doncaster Road, Doncaster

Magd Takla

Landscane Plan (Specification and Details)

1:100 @A1 DATE SEPTEMBER 2024 DRAWN CHECKED JOB NO 24-273 DWG NO

CAD FILE 24-273TP-RevE.dwg

Document Set ID: 3041280 Version: 2, Version Date: 28/08/2025

NOT FOR CONSTRUCTION

#### LEGISLATIVE REQUIREMENTS

#### PLANNING AND ENVIRONMENT ACT 1987 (THE ACT)

The Planning and Environment Act 1987 is the relevant legislation governing planning in Victoria. The Act identifies subordinate legislation in the form of Planning Schemes to guide future land use and development.

Section 60 of The Planning and Environment Act, requires the Responsible Authority to consider the following before deciding on an application:

- The relevant planning scheme;
- The objectives of planning in Victoria;
- All objections and other submissions which it has received;
- Any decision and comments of a referral authority which it has received; and
- Any significant effects which the responsible authority considers the use or development may have on the environment or which the responsible authority considers the environment may have on the use or development.

Section 61(4) of the Act makes specific reference to covenants. Under Section 61(4) of the Planning & Environment Act 1987 the Responsible Authority must not issue a planning permit that would result in a breach of a registered restrictive covenant.

#### MANNINGHAM PLANNING SCHEME

#### **Planning Scheme Amendments**

Planning Scheme Amendment VC267 was approved on 6 March 2025. This amendment introduced the Townhouse and Low-Rise Code and made several changes to Clause 55 of the Scheme, including the removal of Clause 55.07 (Apartment Developments) and the introduction of Clause 57. Clause 57 applies to residential buildings of four storeys, including this application. As a Section 50 Amendment to the application was lodged after the introduction of VC267, the application must assess Clause 57 – Two or More Dwellings on a Lot and Residential Buildings of Four Storeys.

## Clauses of the Manningham Planning Scheme the Responsible Authority must consider:

- Planning Policy Framework
- Clause 32.07 Residential Growth Zone, Schedule 2
- Clause 32.07 General Residential Zone Schedule 2
- Clause 43.02 Design and Development Overlay, Schedule 8
- Clause 52.06 Car Parking
- Clause 52.29 Land Adjacent to the Principal Road Network
- Clause 52.34 Bicycle Facilities
- Clause 65 Decision Guidelines

#### Zones

Clause 32.07 Residential Growth Zone, Schedule 2

The purpose of the Residential Growth Zone is:

- To implement the Municipal Planning Strategy and the Planning Policy Framework.
- To encourage development that is responsive to the neighbourhood character of the area.

- To encourage a diversity of housing types and housing growth particularly in locations offering good access to services and transport.
- To allow educational, recreational, religious, community and a limited range of other non-residential uses to serve local community needs in appropriate locations.

Planning Permit is required to construct two or more dwellings on a lot and to construct a front fence within 3 metres of a street.

A development of four storeys, excluding a basement, must meet the requirements of Clause 57.

A building must not be constructed for use as a dwelling, small second dwelling or a residential building that exceeds the maximum building height specified in a schedule to this zone.

Schedule 2 to the Residential Growth Zone does not specify a maximum building height requirement for a dwelling or residential building.

If no maximum building height is specified in a schedule to this zone, the building height should not exceed 13.5 metres.

A building may exceed the maximum building height by up to 1 metre if the slope of the natural ground level, measured at any cross section of the site of the building wider than 8 metres, is greater than 2.5 degrees.

#### Clause 32.08 General Residential Zone, Schedule 2

The purpose of the General Residential Zone is:

- To implement the Municipal Planning Strategy and the Planning Policy Framework.
- To encourage development that is responsive to the neighbourhood character of the area.
- To encourage a diversity of housing types and housing growth particularly in locations offering good access to services and transport.
- To allow educational, recreational, religious, community and a limited range of other non residential uses to serve local community needs in appropriate locations.

An application to construct or extend a dwelling, small second dwelling or residential building on a lot more than 650squate metres must provide a minimum garden area of 35% of site area.

Planning Permit is required to construct two or more dwellings on a lot and to construct a front fence within 3 metres of a street.

A development of four storeys, excluding a basement, must meet the requirements of Clause 57.

A building must not be constructed for use as a dwelling, small second dwelling or a residential building that:

- exceeds the maximum building height specified in a schedule to this zone; or
- contains more than the maximum number of storeys specified in a schedule to this zone.

If no maximum building height or maximum number of storeys is specified in a schedule to this zone:

- the building height must not exceed 11 metres; and
- the building must contain no more than 3 storeys at any point.

A building may exceed the maximum building height by up to 1 metre if the slope of the natural ground level, measured at any cross section of the site of the building wider than 8 metres, is greater than 2.5 degrees.

#### **Overlays**

#### Clause 43.02 Schedule 8 to the Design and Development Overlay

The design objectives are as follows:

- To increase residential densities and provide a range of housing types around activity centres and along main roads.
- To encourage development that is contemporary in design that includes an articulated built form and incorporates a range of visually interesting building materials and façade treatments.
- To support three storey, 'apartment style', developments within the Main Road sub precinct and in sub-precinct A, where the minimum land size can be achieved.
- To support two storey townhouse style dwellings with a higher yield within sub precinct B and sub-precinct A, where the minimum land size cannot be achieved.
- To ensure new development is well articulated and upper storey elements are not unduly bulky or visually intrusive, taking into account the preferred neighbourhood character.
- To encourage spacing between developments to minimise a continuous building line when viewed from a street.
- To ensure the design and siting of dwellings have regard to the future development opportunities and future amenity of adjoining properties.
- To ensure developments of two or more storeys are sufficiently stepped down at the perimeter of the Main Road sub-precinct to provide an appropriate and attractive interface to sub-precinct A or B, or other adjoining zone.
- Higher developments on the perimeter of sub-precinct A must be designed so that the height and form are sufficiently stepped down, so that the scale and form complement the interface of sub-precinct B or other adjoining zone.
- To ensure overlooking into adjoining properties is minimised.
- To ensure the design of carports and garages complement the design of the building.
- To ensure the design of basement and undercroft car parks complement the design of the building, eliminates unsightly projections of basement walls above natural ground level and are sited to allow for effective screen planting.
- To create a boulevard effect along Doncaster Road and Manningham Road by planting trees within the front setback that are consistent with the street trees.
- To encourage landscaping around buildings to enhance separation between buildings and soften built form

#### Permit Requirement

- A permit is required to construct or carry out works.
- A permit is required to construct or extend a front fence within 3 metres of a street, if the fence is associated with 2 or more dwellings on a lot or a residential building.

#### Building Height & Setbacks

- Any building or works must comply with the requirements set out in Table 1 and 2 of this Schedule.
- A permit cannot be granted to vary the condition regarding the minimum land size and configuration specified in Table 2 to this Schedule.

- For the purposes of this Schedule, the Maximum Building Height does not include building services, lift over-runs and roof mounted equipment, including screening devices.
- For the purposes of this Schedule, balconies, terraces, and verandahs may encroach within the Street Setback by a maximum of 2.0m, but must not extend along the width of the building.
  Table 1 to Schedule 8

Table 1 to	Schedule 8		
Sub- Precinct	Maximum Building Height	Condition regarding minimum land size.	Street Setback
DDO8-1 (Main Road) Sub- precinct	11 metres provided the condition regarding minimum land size is met. If the condition is not met, the maximum height is 9 metres, unless the slope of the natural ground level at any cross section wider than eight metres of the site of the building is 2.5 degrees or more, in which case the maximum height must not exceed 10 metres.	1,800 square metres must be all in the same sub-precinct. Where the land comprises more than one lot, the lots must be consective lots which are side by side and have a shared frontage.	For one dwelling on a lot:  Minimum front street setback is the distance specified in Clause 54.03-1 or 6 metres, whichever is the lesser.  Minimum side street setback is the distance specified in Clause 54.03-1.  For two or more dwellings on a lot or a residential building:  Minimum front street setback is the distance specified in Clause 55.03-1 or 6 metres, whichever is the lesser.  Minimum side street setback is the distance specified in Clause 55.03-1.

Table 2 to Schedule 8

Table 2 to Schedule 8						
Sub- Precinct	Maximum Building Height	Condition regarding minimum land size.	Street Setback			
DDO8-2 (Sub- precinct A)	11 metres provided the condition regarding minimum land size is met. If the condition is not met, the maximum height is 9 metres, unless the slope of the natural ground level at any cross section wider than eight metres of the site of the building is 2.5 degrees or more, in which case the maximum height must not exceed 10 metres.	1,800 square metres must be all in the same sub-precinct. Where the land comprises more than one lot, the lots must be consecutive lots which are side by side and have a shared frontage.	For one dwelling on a lot:  Minimum front street setback is the distance specified in Clause 54.03-1 or 6 metres, whichever is the lesser  Minimum side street setback is the distance specified in Clause 54.03-1  For two or more dwellings on a lot or a residential building:  Minimum front street setback is the distance specified in Clause 55.03-1 or 6 metres, whichever is the lesser  Minimum side street setback is the distance specified in Clause 55.03-1 or 6 metres, whichever is the lesser  Minimum side street setback is the distance specified in Clause 55.03-1			

## Clause 43.01 Heritage Overlay

The purpose of the overlay is:

- To implement the Municipal Planning Strategy and the Planning Policy Framework.
- To conserve and enhance heritage places of natural or cultural significance.
- To conserve and enhance those elements which contribute to the significance of heritage places.
- To ensure that development does not adversely affect the significance of heritage places.
- To conserve specified heritage places by allowing a use that would otherwise be prohibited if this will demonstrably assist with the conservation of the significance of the heritage place.

#### A permit is required to:

- Demolish or remove a building.
- Construct a building or construct or carry out works including:
  - o A fence, if the fence is visible from a street (other than a lane) or public park.
  - A deck, including a deck to a dwelling with a finished floor level not more than 800mm above ground level, if the deck is visible from a street (other than a lane) or public park
- Externally paint a building if the schedule to this overlay specifies the heritage place as one where external paint controls apply.

PS map ref	Heritage place	External paint controls apply?	Internal alteration controls apply?	Tree controls apply?	Solar energy system controls apply?	Outbuildings or fences not exempt under Clause 43.01-4	Included on the Victorian Heritage Register under the Heritage Act 2017?	Prohibited uses permitted?	Aboriginal heritage place?
HO215	House – 724 Doncaster Road, Doncaster	Yes	No	No	Yes	No	No	No	No

#### **Planning Policy Framework**

The relevant sections of the Planning Policy Framework are as follows:

<u>Clause 15.01-1L (Safer neighbourhoods - Manningham)</u> seeks to facilitate buildings, subdivisions, street layout, car parks and public open space that are safe.

Strategies towards achieving this are identified as follows:

- Design buildings to provide informal surveillance of adjacent open space.
- Create private and public open space areas that are accessible, functional and safe.
- Locate playgrounds in areas that are clearly visible to guardians and residents and avoid locating playgrounds behind buildings or in secluded areas.
- Design landscaping of public spaces to provide clear and unobstructed views.
- Utilise landscaping with low shrubs or ground covers to increase effectiveness of natural surveillance.
- Avoid the planting of trees and shrubs with dense foliage near pathways.
- Avoid rear lane ways and pedestrian tunnels unless adequate surveillance opportunities for these areas can be incorporated into the design.
- Locate automatic teller machines where there are clear sightlines in the public realm.
- Design and locate buildings, including car parks, to promote public safety by:
  - o Maximising visibility and sightlines to and from public and communal spaces.
  - o Avoiding hidden car spaces, blind corners and areas of potential entrapment.
- Design pedestrian entrances to be clearly visible from streets and public areas, to provide shelter and to provide a transitional space between the public and private realm.
- Ensure development and landscaping surrounding open car parks provide casual surveillance opportunities.
- Provide clear directional signage within car parks and at entry and exit points.
- Encourage open and transparent fences along street frontages and public areas to allow surveillance and visibility.
- Design buildings to discourage external roof access.
- Encourage the use measures to manage graffiti and vandalism.
- Avoid enclosing public spaces that adjoin private property.
- Ensure streetscapes:
  - o Are attractive.
  - o Clearly define areas for pedestrian and vehicle movement.
- Provide natural surveillance and visibility for pedestrians, drivers and occupants of adjacent land

<u>Clause 15.01-1L-03 (Design of development adjacent to heritage places)</u> seeks to minimise the impact on heritage places as a result of changes to adjoining land uses and development.

#### Strategies:

• Design development adjacent to heritage places in the schedule to the Heritage Overlay and schedule 3 and 5 to the Vegetation Protection Overlay to respond

positively to the bulk, setback, materials, colour scheme and form of the heritage place.

<u>Clause 15.01-2S (Building Design)</u> seeks to achieve building design and siting outcomes that contribute positively to the local context, enhance the public realm and support environmentally sustainable development.

Strategies towards achieving this are identified as follows:

- Ensure a comprehensive site analysis forms the starting point of the design process and provides the basis for the consideration of height, scale, massing and energy performance of new development.
- Ensure development responds and contributes to the strategic and cultural context of its location.
- Minimise the detrimental impact of development on neighbouring properties, the public realm and the natural environment.
- Improve the energy performance of buildings through siting and design measures that encourage:
  - o Passive design responses that minimise the need for heating, cooling and lighting.
  - o On-site renewable energy generation and storage technology.
  - o Use of low embodied energy materials.
- Ensure the layout and design of development supports resource recovery, including separation, storage and collection of waste, mixed recycling, glass, organics and ewaste.
- Encourage use of recycled and reusable materials in building construction and undertake adaptive reuse of buildings, where practical.
- Encourage water efficiency and the use of rainwater, stormwater and recycled water.
   Minimise stormwater discharge through site layout and landscaping measures that support on-site infiltration and stormwater reuse.
- Ensure the form, scale, and appearance of development enhances the function and amenity of the public realm.
- Ensure buildings and their interface with the public realm support personal safety, perceptions of safety and property security.
- Ensure development is designed to protect and enhance valued landmarks, views and vistas.
- Ensure development considers and responds to transport movement networks and provides safe access and egress for pedestrians, cyclists and vehicles.
- Encourage development to retain existing vegetation.
- Ensure development provides landscaping that responds to its site context, enhances the built form, creates safe and attractive spaces and supports cooling and greening of urban areas.

<u>Clause 15.01-2L-01 (Environmentally Sustainable development – Manningham)</u> seeks to achieve best practice in environmentally sustainable development from the design stage through to construction and operation.

#### Strategies

- Facilitate development that minimises environmental impacts.
- Encourage environmentally sustainable development that:
  - o Is consistent with the type and scale of the development.
  - o Responds to site opportunities and constraints.
- Adopts best practice through a combination of methods, processes and locally available technology that demonstrably minimise environmental impacts.

#### Energy performance

- Reduce both energy use and energy peak demand through design measures such as:
  - o Building orientation.
  - o Shading to glazed surfaces.
  - o Optimising glazing to exposed surfaces.
  - o Inclusion of or space allocation for renewable technologies.

#### Integrated water management

- Reduce total operating potable water use through appropriate design measures such as water efficient fixtures, appliances, equipment, irrigation and landscaping.
- Encourage the appropriate use of alternative water (including greywater, rainwater and stormwater).
- Incorporate best practice water sensitive urban design to improve the quality of stormwater runoff and reduce impacts on water systems and water bodies.

#### Indoor environment quality

- Achieve a healthy indoor environment quality, including thermal comfort and access to fresh air and daylight, prioritising passive design over mechanical heating, ventilation, cooling and lighting.
- Reduce indoor air pollutants by encouraging use of low-toxicity materials.
- Minimise noise levels and noise transfer within and between buildings and associated external areas.

#### Transport

- Design development to promote the use of walking, cycling and public transport, in that order; and minimise car dependency.
- Promote the use of low emissions vehicle technologies and supporting infrastructure.

#### Waste management

- Promote waste avoidance, reuse and recycling during the design, construction and operation stages of development.
- Encourage use of durable and reusable building materials.
- Ensure sufficient space is allocated for future change in waste management needs, including (where possible) composting and green waste facilities.

#### Urban ecology

- Protect and enhance biodiversity by incorporating natural habitats and planting indigenous vegetation.
- Reduce urban heat island effects through building design, landscape design, water sensitive urban design and the • retention and provision of canopy and significant trees.
- Encourage the provision of space for productive gardens, particularly in larger residential developments.

<u>Clause 15.01-4S (Healthy neighbourhoods)</u> policy objective seeks to create neighbourhoods that foster healthy and active living and community wellbeing.

#### Strategies towards achieving this are identified as follows:

- Design neighbourhoods that foster community interaction and make it easy for people of all ages and abilities to live healthy lifestyles and engage in regular physical activity by providing:
  - Connected, safe, pleasant and attractive walking and cycling networks that enable and promote walking and cycling as a part of daily life.

- o Streets with direct, safe and convenient access to destinations.
- o Conveniently located public spaces for active recreation and leisure.
- o Accessibly located public transport stops.
- Amenities and protection to support physical activity in all weather conditions.

<u>Clause 15.01-5S (Neighbourhood character)</u> policy objective is to recognise, support and protect neighbourhood character, cultural identity, and sense of place.

Strategies towards achieving this are identified as follows:

- Support development that respects the existing neighbourhood character or contributes to a preferred neighbourhood character.
- Ensure the preferred neighbourhood character is consistent with medium and higher density housing outcomes in areas identified for increased housing.
- Ensure development responds to its context and reinforces a sense of place and the valued features and characteristics of the local environment and place by respecting the:
  - Pattern of local urban structure and subdivision. o Underlying natural landscape character and significant vegetation.
  - Neighbourhood character values and built form that reflect community identity.

#### Clause 15.01-5-01L (Landscaping Manningham) policy strategies are as follows;

- Provide landscaping to soften built form and the appearance of large areas of car parking, accessways and development.
- Incorporate indigenous planting and canopy trees.
- Provide setbacks to enable the retention of canopy trees and landscape treatments along road frontages roadside boundaries and interfaces with adjoining sites to complement the boulevard theme and character of the area.
- Retain existing vegetation and canopy trees along road frontages.
- Retain native vegetation where possible or, incorporate new native vegetation into landscaping.
- Support landscaping that provides visual interest to commercial uses and carparking areas to the surrounding area

#### Clause 15.01-5L-02 (Neighbourhood character)

This policy outlines the division of Manningham into four Residential Character Precincts. The precincts seek to channel increased housing densities around activity centres and main roads where facilities and services are available. In areas which are removed from these facilities a lower intensity of development is encouraged. A low residential density is also encouraged in areas that have identified environmental or landscape features.

The site is within Precinct 2 – Residential Areas Surrounding Activity Centres and Along Main Roads.

This precinct applies to the areas surrounding activity centres and along main roads.

The Precinct 2 objective is to promote substantial change that is high quality, contemporary and designed to provide a transition between sub precincts in Precinct 2.

Precinct 2 strategies are as follows:

- Provide for contemporary architecture.
- Encourage use of varied and durable building materials in building facades that provide visual interest.

- Provide a graduated building scale and form from side and rear boundaries.
   Incorporate a landscape treatment that enhances the overall appearance of the development and any adjacent main road.
- Integrate car parking into the design of buildings and landform.
- Encourage the built form fronting Doncaster Road at the former Eastern Golf Course (Tullamore) to be of a scale that provides an appropriate transition to Doncaster Hill Major Activity Centre.
- Support development as follows:
  - Apartment-style developments along main roads and on larger, consolidated lots in DDO8-1 - Sub-Precinct Main Road.
  - Apartment-style development of two-storeys, or three-storeys on larger consolidated lots, in DDO8-2 - Sub-Precinct A.
  - Low-rise development of one and two-storeys in DDO8-3 Sub-Precinct B.

The site is located within the Main Road Sub-Precinct.

<u>Clause 15.03 -1s (Heritage conservation)</u> seeks to ensure. the conservation of places of heritage significance.

#### Strategies are as follows;

- Identify, assess and document places of natural and cultural heritage significance as a basis for their inclusion in the planning scheme.
- Provide for the protection of natural heritage sites and man-made resources.
- Provide for the conservation and enhancement of those places that are of aesthetic, archaeological, architectural, cultural, scientific or social significance.
- Encourage appropriate development that respects places with identified heritage values.
- Retain those elements that contribute to the importance of the heritage place.
- Encourage the conservation and restoration of contributory elements of a heritage place.
- Ensure an appropriate setting and context for heritage places is maintained or enhanced.
- Support adaptive reuse of heritage buildings where their use has become redundant.
- Consider whether it is appropriate to require the restoration or reconstruction of a
  heritage building in a Heritage Overlay that has been unlawfully or unintentionally
  demolished in order to retain or interpret the cultural heritage significance of the
  building, streetscape or area.

#### Clause 15.03-1L (Heritage Conservation – Manningham)

Relevant strategies of the policy are as follows:

Demolition or removal of buildings, structures or features

- Discourage the partial demolition, complete demolition or removal of any heritage place.
- Support partial or complete demolition in limited circumstances, where:
  - o Retention is demonstrated to be unsafe or unsound.
  - o The heritage place is beyond reasonable repair.
  - o The demolition relates to non-original fabric.
  - The heritage place is demonstrated to be non-contributory.
- Avoid demolition of a heritage place until replacement buildings or works have been approved.

#### New buildings and works strategies

- Encourage the retention of heritage fabric in development proposals.
- Avoid the design of new buildings that mimic or copy the heritage place.

• Design buildings to complement the original fabric and design of the heritage place or precinct in terms of bulk, style, materials, setbacks, colour scheme and form.

#### Alterations and additions strategies

- Support alterations to the rear of buildings where view lines of those works from the streetscape or heritage precinct are minimised.
- Avoid alterations that negatively impact on the architectural and aesthetic contribution of the heritage place to the streetscape.
- Design and locate external and internal alterations to preserve, restore or reconstruct the original features and forms of the heritage place.
- Respect the nature and colour of the original fabric of the building when selecting new materials.

#### Vegetation strategies

- Avoid the removal or lopping of vegetation that makes a significant contribution to the setting and value of a heritage place unless part or all of the vegetation is dead, dying or presents an immediate risk.
- Protect older exotic species with landscape character or heritage values.

<u>Clause 16.01-1S (Housing Supply)</u> policy objective is to facilitate well-located, integrated and diverse housing that meets community needs.

Strategies towards achieving this are identified as follows:

- Ensure that an appropriate quantity, quality and type of housing is provided, including aged care facilities and other housing suitable for older people, supported accommodation for people with disability, rooming houses, student accommodation and social housing.
- Increase the proportion of housing in designated locations in established urban areas (including under-utilised urban land) and reduce the share of new dwellings in greenfield, fringe and dispersed development areas.
- Encourage higher density housing development on sites that are well located in relation to jobs, services and public transport.
- Identify opportunities for increased residential densities to help consolidate urban areas.
- Facilitate diverse housing that offers choice and meets changing household needs by widening housing diversity through a mix of housing types.
- Encourage the development of well-designed housing that:
  - o Provides a high level of internal and external amenity.
  - o Incorporates universal design and adaptable internal dwelling design.
- Support opportunities for a range of income groups to choose housing in well-serviced locations.
- Plan for growth areas to provide for a mix of housing types through a variety of lot sizes, including higher housing densities in and around activity centres

<u>Clause 19.03-3L (Wastewater, drainage and stormwater management – Manningham)</u> policy objective is to provide safe and efficient wastewater, drainage and stormwater management systems.

Strategies towards achieving this are identified as follows:

- Ensure that any land use or development that may increase water runoff from a site either:
  - Detains stormwater on site.
  - Undertakes or assists with off-site works to maintain or increase drainage capacity.

- Promote the on-site detention, absorption of stormwater through:
  - The use of permeable paving, pebble paths, lawns and gardens. Capture and reuse functions within detention systems.
- Encourage natural biological filtration systems in areas of high sediment or nutrient runoff, including roadside developments and subdivisions.
- Support the use of pollutant traps to prevent garbage entering the waterways.
- Ensure development connects to mains water.
- Encourage connection to sewer where available and within reasonable proximity.

#### **Particular Provisions**

#### Clause 52.06 Car Parking

Pursuant to Clause 52.06-5, car parking is required to be provided at the following rates:

- 1 space for 1 and 2 bedroom dwellings.
- 2 spaces for 3 or more bedroom dwellings.

No residential visitor car parking spaces are required for any part of the land identified as being within the Principal Public Transport Network Area.

Clause 52.06-9 outlines various design standards for parking areas that should be achieved.

#### Clause 52.29 Land Adjacent to The Principal Road Network

This clause applies to land adjacent to a road in the Transport Zone 2 or land in a Public Acquisition Overlay if a transport manager (other than a municipal council) is the acquiring authority, and the purpose of the acquisition is for a road.

A permit is required to create or alter access to a road in a Transport Zone 2.

An application must be referred under section 55 of the Act to the person or body specified as the referral authority in clause 66.03.

#### Clause 52.34 Bicycle Facilities

Pursuant to Clause 52.34-5, bicycle facilities are required to be provided at the following rates:

- In developments of four or more storeys, 1 resident bicycle facility to each 5 dwellings
- In developments of four or more storeys, 1visitor bicycle facility to each 10 dwellings

#### **General Provisions**

#### Clause 65 Decision Guidelines

This clause outlines that before deciding on an application, the responsible authority must consider, as appropriate:

- The Municipal Planning Strategy and the Planning Policy Framework.
- The purpose of the zone, overlay or other provision.
- Any matter required to be considered in the zone, overlay or other provision.
- The orderly planning of the area.
- The effect on the amenity of the area.
- Whether the proposed development is designed to maintain or improve the quality of stormwater within and exiting the site.

•	The degree of flood, erosion or fire hazard associated with the location of the land and the use, development or management of the land so as to minimise any such hazard.